



SANCTION IDP MAP (SCALE: NTS)

	11. 29.	734 336	
,	20		1
			1 8
	29.0	93 — — —	4
25	2		
11.652	•		
		28.453	7.052
		3	Ri

REQUIRED NO. OF PARKING SPACES PROPOSED PARKING SPACES

2.0SQ.M


250 X 10%=25 SQ.M.

150X 10%=15 SQ.M.

NO. OF CAR NO. OF TWO WHEELER NO. OF CAR NO. OF TWO WHEELE

**OPEN SPACE** (SCALE 1:250)

BUILT UP AREA ( BLDG N			
FLOOR	BUA IN SQ.M.		
FIRST FLOOR	504.96		
SECOND FLOOR	504.96		
THIRD FLOOR	504.96		
FOURTH FLOOR	504.96		
FIFTH FLOOR	504.96		
TOTAL	2524.800		
BUILT UP AREA (BUILDING	and the state of t		
FLOOR	BUA IN SQ.M.		
BUA GR FL - A	40.01		
BUA GR FL -B	28.99		
BUA GR FL -C	28.75		
FIRST FLOOR	605.57		
SECOND FLOOR	619.74		
THIRD FLOOR	605.57		
FOURTH FLOOR	619.74		
TOTAL	2548.37		
TOTAL BUILT			
BUILDING	BUA IN SQ.M.		
1	2524.800		
2	2548.370		

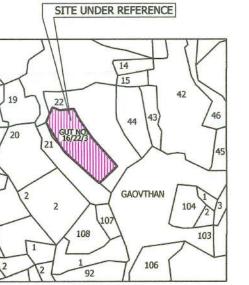

VILLAGE MAP (SCALE 1 : 5000)

SHEET NO.

TPS FINAL PLOT NO 37 AREA CALCULATION

1 0.5 X 10.050 X 0.478 = 2.402

2 0.5 X 10.05 X 4.577 = 22.999

3 0.5 X 26.781 X 8.038 = 107.633

4 0.5 X 34.798 X 14.32 = 249.154

5 0.5 X 39.781 X 5.363 = 106.673

6 0.5 X 11.925 X 39.781 = 237.194 7 0.5 X 36.357 X 9.056 = 164.624 8 0.5 X 36.357 X 12.963 = 235.648 9 0.5 X 36.868 X 13.936 = 256.896 10 0.5 X 36.868 X 9.072 = 167.233 11 0.5 X 34.536 X 10.349 = 178.707

12 0.5 X 33.947 X 8.437 = 143.205 13 0.5 X 39.035 X 4.435 = 86.560 14 0.5 X 39.035 X 10.999 = 214.673

16 0.5 X 35.661 X 3.361 = 59.928

17 0.5 X 47.353 X 23.505 = 556.516 18 0.5 X 47.353 X 21.382 = 506.251

Site Plan On

White Print

15 0.5 X 35.93 X 1.208 =

TOTAL AREA OF PLOT

Legend :-

Sr.No. Item

01. Plot Line

04. Building Line

06. TILR Map

07. Car Parking

09. Future tree

Open space

05. FSI /Built up Line

02. Proposed TPS-5 Road

03. Internal Layout Road

08. Two Wheeler Parking

11. PLOT BOUNDRY AS PER ACC IN 2021 AREA=3318 SQ.M

12. FINAL APPROVED PLOT BY TPS SECTION NAINA

TPS F P NO 37 CALCULATION BY TRIANGULATION

NOTES \* ALL DIMENSIONS ARE IN METERS.

\* INTERNAL WALL THICKNESS 0.10 MM.

\* EXTERNAL WALL THICKNESS 0.15 MM.

AREA = 3318.00 SQ.M.

THIS PLANS APPROVED SUBJECT TO THE CONDITIONS MENTIONED IN COMMENCEMENT CERTIFICATE ISSUED BY THIS OFFICE BEARING CERTIFICATE NO CIDCO/NAINA/Panvel/Vihighar/BP-00387/ACC/2024/0527 Dated 04 Jul 2024

L.No.	-	PARTICU	LARS			AREA (Sq. M.								
		a of survey no.				2000.000								
	_	Area of Plot (as per 7/12) and NA order Area of Plot as per TILR (by triangulation	n mathad	at true coal-1		3800.000 3878.018								
1	_	Area of Plot as per TILR (by triangulation  Area of Plot as per Physical Survey	method	actrue scare)		3912.526								
		Final area of plot as per Physical Survey				3318.000								
		Area of plot considered (least of (a), (b),	(c) and (d))		-	3318.000								
	$\overline{}$	uction for	(c) and (d))			3310.000								
		Existing road (ROW)				0.000								
_	-	Proposed widening of existing road												
2		Proposed road as per TILR(IDP/TPS-5 ROAD RESERVATION )												
	d	Area under reservation, if any				0.000								
		al (a+b+c+d)			The second secon	482.000								
3	Bala	nce area of Plot (1-2)/Area of Plot No-37	of TPS-5			3318.000								
4		enity Space, if any				0.00								
	-	Required Amenity Space (5% of 3)												
_	_	Proposed Amenity Space				0.00								
6	_	Plot area (3-4b)				3318.00								
6	-	ecreational Open Space (Ifapplicable)  Required RG/Open Space (10% of 5 )												
	b	Proposed RG/open Space				331.800 339.025								
	-	al Entitlement of FSI in the proposal				333.023								
	-	Base FSI permissible				0.70								
	_	Premissible FSI with payment of premimum (0.3)												
		TDR/In-situ FSI	12.2/			0.30								
7		Ancillary FSI to sale BUA (60% on a+b+c	)			0.60								
	_	Total Permissible sale Built up area (7a+7b+7c+7d)												
	-	Premissible EWS FSI {20% of permissibl		c)}		0.00								
	_	Ancillary FSI to EWS BUA (60% on e)		Na Address military		0.00								
	_	al Permissible EWS Built up area (7e+7f)				0.00								
8	$\overline{}$	misible Built up area												
		Permisible Built up area with refrence				3318.00								
		Permissible Sale Built Up Area {(7a+7b				5308.80								
	C	Permissible EWS Built Up area of (EWS component (20% of 8b) including												
9	Des	ancillary (P line area)												
9	-	oposed Built Up area Proposed Sale Built Up Area (P-Line)												
			ence to Ba	sic FSI. Premi	um FSI, TDR)	5073.170 3318.000								
		Proposed Sale Built Up Area ( with refrence to Basic FSI, Premium FSI, TDR)  Consumed Ancillary FSI (Max 60% or 80%) (9a-9b)												
10	-	S flats details	7-7,17			1755.170								
	b	Proposed EWS flats Built Up area				0.000								
	-	Proposed Built Up area of EWS compon	ent (P-line	2)		0.000								
	<del></del>	t up area Details		-/										
		Built up a rea	Comm	Resi	Total sale	EWS								
11	а	Total Proposed BUA (P line)	0.000	5073.170	5073.170	0								
	b	Net Proposed BUA (Excluding	0.000	3318.000	3318.000	0.000								
	c	Consume Ancillary BUA	0.000	1755.170	1755.170	0.000								
12	+	posed Built Up Area Details												
	_	Sale component (P line area)				5073.170								
	b	EWS component (P line area)				0								
13	_	ance Built Up Area (P-Line Area)												
	a	Sale component (12a-8b)	The state of the s			235.63								
V.S-1001	-	EWS component (12b-8c)				0.00								
14		ess Built Up Area of EWS flat (12b-8c)		140		0.00								
15		Total Built up sale Area including exces				5073.170								
16	-	EWS Built up area after deducting excess al Ancillary area including ancillary of EV				0.000 1755.17								
16	+	al Ancillary area including ancillary of EV al FSI consumed	VJ BUA (SI	an or ric)		1/33.1/								
1/		Sale component (15/5)				1.529								
		EWS component (10a/5)				0.000								
18	1	Management of the control of the con				5.500								
		alance FSI												
	a													
	-	EWS component (7a+7b+/c+/d)-1/a		and the same of th		0.000								
	b													
10	b	EWS component (7e+7f)-17b				88								
19	b No.	EWS component (7e+7f)-17b of units proposed				0								
19	b No. a b	EWS component (7e+7f)-17b of units proposed Residential - Sale component Residential - EWS component Commercial				0								
19	b No. a b	EWS component (7e+7f)-17b of units proposed Residential - Sale component Residential - EWS component Commercial Trees to be planted against plot area (				0 0 33								
19	b No. a b a b	EWS component (7e+7f)-17b of units proposed Residential - Sale component Residential - EWS component Commercial Trees to be planted against plot area ( Trees to be planted against RG/open s				0 0 33 17								
19	b No. a b a b	EWS component (7e+7f)-17b of units proposed Residential - Sale component Residential - EWS component Commercial Trees to be planted against plot area ( Trees to be planted against RG/open s Existing trees				0 0 33 17 0								
19	b No. a b a b c d	EWS component (7e+7f)-17b of units proposed Residential - Sale component Residential - EWS component Commercial Trees to be planted against plot area ( Trees to be planted against RG/open s Existing trees Trees to be cut	pace (5 tre	ee for evey 10	0 Sq. M.)	0 0 33 17 0								
	b No. a b a b c d e	EWS component (7e+7f)-17b of units proposed Residential - Sale component Residential - EWS component Commercial Trees to be planted against plot area ( Trees to be planted against RG/open s Existing trees Trees to be cut Trees to be planted against tree fell (5	pace (5 tre	ee for evey 10	0 Sq. M.)	0 0 33 17 0 0								
	b No. a b a b c d e f	EWS component (7e+7f)-17b of units proposed Residential - Sale component Residential - EWS component Commercial Trees to be planted against plot area ( Trees to be planted against RG/open s Existing trees Trees to be cut Trees to be planted against tree fell (5 Total required trees (a+b+e) =	pace (5 tre tree for e	ee for evey 10	0 Sq. M.)	0 0 33 17 0 0 0								
	b No. a b a b c d e f	EWS component (7e+7f)-17b of units proposed Residential - Sale component Residential - EWS component Commercial Trees to be planted against plot area ( Trees to be planted against RG/open s Existing trees Trees to be cut Trees to be planted against tree fell (5	pace (5 tre tree for ev	ee for evey 10	0 Sq. M.)	0 0 33 17 0 0								

MR. TEJAS RAJNIKANT SHAH. FORM OF CERTIFICATE.

WORKED OUT IS 3912,526 SQ.M.

JEETENDRA PARMAR STATE/R/2022/API//02047

I Jetendra Parmar have been employed by the applicant as Licensed engineer.
I have examined the boundaries and the area of the plot and i do hereby certify that ,I have personally verified and checked all the statements made by the

applicant who is the owner /Developer in possession of the plot in the above form and found them to be correct.

CERTIFIED THAT I HAVE SURVEYED THE PLOT BEARING G.NO. 16/22/3 AT VILLAGE VIHIGHAR , TAL- PANVEL DATED :13-11-2018 AND THAT THE DIMENSIONS OF SIDE ETC. OF PLOT STATED ON THE PLAN ARE AS MEASURED ON SITE AND THE AREA SO

STATE/R/2022/APL/02047

PROJECT:
PLAN OF A PROPOSED RESIDENTIAL BUILDINGS 1 AND 2, IN G. NO. 16/22/3, AT AT VILLAGE - VIHIGHAR, TAL.- PANVEL, DIST.- RAIGAD.


AND ASSOCIATES

JPA/C+R/019/2004 ARCHITECTURE ENGINEERING prratham/sub


SCALE AS SHOWN

Ar Rutvija


A-101, "KANDPILE RESIDENCY", NEAR M.S.E.B. & FOREST OFFICE, TAKKA, PANVEL- 410206 Email: jeetendra\_parmar2000@yahoo.com

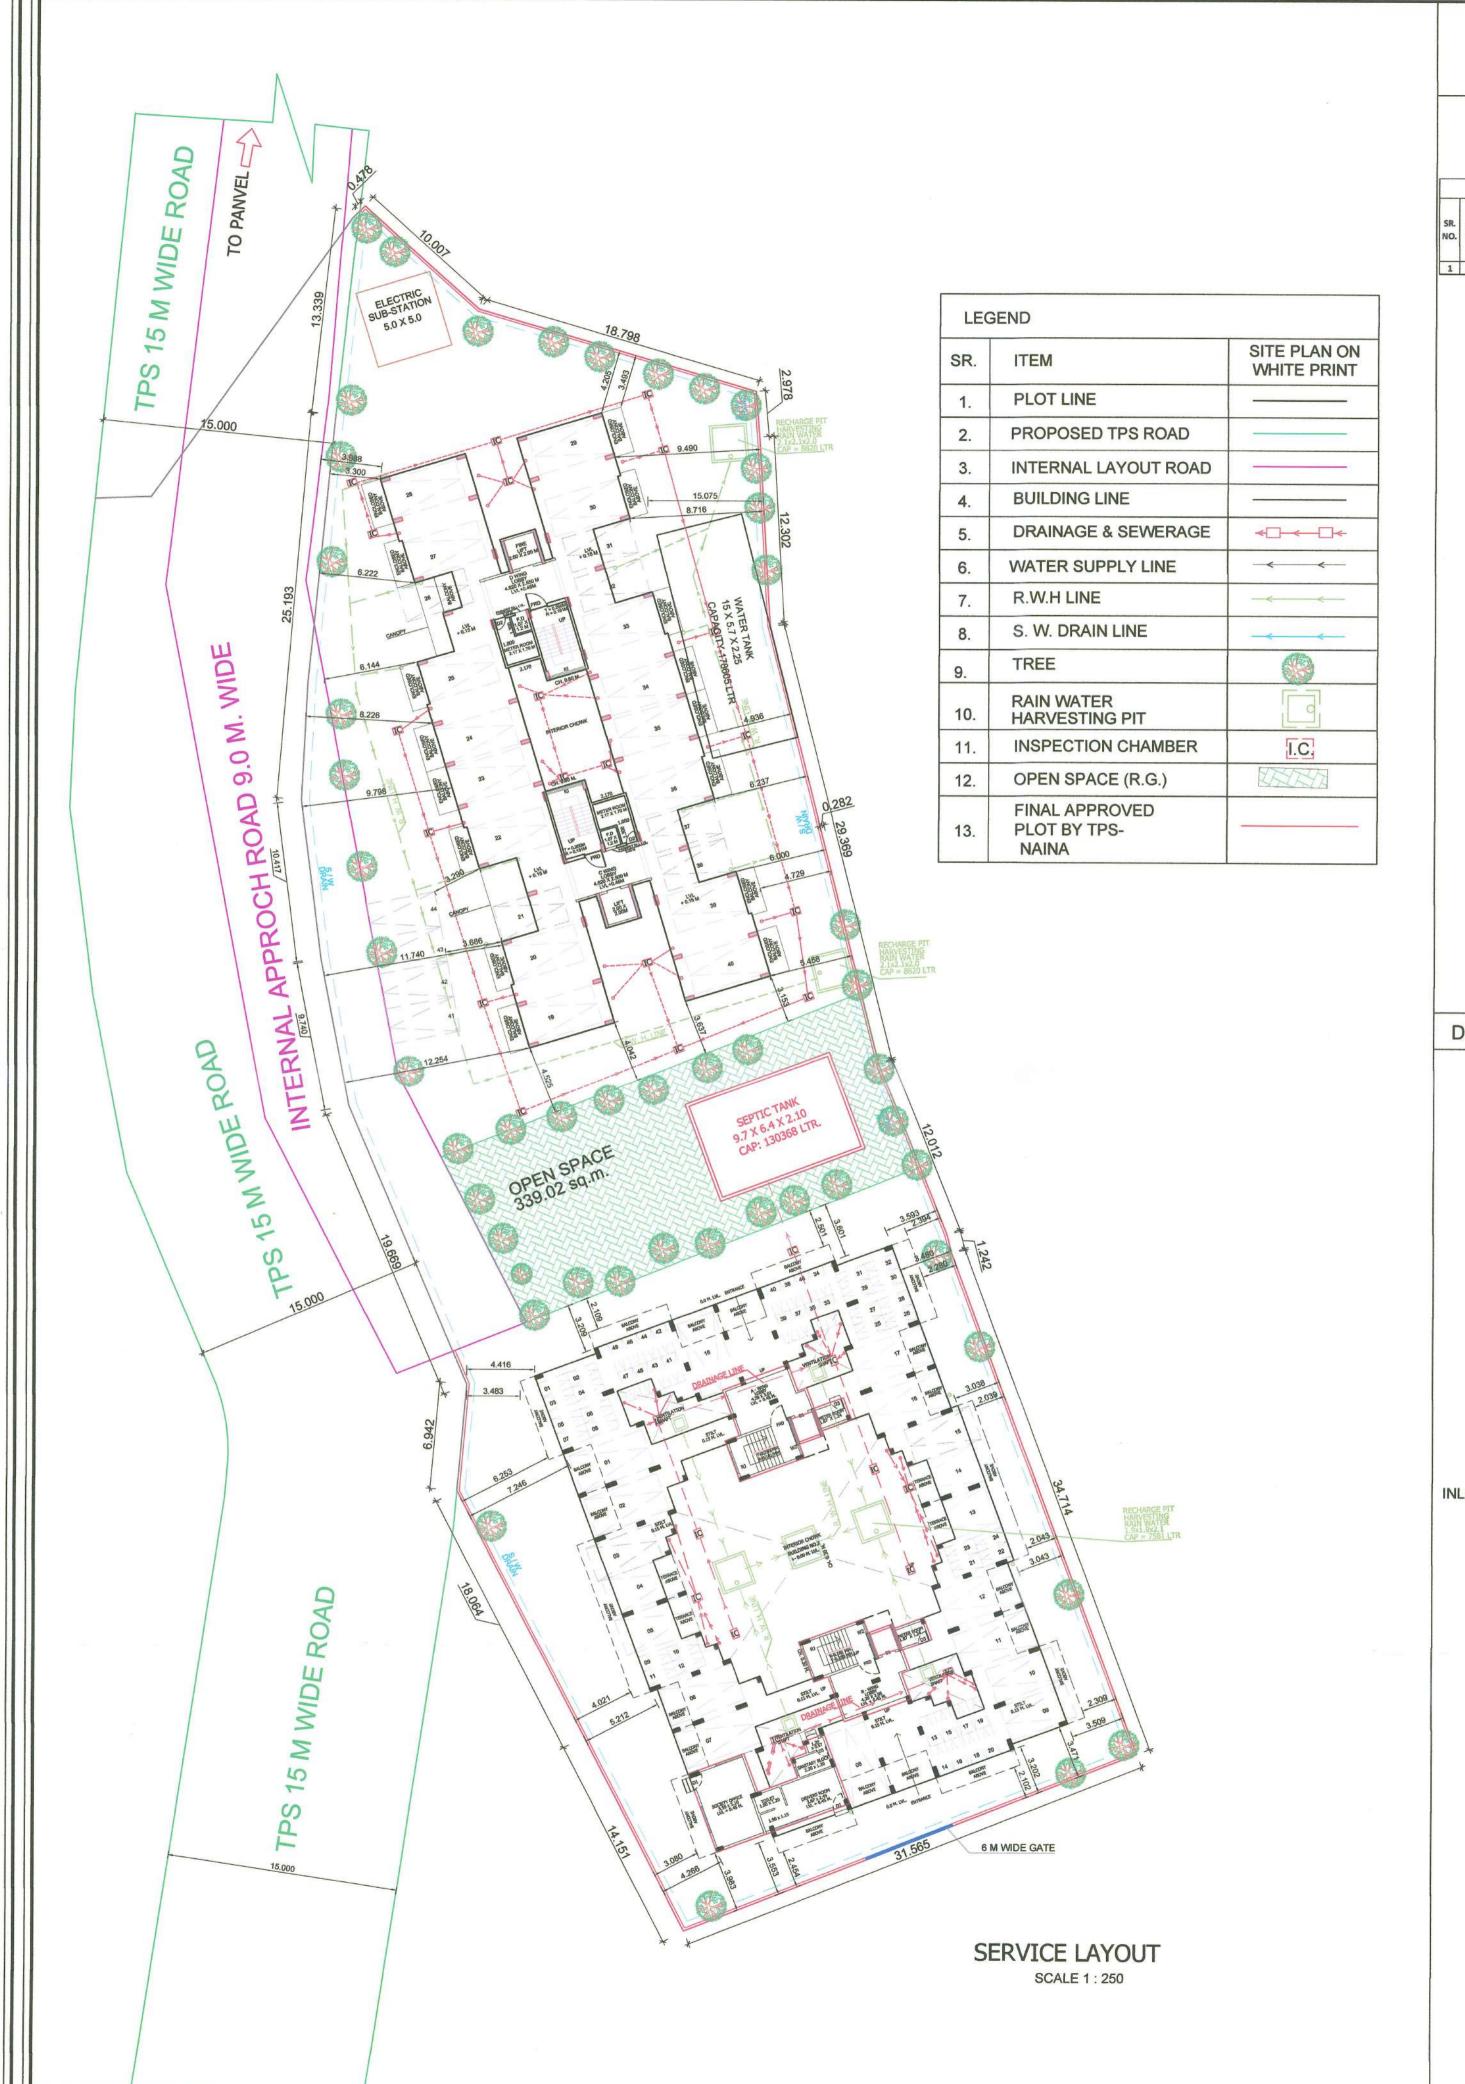

# DETAILS OF SEPTIC TANK & SOAK PIT

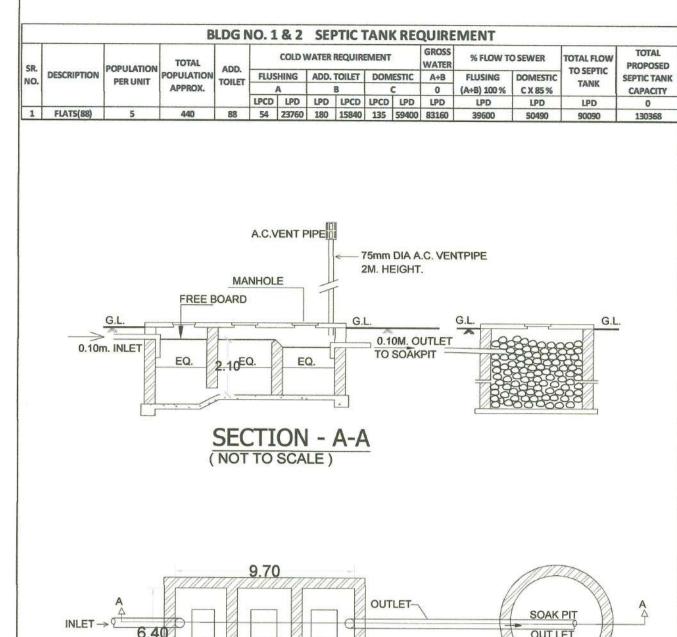

# DETAILS OF RAIN WATER HARVESTING

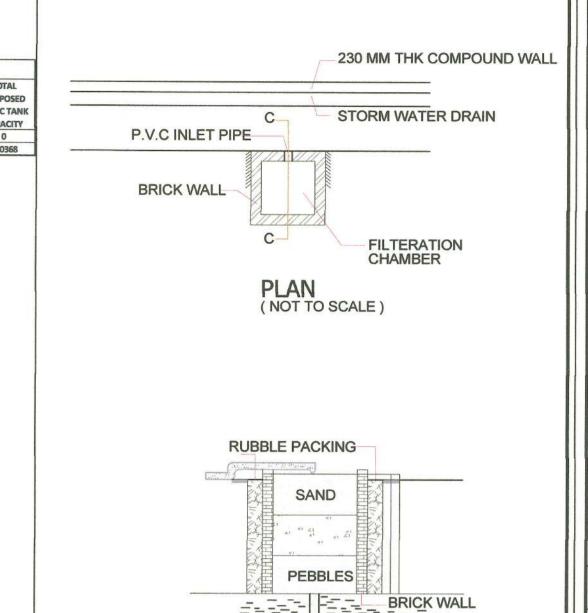


SECTION C-C (NOT TO SCALE)

EARTH FILLING

PERFORATED PVC

PIPES 200 MM DIA

## DETAILS OF U/ G WATER TANK

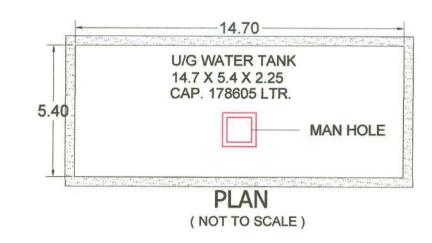



PLAN OF BUILDING NO 1&2 SEPTIC TANK & SOAK PIT

( NOT TO SCALE )

SIZE = 9.70 X 6.40 X 2.10 CAPACITY-130368 LTR.

BUILDING	TOTAL	ADDL.		WATER	REQUIRMENT (I	N LITER )	UNE	DER GRO	DUNE	WATER	TAN	IK PRO	/IDED	
/ WING	NUMBER OF UNITS	TOILET	POPULATION	ADDL. TOILET	CAPACITY PERHEAD	TOTAL	TANK NUMBER		SIZE	DIMEN	SION	ı	CAPACITY LITER	
[1]	[2]	[3]	[4]	[5] [6] [7]		[8]			[9]			[10]		
			= [2] X 5	= [3] X 180	= [4] X 189	= [5] + [6]								
			BUIL	DING NO. 1		***************************************		44.70	.,	- 40				
1-C	20	20	100	3600	18900	22500		14.70	X	5.40	X	2.25	178.605	
1-D	20	20	100	3600	18900 22500				1122			17 11 2 11 11 11		
BUILDING NO. 2						1	FREE BOARD 0.20 METER							
2-A	24	16	120	2880	22680	25560			FR	FF ROA	KD 0.	20 IVIET	ETER	
2-B	24	16	120	2880	22680	25560								
TOTAL	88	72	440	12960	83160	96120		CA			Υ	7	178605	

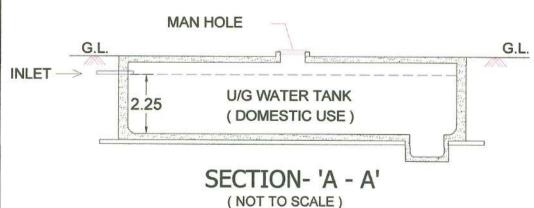


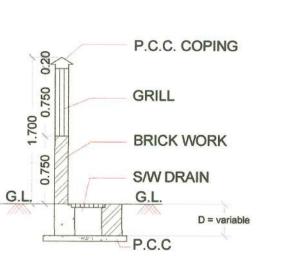

TYPICAL SECTION OF COMPOUND WALL / S.W. DRAIN LINE (NOT TO SCALE)

	WATER			OVI	ERHEA	D WATE	R TANK PRO	VISION
BUILDING REQUIRED			TAN	/ SI7E / N	/ETED	1	NUMBER	PROPOSED CAPACITY
	(LITRE)		TANK SIZE ( METER )					( LITRES )
[1]	[2]	[3]					[4]	[5]
С	15750	4.40	Х	2.50	X	3.25	1	35750
D	15750	4.40	Х	2.50	Х	3.25	1	35750
		TOT	AL				=	71500
NOTE 1 :- I	REQUIRED O	HT CAP.	= 50	% OF U.	G. TAN	IK CAPA	CITY	
NOTE 2:- I	PROPOSED F	IRE TAN	IK FO	RCAND	D WII	VG. = 17	500 + 17500	= 35000 LITRES.

	WATER			OVI	ERHEA	D WATE	R TANK PRO	VISION
BUILDING RE	REQUIRED	TANK SIZE ( METER )					NUMBER	PROPOSED CAPACITY
	(LITRE)						OF TANK	( LITRES )
[1]	[2]	[3]					[4]	[5]
Α	12780	4.15	Χ	2.50	Χ	2.05	1	21269
В	12780	4.15 X 2.50 X 2.05					1	21269
		TOT	=	42538				

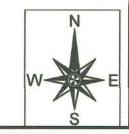


# SHEET NO.

2/5

#### STAMP OF APPROVAL

THIS PLANS APPROVED SUBJECT TO THE CONDITIONS MENTIONED IN COMMENCEMENT CERTIFICATE ISSUED BY THIS OFFICE BEARING CERTIFICATE NO CIDCO/NAINA/Panvel/Vihighar/BP-00387/ACC/2024/0527 Dated 04 Jul 2024

### SANCTION IDP MAP

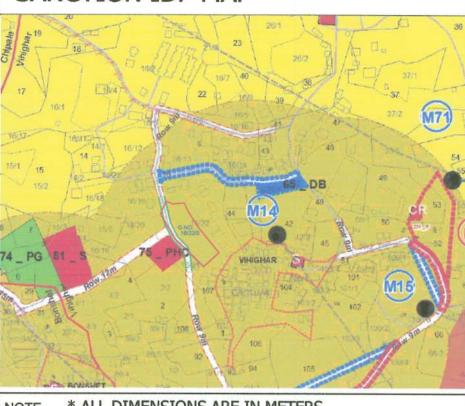

NOTE \* ALL DIMENSIONS ARE IN METERS.

\* INTERNAL WALL THICKNESS 0.10 MM. \* EXTERNAL WALL THICKNESS 0.15 MM.

#### CONTENT OF SHEET

LAYOUT PLAN, PARKING REQUIREMENT, BLOCK PLAN, PLOT AREA CALCULATION BY TRANGULATION.

#### CERTIFICATE OF AREA

CERTIFIED THAT I HAVE SURVEYED THE PLOT BEARING G.NO. 16/22/3 AT VILLAGE - VIHIGHAR , TAL- PANVEL DATED :13-11-2018 AND THAT THE DIMENSIONS OF SIDE

ETC. OF PLOT STATED ON THE PLAN ARE AS MEASURED ON SITE AND THE AREA SO WORKED OUT IS 3912.526 SQ.M.

MR. TEJAS RAJNIKANT SHAH.




JEETENDRA PARMAR STATE/R/2022/APL/02047 ( SIGN. OF LICENSED ENGINEER

#### FORM OF CERTIFICATE.

I Jetendra Parmar have been employed by the applicant as Licensed engineer.
I have examined the boundaries and the area of the plot and i do hereby certify that ,I have personally verified and checked all the statements made by the applicant who is the owner /Developer in possession of the plot in the above form and found them to be correct.

MR. TEJAS RAJNIKANT SHAH.

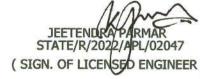

#### PROJECT:


PLAN OF A PROPOSED RESIDENTIAL BUILDINGS IN G. NO. 16/22/3, AT VILLAGE - VIHIGHAR, TAL.- PANVEL, DIST.- RAIGAD.


# JEETENDRA PARMAI AND ASSOCIATES


FILE NAME prratham/sub

DRG. NO.

ARCHITECTURE ENGINEERING

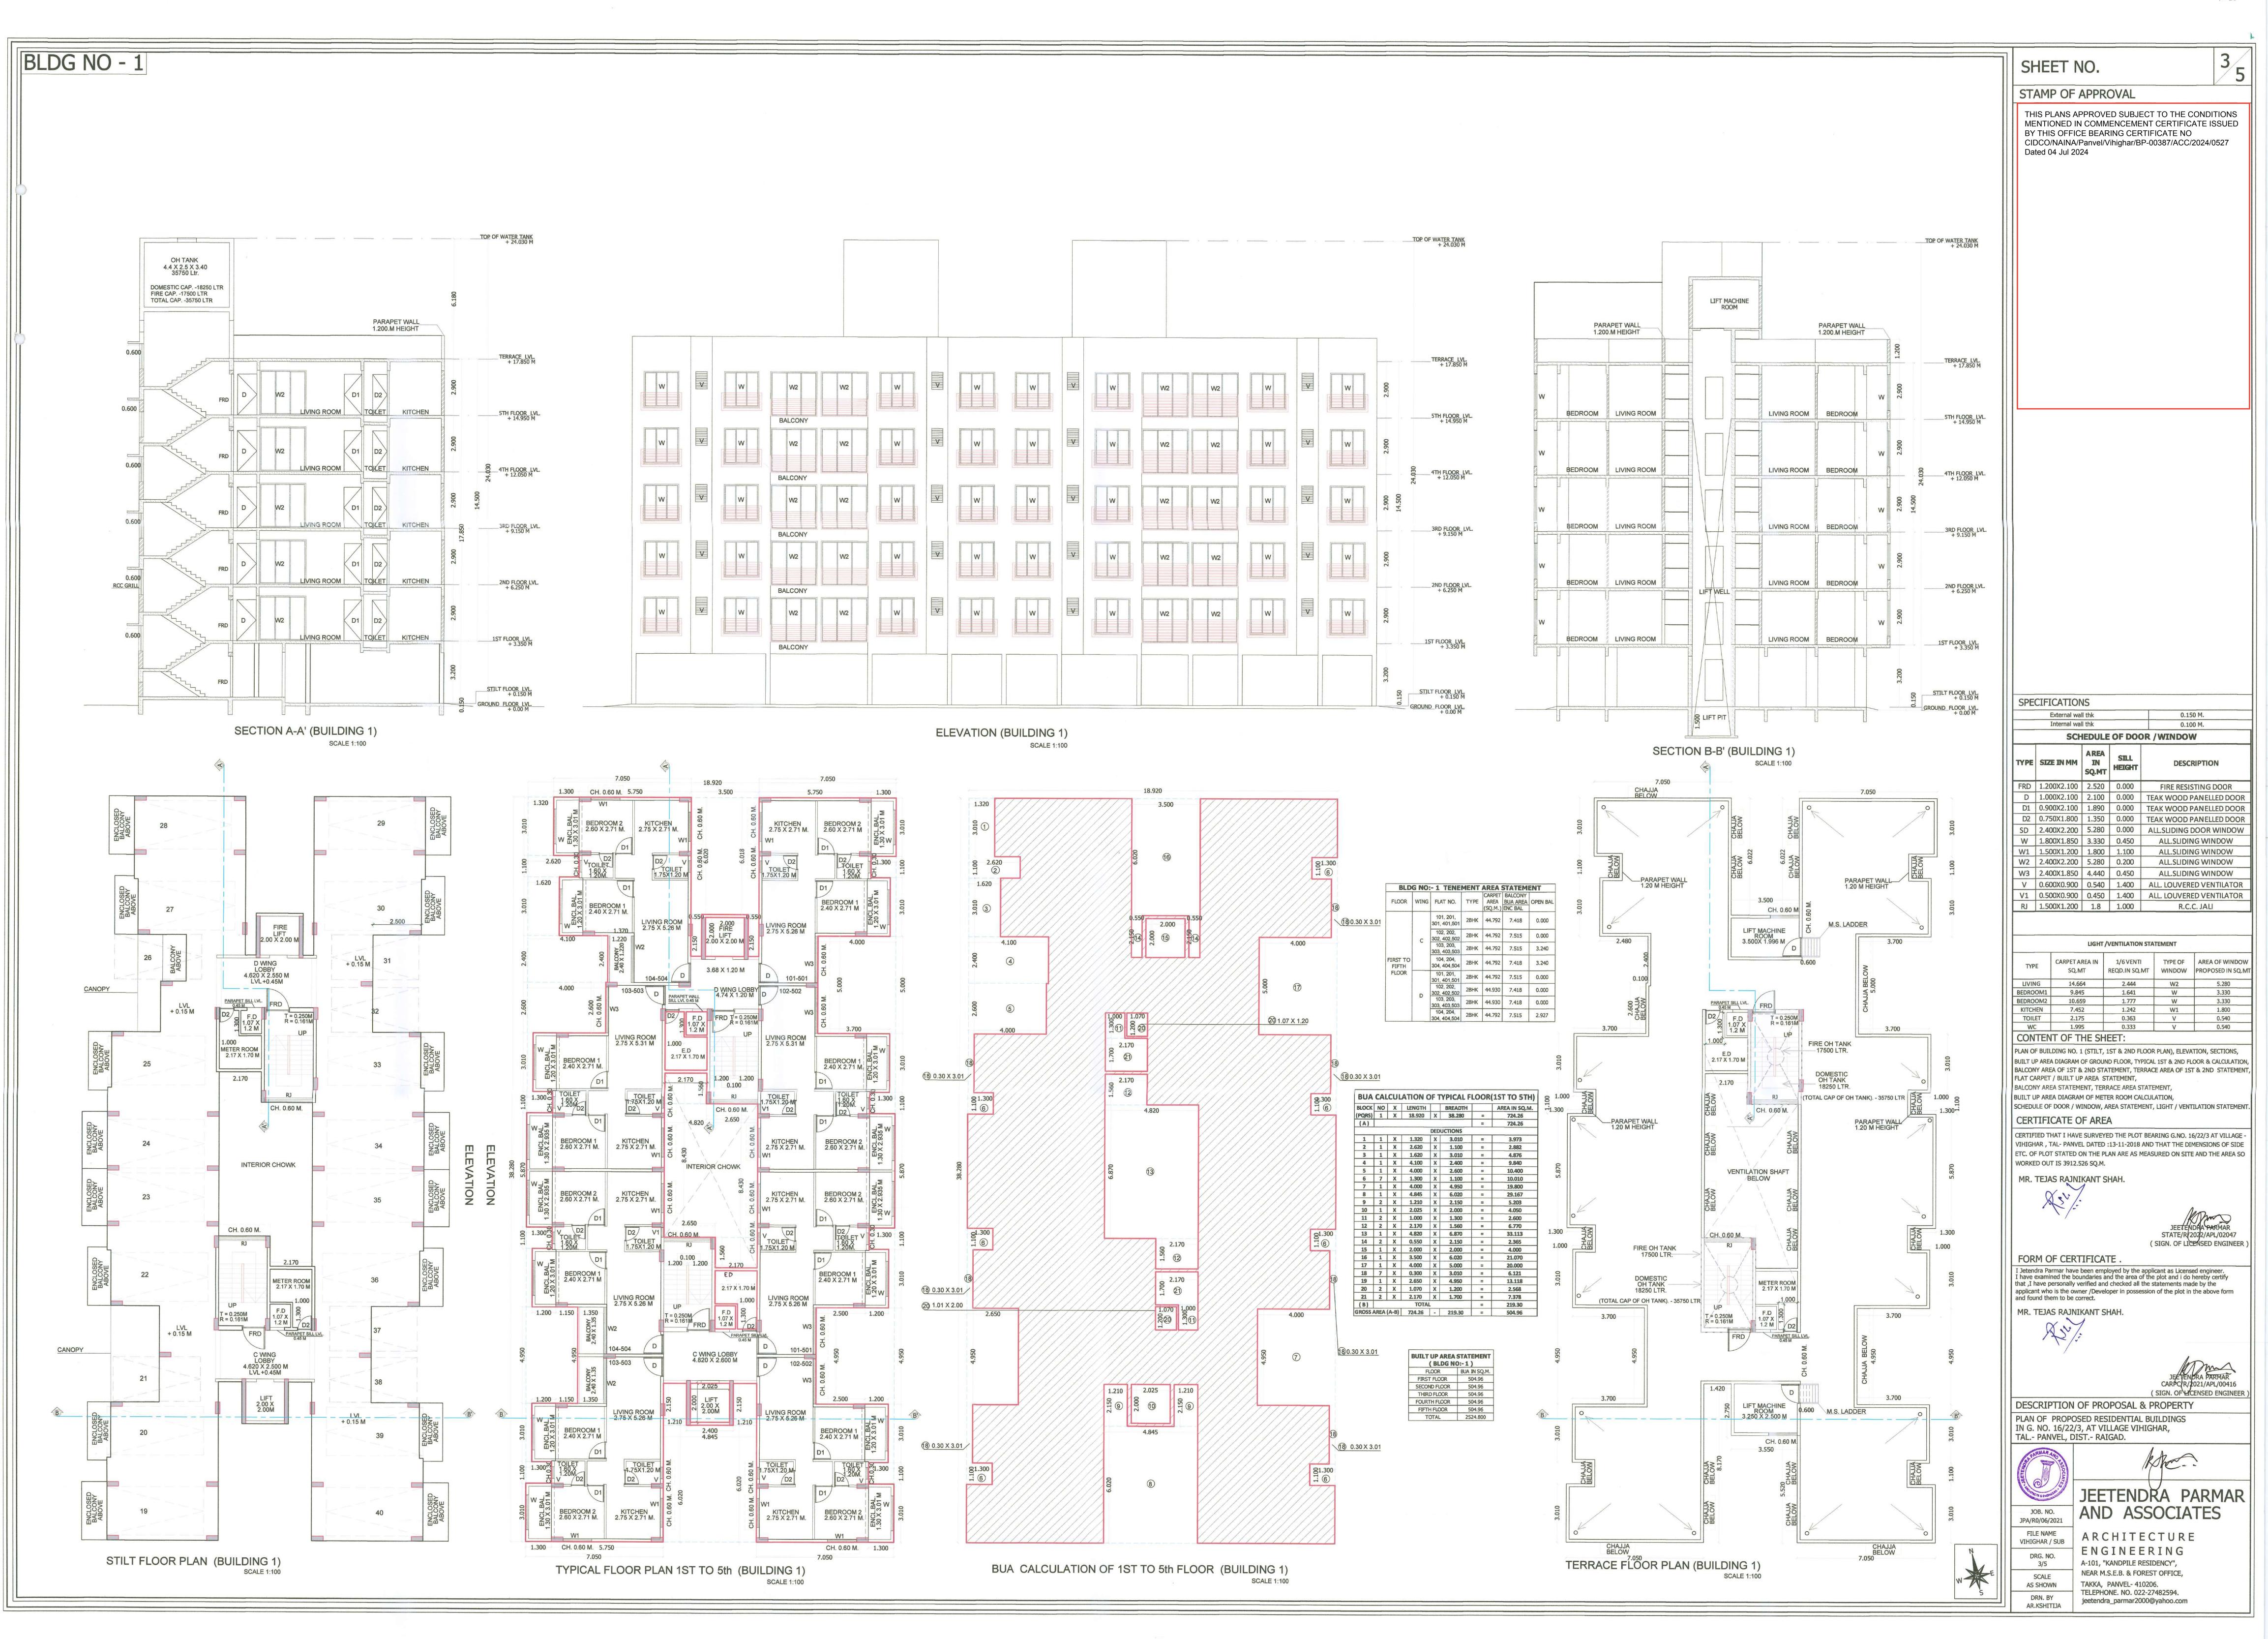

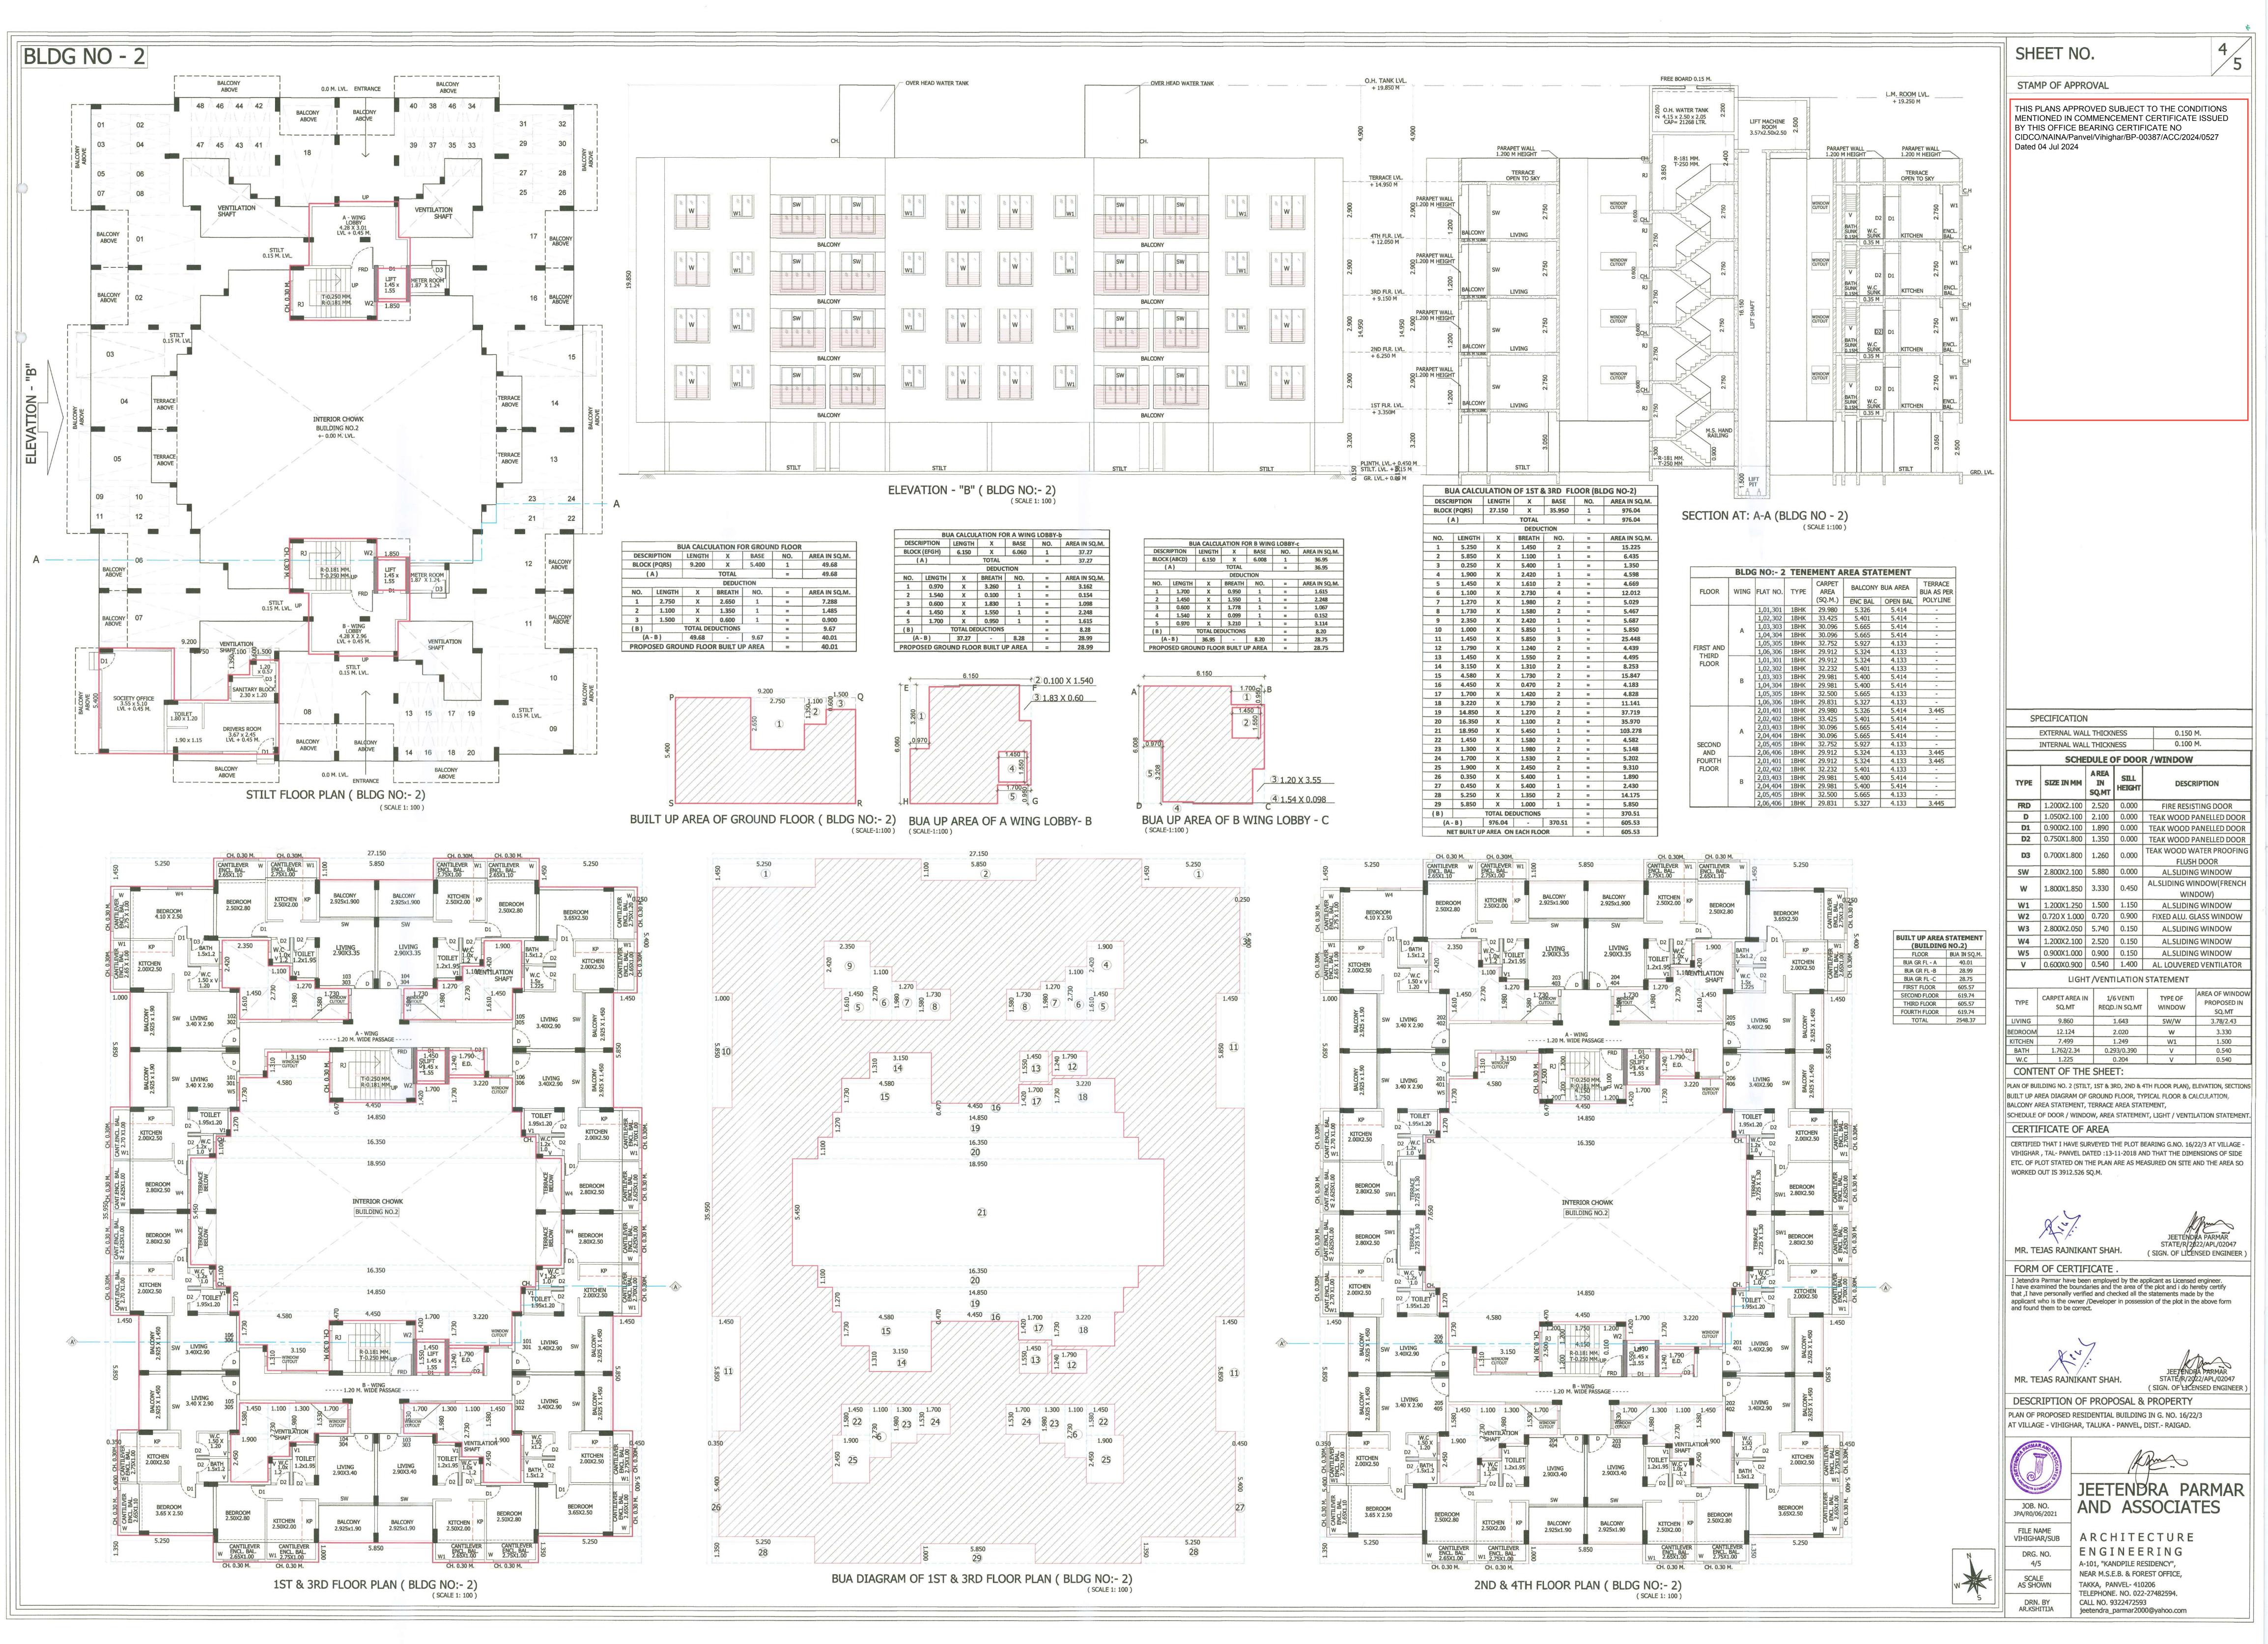

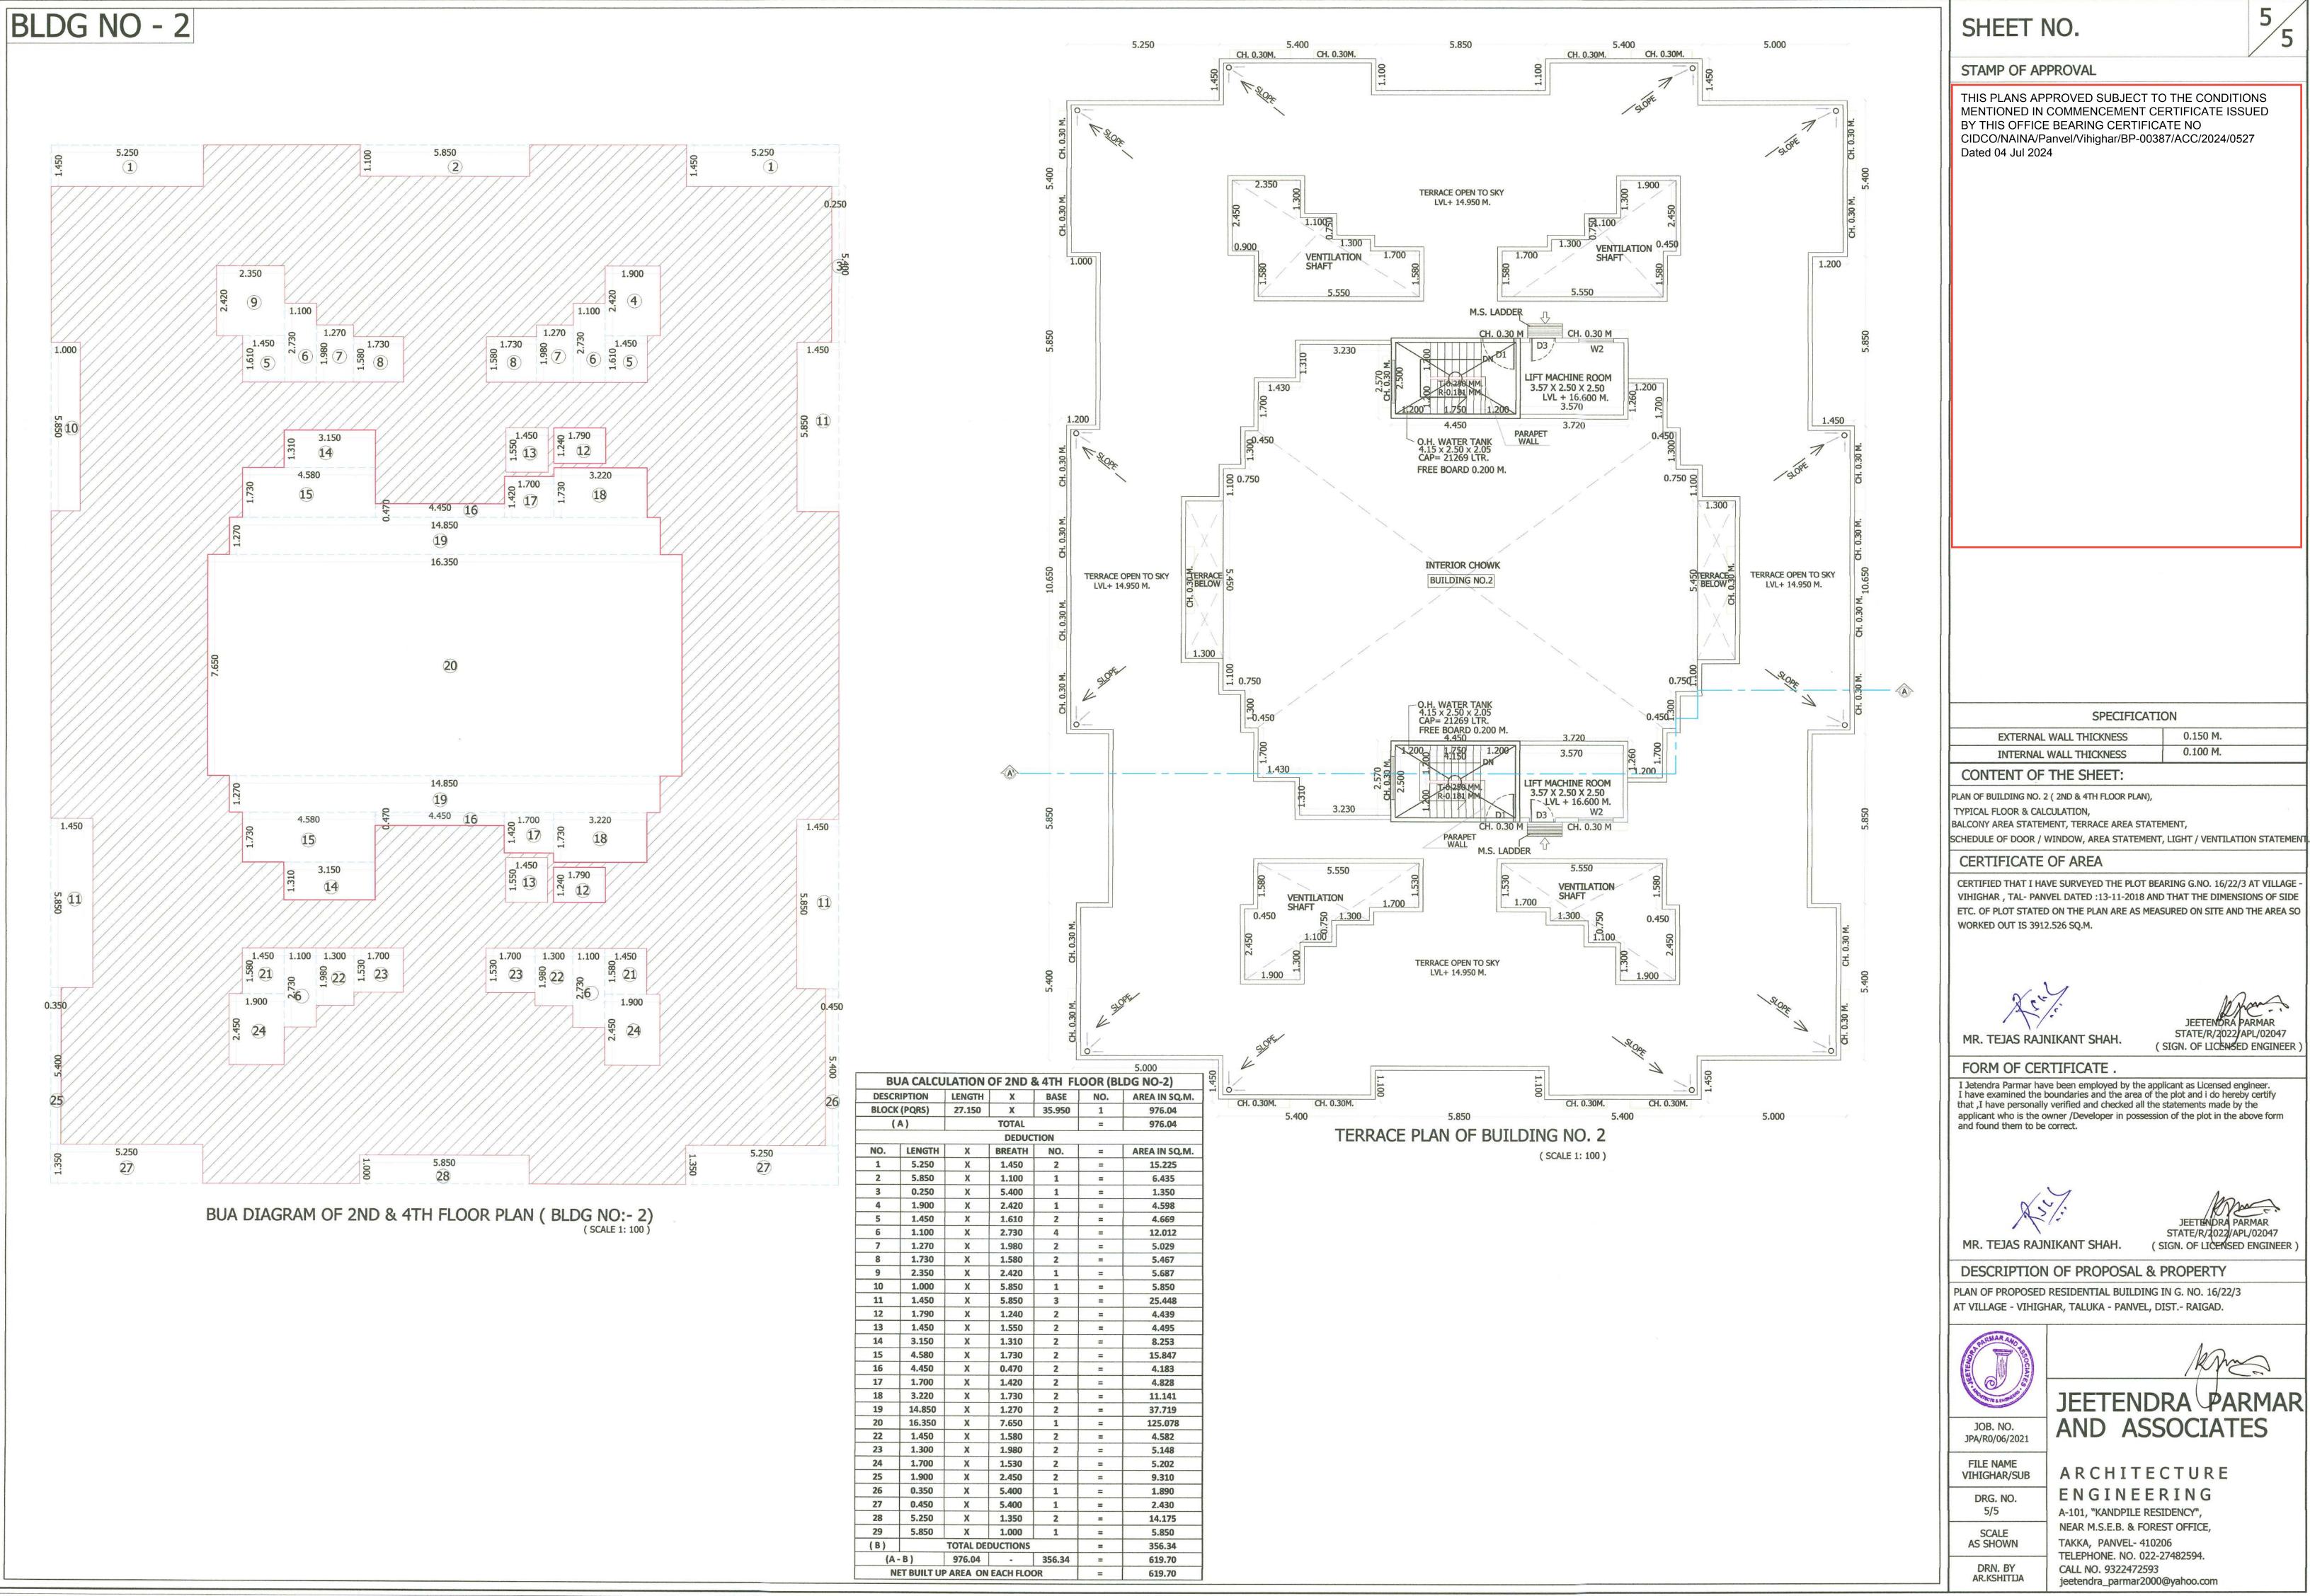

MENTIONED IN COMMENCEMENT CERTIFICATE ISSUED CIDCO/NAINA/Panvel/Vihighar/BP-00387/ACC/2024/0527

STATE/R/2022/APL/02047 ( SIGN. OF LICENSED ENGINEER

I have examined the boundaries and the area of the plot and i do hereby certify that ,I have personally verified and checked all the statements made by the applicant who is the owner /Developer in possession of the plot in the above form

> JEETENDRA PARMAR STATE/R/2022/APL/02047 ( SIGN. OF LICENSED ENGINEER

