

DRAWING FOR BUILDING PERMISSION SHEET NO.

CONTENT: LOCATION PLAN, DEMARCATION PLAN, PLOT AREA DIAGRAM STATEMENT, GROUND FLOOR PLAN, AREA DIAGRAM WITH STATEMENT, LIGHT & VENTILATION STATEMENT, DOOR WINDOW SCHEDULE, TENEMENT 7 NO. OF UNITS STATEMENT, PARKING STATEMENT, COMPOUND WALL DETAILS.

This Amended Commencement Certificate is approved subject to conditions mentioned in Amended Commencement Certificate bearing no.

Sr. No.	-	Partions of Final plot 23	culars			Area (in Sq. M.
	a	Area of Final Plot (as per PR Card)				784.000
	b	Area of Final Plot as per Final plot pla	n (by triang	gulation metho	d at true scale)	785.440
1	С	Area of Final Plot as per Physical Surv				784.000
	d	Area of Original Plot				1950.000
	е	Area of plot considered (least of (a), (l	o) and (c)}			784.000
		duction for				0.000
	a b	Existing road (ROW) Proposed widening of existing road				0.000
2	C	Proposed road as per TILR				0.000
	d	Area under reservation, if any				0.000
	_	al (a+b+c+d)				0.000
3	OTHER DESIGN	ance area of Plot (1-2)				784.000
	An	nenity Space, if any				
4	а	Required Amenity Space (5% of 3)				0.00
	_	Proposed Amenity Space				0.00
5	-	t Plot area (3-4b)	Manual Control of the			784.00
6		reational Open Space (If applicable)				0.000
	b	Required RG/Open Space (10% of 5) Proposed RG/open Space				0.000
-	-	al Entitlement of FSI in the proposal		-		0.000
	a	Base FSI permissible (Original plot/ F	inal plot)			2.49
	b	Premissible FSI with payment of prem				0.00
	С	TDR/In-situ FSI				0.00
7	d	Ancillary FSI to sale BUA (60% on a+b-	+c)			1.49
	Tot	al Permissible sale Built up area (7a+7b				3.98
	е	Premissible EWS FSI {20% of permissi	ble FSI(a+b	+c)}		NA
	f	Ancillary FSI to EWS BUA (60% on e)	4			NA
	_	al Permissible EWS Built up area (7e+7	f)			NA
8	Per	rmisible Built up area Permisible Built up area with refrence	e to Posic C	CI Deomium C	I TOP /E V	1950.00
	a	(7a+7b+7c)}	e to basic r	Si, Fremium F.	א כן אטו ,ו	1930.00
	h	3120.00				
	b	NA				
	1	Permissible EWS Built Up area of (EW ancillary (P line area)	3 compone	110 (20% 01 00)	merading	l No.
9	Pro	pposed Built Up area				****
	a Proposed Sale Built Up Area (P-Line)					2642.461
	b	1950.000				
	b Proposed Sale Built Up Area (with refrence to Basic FSI, Premium FSI, TDR) c Consumed Ancillary FSI (Max 60% or 80%) (9a-9b)					692.461
10	EW	S flats details				
	a	NA				
	L					
	b	NA				
	С	Proposed Built Up area of EWS comp	onent (P-lin	e)		NA
	Bu	ilt up area Details		, ,		
	L	Built up area	Comm	Resi	Total sale	EWS
11	a	Total Proposed BUA (P line)	0.000	2642.461	2642.461	NA
	b	Net Proposed BUA (Excluding	0.000	1950.000	1950.000	NA
	-	Anillary)	0.000	500 464	CO2 4C4	
12	C	Consume Ancillary BUA	0.000	692.461	692.461	NA NA
12	a	Sale component (P line area)				2642.461
	b	EWS component (P line area)				NA
13	-	lance Built Up Area (P-Line Area)				,
	а	Sale component (12a-8b)				477.539
	b	EWS component (12b-8c)				NA
14	Exc	ess Built Up Area of EWS flat (12b-8c)				NA
15	a	Total Built up sale Area including exc				2642.461
	b	EWS Built up area after deducting exc				NA
16	_	tal Ancillary area including ancillary of	EWS BUA (s	um of 11c)		692.461
17		tal FSI consumed				2.252
	a	Sale component (15/5)				3.370
18	Bal	EWS component (10a/5) ance FSI	-			NA NA
10	a	Sale component (7a+7b+7c+7d)-17a				0.609
	b	EWS component (7e+7f)-17b				NA NA
	_	. of units proposed				
19	а	Residential - Sale component				43
19	L	Residential - EWS component				NA
	b	Commercial				0
	а	Trees to be planted against plot are				8
	b	Trees to be planted against RG/oper	space (5 tr	ee for every 10	00 Sq. M.)	0
	С	Existing trees				4
		4				
20	d	Trees to be cut				
20	e e	Trees to be planted against tree fell	(5 tree for e	every 1 tree fel	l) (d x 5)=	20
20	d e f	Trees to be planted against tree fell Total required trees (a+b+e)=		every 1 tree fel	l) (d x 5)=	28
20	d e f g	Trees to be planted against tree fell	n (c-d)=	every 1 tree fel	I) (d x 5)=	

CERTIFICATE OF AREA CERTIFIED THAT THE PLOT UNDER REFERENCE WAS SURVEYED BY ME ON 08/05/2024 AND THE DIMENSIONS OF SIDES ETC. OF PLOT STATED ON PLAN ARE AS MEASURED ON SITE AND THE AREA SO WORKED OUT TALLIES WITH THE AREA STATED IN DOCUMENT OF

SITE PLAN BUILDING PLAN

NO COLOUR NO COLOUR

SIGNATURE OF LICENSED ARCHITECT SCALE DRAWN BY CHECKED BY ----- 01 AS SHOWN AS AR.NILAM

M/s. KONKAN SHRUSTI INFRA DEVELOPERS LLP. BUILDING NO. 306, 2ND FLOOR MILLENNIUM BUSINESS PARK, SECTOR-2, KOPAR KHAIRANE, THANE,


FORM OF CERTIFICATE

EXAMINED THE BOUNDARIES AND THE AREA OF THE PLOT AND I DO HEREBY CERTIFY THAT I HAVE PERSONALLY VERIFIED AND CHECKED ALL THE STATEMENTS MADE BY THE APPLICANT WHO IS THE OWNER IN POSSESSION OF THE PLOT AS IN THE ABOVE FORM AND FOUND THEM TO BE CORRECT.

> SIGNATURE OF LICENSED ARCHITECT ADDRESS OF LICENSED ARCHITECT



DEEPAK P. THAKARE ARCHITECTS & PLANNERS SHREE NAND-DHAM BLDG., A-509, PLOT NO 59, SECTOR-11,C.B.D.BELAPUR,NAVI MUMBAI,400614. PH.+9198 2006 0238 dpthakare@gmail.com

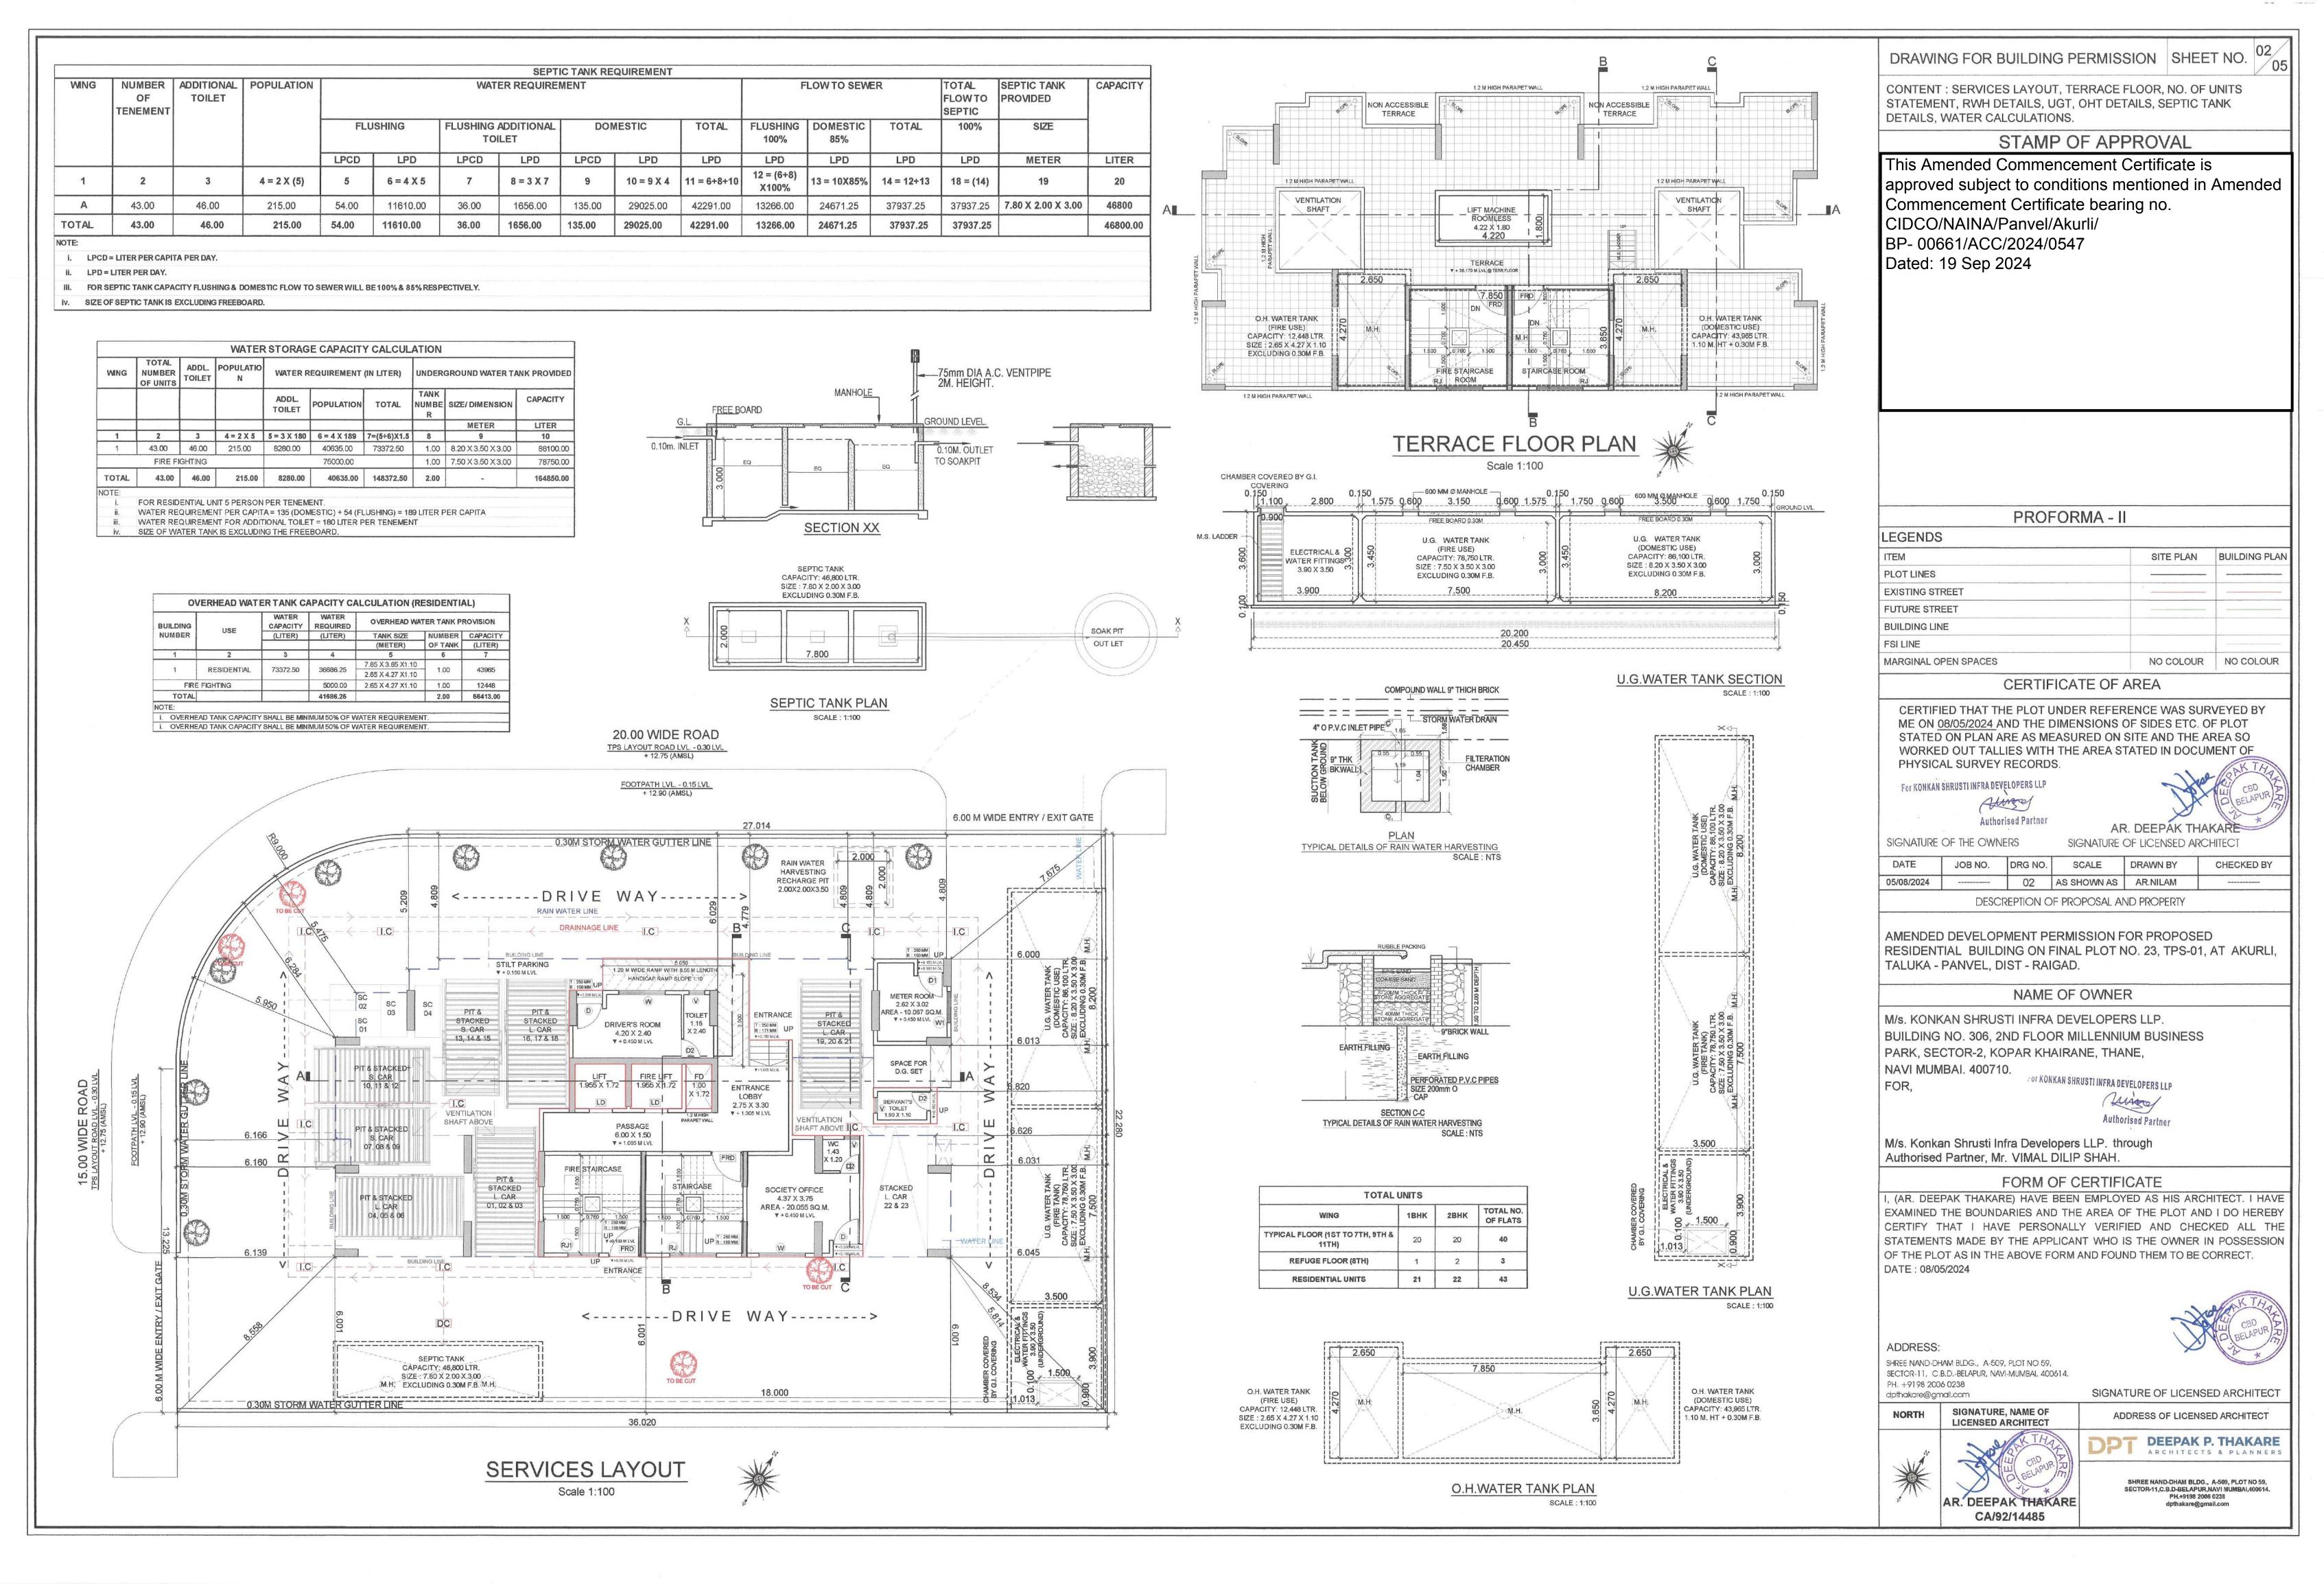

NO.	NUMBER	TRIANGLE/	1/2	BASE	HEIGHT	AREA
		RECTANGLE	1/2	(M)	(M)	(SQM)
1	2	3	4	5	6	(7) = (3)X(4)X(5)X(6)
		1	IST FLOOR			
1	Α	1.00	1.00	23.850	11.470	273.560
	TOTAL ADI	DITION				273.560
	DEDUCTIO	N				
2	1	1.00	1.00	4.000	0.400	1.600
3	2	1.00	1.00	2.850	0.820	2.337
4	3	1.00	1.00	2.770	0.080	0.222
5	4	1.00	1.00	0.800	1.720	1.376
6	5	2.00	1.00	2.700	1.070	5.778
7	5A	1.00	1.00	1.000	0.400	0.400
8	6	1.00	1.00	0.600	1.070	0.642
9	7	2.00	1.00	3.150	3.000	18.900
10	8	1.00	1.00	1.000	1.720	1.720
11	9	1.00	1.00	3.000	1.700	5.100
12	10	1.00	1.00	0.800	1.780	1.424
13	11	1.00	1.00	0.600	1.220	0.732
	DEDUCTIO	N				40.231
	LIFT WELL					
13	L1	2.00	1.00	1.955	1.640	6.412
14	L2	2.00	1.00	1.995	0.080	0.319
	TOTAL ARE	EA OF LIFT WELL				6.732
	TOTAL DEI	DUCTION				46.962
TOTAL	BUILT UP A	REA@ 1ST FLO	OR			226.597

SR.	NUMBER	NUMBER OF TRIANGLE/	1/2	BASE	HEIGHT	AREA
NO.		RECTANGLE		(M)	(M)	(SQM)
1	2	3	4	(7) = $(3)X(4)X(5)X(6)$		
	TYPICAL 2	ND TO 7TH, 9TH	& 11TH FLO	OR .		
1	Α	1.00	1.00	23.850	11.470	273.560
	TOTAL AD	273.560				
	DEDUCTIO	N				
2	1	1.00	1.00	4.000	0.400	1.600
3	2	1.00	1.00	2.850	0.820	2.337
4	3	1.00	1.00	2.770	0.080	0.222
5	4	1.00	1.00	0.800	1.720	1.376
6	5	1.00	1.00	1.000	0.400	0.400
7	6	1.00	1.00	0.600	1.070	0.642
8	7	2.00	1.00	3.150	3.000	18.900
9	8	1.00	1.00	1.000	1.720	1.720
10	9	1.00	1.00	3.000	1.700	5.100
11	10	1.00	1.00	0.800	1.780	1.424
12	11	1.00	1.00	0.600	1.220	0.732
	DEDUCTIO	N				34.453
	LIFT WELL					
13	L1	2.00	1.00	1.955	1.640	6.412
14	L2	2.00	1.00	1.995	0.080	0.319
	TOTAL ARI	6.732				
	TOTAL DE	DUCTION				41.184
TOTA	L BUILT UP A	REA@ TYPICAL	2ND TO 7TH	9TH & 11TH F	LOOR	232.375
NET B	UILT UP ARE	A @ TYPICAL 2N	D TO 7TH, 91	H & 11TH FLO	OOR	232.375


BUILDING	ROOM	TENEMENT NUMBER	CARPET AREA	WINDOW TYPE	L&V L&V REQUIRED PROVID	
	1	2	3	4	5=3/10	6
	LIVING		12.705	WA	1.271	6.129
	KITCHEN	202	5.330	W1	0.533	1.560
1	BEDROOM		9.725	W	0.973	2.340
1	M. BEDROOM-1		10.479	W	1.048	2.340
	TOILET-1		2.340	V	0.234	0.540
	C. TOILET		2.205	V	0.221	0.540

		SIZE		SILL LEVEL	
TYPE	WIDTH	HEIGHT	AREA	(METER)	DESCRIPTION
	(METER)	(METER)	(SQM)		
1	2	3	4 = 2 X 3	5	6
D	1.000	2.270	2.270	0.000	T.W. FRAMED PANNELED DOOR
D1	0.900	2.270	2.043	0.000	T.W. FRAMED PANNELED DOOR
D2	0.750	2.270	1.703	0.000	T.W. FRAMED PANNELED DOOR
w	1.800	1.300	2.340	0.370	ALUMINIUM SLIDING FRENCH WINDOW
VV	1.800	0.600	1.080	0.370	FIXED GLASS WINDOW
WA	2.700	2.270	6.129	0.000	ALUMINIUM SLIDING FRENCH WINDOW
W1	1.200	1.300	1.560	0.370	ALUMINIUM SLIDING FRENCH WINDOW
**1	1.200	0.600	0.720	0.570	FIXED GLASS WINDOW
W2	2.400	1.300	3.120	0.370	ALUMINIUM SLIDING FRENCH WINDOW
	2.400	0.600	1.440	0.070	FIXED GLASS WINDOW
V	0.600	0.900	0.540	1.370	ALUMINIUM LOUVERED WINDOW
FRD	1.200	2.270	2.724	0.000	FIRE RATED DOOR.
RJ	1.800	1.300	2.340	0.970	R.C.C. JALI.
RJ1	1.200	1.300	1.560	0.970	R.C.C. JALI

TOTAL	UNITS		
WING	1ВНК	2BHK	TOTAL NO.
TYPICAL FLOOR (1ST TO 7TH, 9TH & 11TH)	20	20	40
REFUGE FLOOR (8TH)	1	2	3
RESIDENTIAL UNITS	21	22	43

SR.	NUMBER	NUMBER OF TRIANGLE/	1/2	BASE	HEIGHT	AREA
NO.	NUMBER	RECTANGLE	1/2	(M)	(M)	(SQM)
1	2 3 4 5	5	6	(7) = (3)X(4)X(5)X(6)		
	REFUGE	AREA@8TH FLC	OR			
1	Α	1.00	1.00	2.957	5.550	16.411
	TOTAL AD	DITION				16.411
	DEDUCTIO	N		115019-50-03-400301-50-03-		
2	1	1.00	1.00	1.207	0.879	1.062
3	2	1.00	1.00	0.107	1.300	0.140
4	3	1.00	1.00	0.107	1.200	0.129
5	4	2.00	1.00	0.030	1.350	0.081
	DEDUCTIO	N		AND THE PROPERTY OF THE PARTY O		1.411
TOTAL	REFUGE AF	REA@8TH FLOC	R			15.000

MIN.REQUIRED REFUGE AREA AS PER DCR MIN.REFUGE AREA REQUIRED FOR BLDG. MORE THAN 24M HEIGHT	15	SQ.M	(A
CALCULATION AS PER NOS OF FLATS		30,111	- 1/4
TOTAL PROPOSED UNITS 7TH & 9TH FLOOR	8	FLATS	
REFUGE AREA REQUIRED AT 8TH FLOOR = (8 X 0.3 X 5 PERSON)	12,000	SQ.M	(B)
CALCULATION AS PER OCCUPANT LOAD			150000
TOTAL PROPOSED NET BUA PER WING AT 7TH & 9TH FLOOR=(232.375 + 232.375)	464.751	SQ.M	
REFUGE AREA REQUIRED AT 8TH FLOOR = (464.751/12.5X0.3)	11.154	SQ.M	(C)
REQUIRED REFUGE AREA PER WING MAXIMUM FROM (A), (B) & (C)	15.000	SQ.M	(D
REFUGE AREA PROPOSED AT 8TH FLOOR	15.000	SQ.M	(E
EXCESS REFUGE AREA PER WING (E-D)	0.000	SQ.M	(F)
REFUGE AREA PROPOSED AT 8TH FLOOR	15.000	SQ.M	

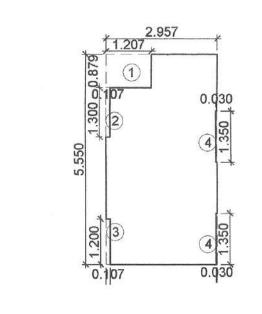


AREA CALCULATION OF REFUGE AREA

Scale 1:100





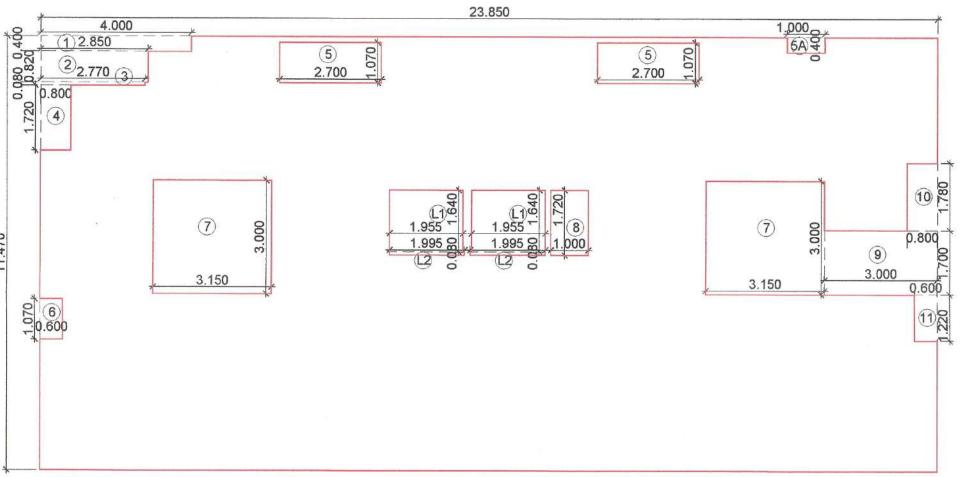

AREA CALCULATION OF

1ST FLOOR PLAN

Scale 1:100

23.850 CHAJJA @ 0.75 M

BEDROOM

7.75 X 1.50

▼ + 4.500 M LVL @ 1ST FLOOR

1ST FLOOR PLAN

2.65 X 3.67

TOILET KITCHEN 2.05 X 2.60

3.45 X 0.90

VENTILATION

2.03 X 1.20

1.30 D1 1.00 X 0.90 X 0.90

KITCHEN

2.10 X 2.07

TOILET 1.82

M. BEDROOM - 2

2.70 X 3.48

BEDROOM

2.70 X 3.07

TOILET

ENCLOSED BALCONY 2.75 X 1.00

2.75 X 4.37

LIVING 2.75 X 3.55

CHAJJA @ 0.75 M

BEDROOM

2.65 X 3.67

ENCLOSED BALCONY 2.75 X 1.00

2.75 X 3.55

CHAJJA @ 0.75 M 1.000 CHAJJA № 0.13.11

2.05 X 2.60 | 1.05 | M. BEDROOM - 2

7 TOILET 1.90 X 1.20


2.70 X 3.07


3.45 X 0.90


1.00 X 0.90 D1 X 0.90

2.10 X 2.07

VENTILATION

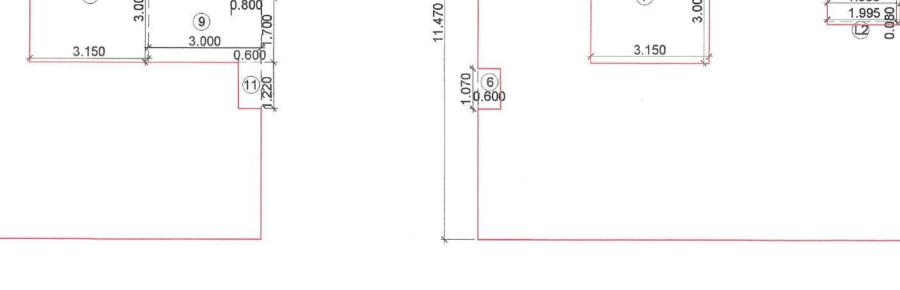

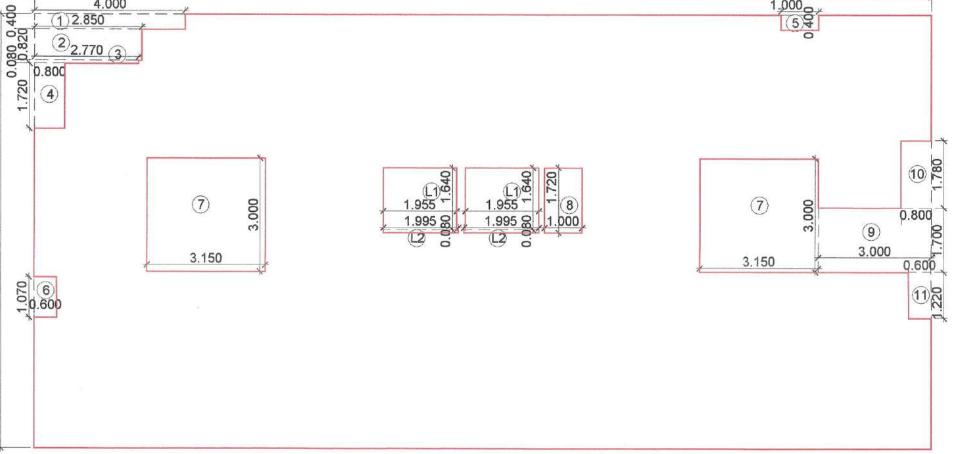

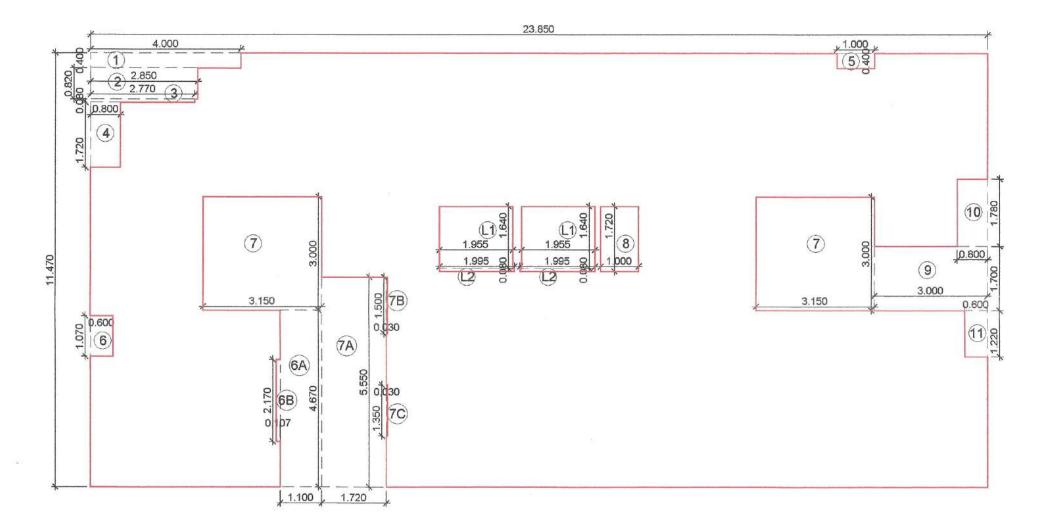

AREA CALCULATION OF 8TH FLOOR PLAN

8TH FLOOR PLAN



VENTILATION

TOILET 2.03 X 1.20

KITCHEN


2.10 X₁2.07

KITCHEN | TOILET | | 1.05 | M. BEDROOM - 2 | 2.75 X 2.87

3.45 X 0.90 D1 2.35 X 0.63

TOILET 2.10 X 1.20 V

2.70 X 3.07

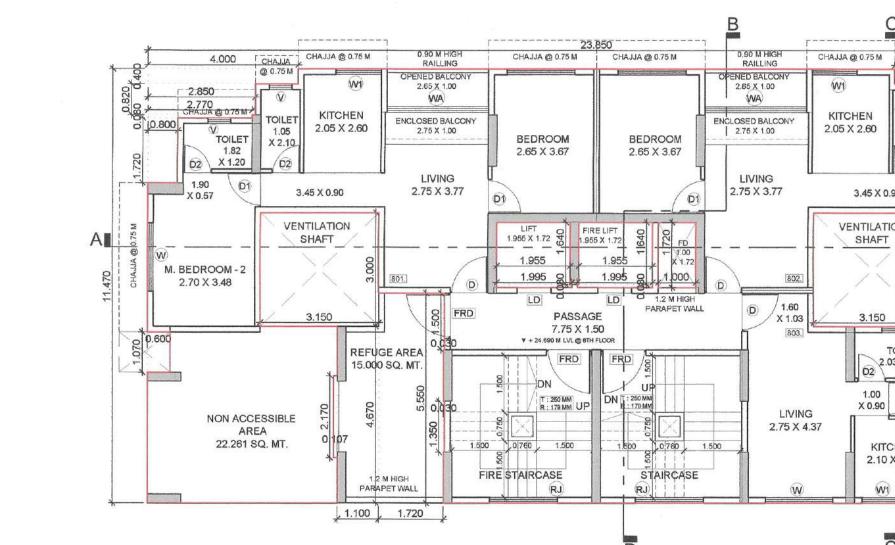

LEGENDS					
ITEM			SITE PLAN	BUILDING PLAN	
PLOT LINES					
EXISTING ST	REET				
FUTURE STR	EET				
BUILDING LIN	IE .				
FSI LINE					
MARGINAL O	PEN SPACES	NO COLOUI	R NO COLOUR		
DATE	JOB NO.	DRG NO.	SCALE	DRAWN BY	CHECKED BY
05/08/2024		03	AS SHOWN AS	AR.NILAM	de constante de des la constante de la constan

PROFORMA - II

DRAWING FOR BUILDING PERMISSION SHEET NO. 03_{01}

CONTENT: 1ST FLOOR PLAN, TYPICAL FLOOR (2ND TO 7TH, 9TH & 11TH) PLAN,

8TH FLOOR (REFUGE) PLAN, AREA DIAGRAM WITH STATEMENT, REFUGE AREA CALCULATION, LIGHT & VENTILATION STATEMENT, DOOR - WINDOW SCHEDULE

This Amended Commencement Certificate is

Commencement Certificate bearing no.

STAMP OF APPROVAL

approved subject to conditions mentioned in Amended

REFUGE 8TH FLOOR AREA CALCULATION

1.00

1.00

HEIGHT

0.400

0.820

0.080

1.720

0.400

1.070

4.670

2.170

3.000

5.550

1.500

1.350

1.720

1.700

0.080

273,560

2.337

0.400

5.137

18.900

5.100

6.411

6.730

56.183 217.376

217.376

1.00 23.850 11.470 273.560

2.850

2.770

0.800

1.000

0.600

1.100

0.107

3.150

1.720

0.030

0.030

1.000

3.000

0.800

1.955

1.995

0.600 1.220

TENEMENT & NO. OF UNITS STATEMENT.

CIDCO/NAINA/Panvel/Akurli/

BP- 00661/ACC/2024/0547

Dated: 19 Sep 2024

NUMBER

REFUGE 8TH FLOOR

1 A 1.00

TOTAL ADDITION

DEDUCTION

4 3

6 5

13 7C

14 8

15 9

16 10

DEDUCTION

TRIANGLE/

1.00

1.00

1.00

1.00

1.00

1.00

1.00

1.00

2.00

2.00

TOTAL AREA OF LIFT WELL

TOTAL BUILT UP AREA @ REFUGE 8TH FLOOR NET BUILT UP AREA @ REFUGE 8TH FLOOR

TOTAL DEDUCTION

DESCREPTION OF PROPOSAL AND PROPERTY

AMENDED DEVELOPMENT PERMISSION FOR PROPOSED RESIDENTIAL BUILDING ON FINAL PLOT NO. 23, TPS-01, AT AKURL TALUKA - PANVEL, DIST - RAIGAD.

NAME OF OWNER

M/s. KONKAN SHRUSTI INFRA DEVELOPERS LLP. BUILDING NO. 306, 2ND FLOOR MILLENNIUM BUSINESS PARK, SECTOR-2, KOPAR KHAIRANE, THANE,

CA/92/14485

For KONKAN SHRUSTI INFRA DEVELOPERS LLP

Authorised Partner M/s. Konkan Shrusti Infra Developers LLP. through Authorised Partner,

SIGNATURE, NAME OF LICENSED ARCHITECT

Mr. VIMAL DILIP SHAH.


NAVI MUMBAI. 400710.

ADDRESS OF LICENSED ARCHITECT **DEEPAK P. THAKARE**


> SECTOR-11,C.B.D-BELAPUR,NAVI MUMBAI,400614. PH.+9198 2006 0238 dpthakare@gmail.com

ARCHITECTS & PLANNERS

AREA CALCULATION OF TYPICAL FLOOR (1ST TO 7TH, 9TH & 11TH) PLAN

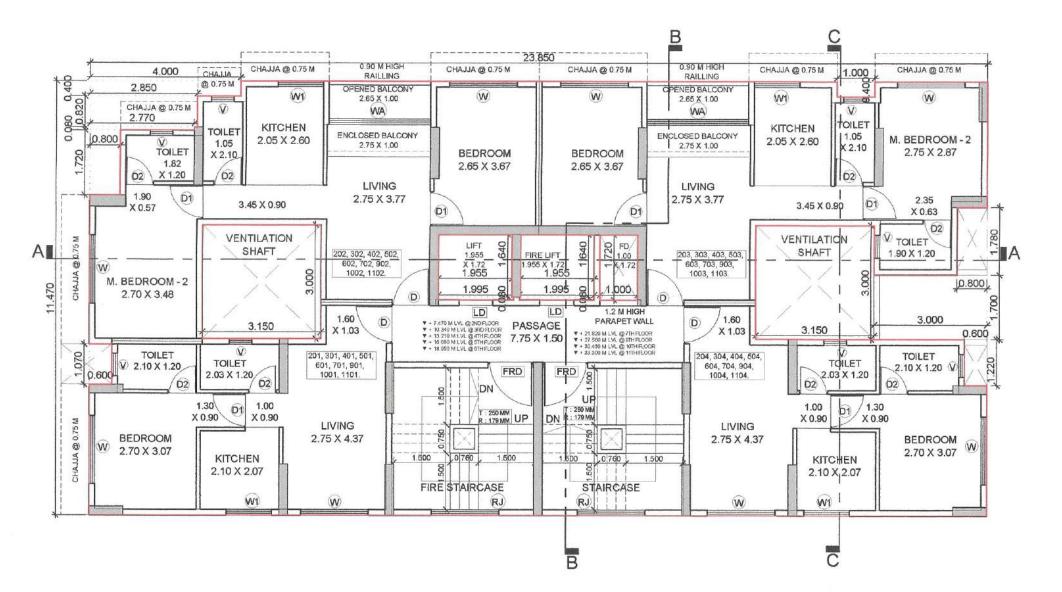



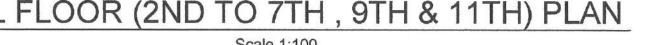





+ 40.260 PERMISSIBLE HT + 40.260 PERMISSIBLE HT +53.310 (AMSL). +53.310 (AMSL). +53.310 (AMSL) . O.H.WATER TANK (DOMESTIC USE) CAP: 43,965 LTR. 1.10 M. HT + 0.30 M. F.B. LIFT MACHINE ROOM LESS LIFT MACHINE + 39.870 TOP LVL (PROPOSED) +52.920 (AMSL) + 39.870 TOP LVL (PROPOSED) +52.920 (AMSL) + 39.870 TOP LVL (PROPOSED) +52.920 (AMSL) ROOMLESS LIFT MACHINE Dated: 19 Sep 2024 STAIRCASE ROOM ROOMLESS STAIRCASE ROOM TERRACE BRICK BAT COBA TERRACE + 36.170 TERRACE FLOOR +49.220(AMSL) TERRACE + 36.170 TERRACE FLOOR +49.220(AMSL) BRICK BAT COBA BRICK BAT COBA BRICK BAT COBA BRICK BAT COBA GLASS KITCHEN + 33.300 ELEVENTH FLOOR +46.350 (AMSL) + 33.300 ELEVENTH FLOOR +46.350 (AMSL) + 33.300 ELEVENTH FLOOR +46.350 (AMSL) LIVING ROOM LIVING ROOM GLASS H E KITCHEN ROOM + 30.430 TENTH FLOOR +43.480 (AMSL) + 30.430 TENTH FLOOR +43.480 (AMSL) + 30.430 TENTH FLOOR +43.480 (AMSL) LIVING ROOM LIVING ROOM TOILET ROOM GLASS HE KITCHEN + 27.560 NINETH FLOOR +40.610 (AMSL) + 27.560 NINETH FLOOR +40.610 (AMSL) + 27.560 NINETH FLOOR +40.610 (AMSL) LIVING ROOM LIVING ROOM 250 MM SUNK ROOM GLASS RE KITCHEN J' + 24.690 <u>EIGHTH FLOOR</u> +37.740 (AMSL) <u>(REFUGE)</u> + 24.690 <u>EIGHTH FLOOR</u> +37.740 (AMSL) <u>(REFUGE)</u> LIVING ROOM LIVING ROOM TOILET TOILET GLASS H.S. KITCHEN ROOM + 21.820 SEVENTH FLOOR +34.870 (AMSL) + 21.820 <u>SEVENTH FLOOR</u> +34.870 (AMSL) + 21.820 SEVENTH FLOOR +34.870 (AMSL) M. BEDROOM - 2 LIVING ROOM LIVING ROOM TOILET 250 MM SUNK GLASS REKITCHEN + 18.950 SIXTH FLOOR +32.000 (AMSL) + 18.950 SIXTH FLOOR +32.000 (AMSL) LIVING ROOM + 18.950 SIXTH FLOOR +32.000 (AMSL) LIVING ROOM TOILET GLASS H & KITCHEN ROOM M. BEDROOM - 2 + 16.080 FIFTH FLOOR +29.130 (AMSL) + 16.080 FIFTH FLOOR +29.130 (AMSL) + 16.080 FIFTH FLOOR +29.130 (AMSL) LIVING ROOM LIVING ROOM TOILET 250 MM SUNK 250 MM SUNK GLASS M. BEDROOM-2 GLASS TO KITCHEN ROOM + 13.210 FOURTH FLOOR +26.260 (AMSL) + 13.210 FOURTH FLOOR +26.260 (AMSL) LIVING ROOM TOILET LIVING ROOM ROOM GLASS KITCHEN LIVING ROOM TOILET + 10.340 THIRD FLOOR +23.390 (AMSL) LIVING ROOM TOILET GLASS THE KITCHEN I ROOM + 7.470 SECOND FLOOR +20.520 (AMSL) + 7.470 SECOND FLOOR +20.520 (AMSL) LIVING ROOM TOILET LIVING ROOM GLASS H & KITCHEN LIVING ROOM + 4.600 FIRST FLOOR +17.650 (AMSL) + 4.600 FIRST FLOOR +17.650 (AMSL) TOILET + 4.600 FIRST FLOOR +17.650 (AMSL) LIVING ROOM LIVING ROOM 250 MM SUNK + 1.005 PLINTH LVL +14.055 (AMSL) + 1.005 PLINTH LVL +14.055 (AMSL) + 0.150 STILT / PARKING LVL +13.200 (AMSL) SOCIETY + 0.150 STILT / PARKING LV +13.200 (AMSL) + 0.150 STILT / PARKING LVL +13.200 (AMSL) + 0.000 GROUND LVL +13.050 (AMSL) + 0.000 GROUND LVL +13.050 (AMSL) +13.050 (AMSL) - 0.150 FOOTPATH LVL +12.900(AMSL) <u>- 0.150</u> <u>FOOTPATH LVL</u> +12.900(AMSL) - <u>0.150</u> FOOTPATH LVL +12.900(AMSL) - 0.300 ROAD LVL +12.750 (AMSL) - 0.300 ROAD LVL +12.750 (AMSL) - 0.300 ROAD LVL +12.750 (AMSL) SECTION - AA' SECTION - BB' SECTION - CC' Scale 1:100 Scale 1:100 Scale 1:100 NORTH

DRAWING FOR BUILDING PERMISSION SHEET NO. 04

CONTENT : SECTIONS.

STAMP OF APPROVAL

This Amended Commencement Certificate is approved subject to conditions mentioned in Amended Commencement Certificate bearing no. CIDCO/NAINA/Panvel/Akurli/ BP- 00661/ACC/2024/0547

BUILDING	ROOM	TENEMENT NUMBER	CARPET AREA	WNDOW TYPE	L&V REQUIRED	L&V PROVIDED
	1	2	3	4	5=3/10	6
	LIVING		12.705	WA	1.271	6,129
	KITCHEN		5.330	W1	0.533	1.560
	BEDROOM		9.725	W	0.973	2.340
1	M. BEDROOM-1	202	10.479	W	1.048	2.340
	TOILET-1		2.340	V	0.234	0.540
	C. TOILET		2.205	V	0.221	0.540

		SCHED	ULE OF	DOORS 8	& WINDOWS
		SIZE		SILL	
TYPE	WIDTH	HEIGHT	AREA	(METER)	DESCRIPTION
	(METER)	(METER)	(SQM)		
1	2	3	4 = 2 X 3	5	6
D	1.000	2.270	2.270	0.000	T.W. FRAMED PANNELED DOOR
D1	0.900	2.270	2.043	0.000	T.W. FRAMED PANNELED DOOR
D2	0.750	2.270	1.703	0.000	T.W. FRAMED PANNELED DOOR
w	1.800	1.300	2.340	0.370	ALUMINIUM SLIDING FRENCH WINDOW
VV	1.800	0.600	1.080	0.570	FIXED GLASS WINDOW
WA	2.700	2.270	6.129	0.000	ALUMINIUM SLIDING FRENCH WINDOW
W1	1.200	1.300	1.560	0.370	ALUMINIUM SLIDING FRENCH WINDOW
441	1.200	0.600	0.720	0.570	FIXED GLASS WINDOW
W2	2.400	1.300	3.120	0.370	ALUMINIUM SLIDING FRENCH WINDOW
***	2.400	0.600	1.440	0.070	FIXED GLASS WINDOW
٧	0.600	0.900	0.540	1.370	ALUMINIUM LOUVERED WINDOW
FRD	1.200	2.270	2.724	0.000	FIRE RATED DOOR.
RJ	1.800	1.300	2.340	0.970	R.C.C. JALI.
RJ1	1.200	1.300	1.560	0.970	R.C.C. JALI.

PROFORMA - II

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05/08/2024		04	AS SHOWN AS	AR.NILAM	

DESCREPTION OF PROPOSAL AND PROPERTY

AMENDED DEVELOPMENT PERMISSION FOR PROPOSED RESIDENTIAL BUILDING ON FINAL PLOT NO. 23, TPS-01, AT AKURLI TALUKA - PANVEL, DIST - RAIGAD.

NAME OF OWNER

M/s. KONKAN SHRUSTI INFRA DEVELOPERS LLP. BUILDING NO. 306, 2ND FLOOR MILLENNIUM BUSINESS PARK, SECTOR-2, KOPAR KHAIRANE, THANE, NAVI MUMBAI. 400710. FOR KONKAN SHRUSTI INFRA DEVELOPERS LLP

M/s. Konkan Shrusti Infra Developers LLP. through Authorised Partner, Mr. VIMAL DILIP SHAH.



T DEEPAK P. THAKARE SHREE NAND-DHAM BLDG., A-509, PLOT NO 59, SECTOR-11,C.B.D-BELAPUR,NAVI MUMBAI,400614. PH.+9198 2006 0238 dpthakare@gmail.com CA/92/14485

ADDRESS OF LICENSED ARCHITECT

This Amended Commencement Certificate is Commencement Certificate bearing no. CIDCO/NAINA/Panvel/Akurli/ BP- 00661/ACC/2024/0547 Dated: 19 Sep 2024 + 40.260 PERMISSIBLE HT +53.310 (AMSL). O.H.WATER TANK (FIRE USE) CAP: 11,450 LTR. SIZE: 2.65 X 4.27 X 1.10 EXCLUDING 0.30 M F.B. O.H.WATER TANK (FIRE USE) CAP: 12,448 LTR. SIZE: 4.27 X 2.65 X 1.10 EXCLUDING 0.30 M F.B. O.H.WATER TANK (DOMESTIC USE) CAP: 43,965 LTR. 1.10 M HT + 0.30 M F.B. +53.310 (AMSL). C.H.WATER TANK (DOMESTIC USE) CAP: 43,965 LTR. 1.10 M HT + 0.30 M F.B. +53.310 (AMSL) . + 39.870 TOP LVL (PROPOSED) +52.920 (AMSL) LIFT____ MACHINE ROOMLESS LIFT MACHINE ROOMLESS STAIRCASE ROOM STAIRCASE ROOM LIFT MACHINE ROOM STAIRCASE ROOM NON ACCESSIBLE TERRACE NON ACCESSIBLE TERRACE + 33.300 ELEVENTH FLOOR +46.350 (AMSL) + 33.300 ELEVENTH FLOOR +46.350 (AMSL) + 30.430 TENTH FLOOR +43.480 (AMSL) + 30,430 TENTH FLOOR +43.480 (AMSL) + 27.560 NINETH FLOOR +40.610 (AMSL) + 27.560 NINETH FLOOR +40.610 (AMSL) + 27.560 NINETH FLOOR +40.610 (AMSL) SCHEDULE OF DOORS & WINDOWS REFUGE AREA + 24,690 EIGHTH FLOOR +37.740 (AMSL) (REFUGE) + 24.690 EIGHTH FLOOR +37.740 (AMSL) (REFUGE) TYPE WIDTH HEIGHT AREA (METER)
(METER) (METER) (SQM) + 21.820 SEVENTH FLOOR +34.870 (AMSL) 0.000 T.W. FRAMED PANNELED DOOR. + 21.820 SEVENTH FLOOR +34.870 (AMSL) + 21.820 SEVENTH FLOOR +34.870 (AMSL) FIXED GLASS WINDOW ALUMINIUM SLIDING FRENCH + 18.950 SIXTH FLOOR +32.000 (AMSL) + 18.950 SIXTH FLOOR +32.000 (AMSL) 1.200 0.600 0.720 FIXED GLASS WINDOW ALUMINIUM SLIDING FRENCH 2.400 0.600 1.440 FIXED GLASS WINDOW + 16.080 FIFTH FLOOR +29.130 (AMSL) FRD 1.200 2.270 2.724 0.000 FIRE RATED DOOR. + 16.080 FIFTH FLOOR +29.130 (AMSL) RJ 1.800 1.300 2.340 0.970 R.C.C. JALI. RJ1 1.200 1.300 1.560 0.970 R.C.C. JALI. PROFORMA - II + 13.210 FOURTH FLOOR +26.260 (AMSL) + 10.340 THIRD FLOOR +23.390 (AMSL) + 7.470 SECOND FLOOR +20.520 (AMSL) DESCREPTION OF PROPOSAL AND PROPERTY + 4.600 FIRST FLOOR +17.650 (AMSL) AMENDED DEVELOPMENT PERMISSION FOR PROPOSED + 4.600 FIRST FLOOR +17.650 (AMSL) + 4.600 FIRST FLOOR +17.650 (AMSL) TALUKA - PANVEL, DIST - RAIGAD. NAME OF OWNER + 1.005 PLINTH LVL +14.055 (AMSL) M/s. KONKAN SHRUSTI INFRA DEVELOPERS LLP. + 0.150 STILT / PARKING LVL +13.200 (AMSL) + 0.150 STILT / PARKING LVI +13.200 (AMSL) BUILDING NO. 306, 2ND FLOOR MILLENNIUM BUSINESS PARK, SECTOR-2, KOPAR KHAIRANE, THANE, For KONKAN SHRUSTI INFRA DEVELOPERS LLP + 0.000 GROUND LVL +13.050 (AMSL) + 0.000 GROUND LVL +13.050 (AMSL) NAVI MUMBAI. 400710. FOR, Alima - 0.150 FOOTPATH LVL +12.900(AMSL) - 0.150 FOOTPATH LVL +12.900(AMSL) - 0.150 FOOTPATH LVL +12.900(AMSL) - 0.300 ROAD LVL +12.750 (AMSL) - 0.300 ROAD LVL +12.750 (AMSL) - 0.300 ROAD LVL +12.750 (AMSL) M/s. Konkan Shrusti Infra Developers LLP. through Authorised Partner, Mr. VIMAL DILIP SHAH. REAR SIDE ELEVATION 20.00 M WIDE ROAD SIDE ELEVATION 15.00 M WIDE ROAD SIDE ELEVATION SIGNATURE, NAME OF ADDRESS OF LICENSED ARCHITECT LICENSED ARCHITECT DEEPAK P. THAKARE
ARCHITECTS & PLANNERS Scale 1:100

DRAWING FOR BUILDING PERMISSION SHEET NO. 05/05

CONTENT : ELEVATIONS.

STAMP OF APPROVAL

approved subject to conditions mentioned in Amended

BUILDING	ROOM	TENEMENT NUMBER 2	CARPET AREA	WINDOW TYPE	L&V REQUIRED 5=3/10	L&V PROVIDED
	1					
1	LIVING	202	12.705	WA	1.271	6.129
	KITCHEN		5.330	W1	0.533	1.560
	BEDROOM		9.725	w	0.973	2.340
	M. BEDROOM-1		10.479	W	1.048	2.340
	TOILET-1		2.340	٧	0.234	0.540
	C. TOILET		2.205	V	0.221	0.540

LEGENDS	5					
ITEM		SITE PLAN	BUILDING PLA			
PLOT LINES			_			
EXISTING ST	REET					
FUTURE STR	EET					
BUILDING LIN	NE					
FSI LINE						
MARGINAL O	PEN SPACES	NO COLOU	R NO COLOUR			
DATE	JOB NO.	DRG NO.	SCALE	DRAWN BY	CHECKED BY	
05/08/2024		05	AS SHOWN AS	AR.NILAM	***************************************	
	DESC	DEPTION C	DE PROPOSAL AL	ND PROPERTY		

RESIDENTIAL BUILDING ON FINAL PLOT NO. 23, TPS-01, AT AKURLI,

AR. DEEPAK THAKARE CA/92/14485

SHREE NAND-DHAM BLDG., A-509, PLOT NO 59, PH.+9198 2006 0238 dpthakare@gmail.com