

PROPOSED PARKING SPACES

12.5 SQ.M.

25MX 5.0M

504.96

504.96

504.96

504.96

504.96

40.01

28.99

28.75

605.57

619.74

605.57

619.74 2548.37 2.0 SQ.M.

1.0MX 2.0M

SANCTION IDP MAP

(SCALE: NTS)

TP	S FINA	L PL	E ON TO	7 ARI	EA CALC	CULAT	ION
1	0.5	X	10.050	х	0.478	=	2.402
2	0.5	Х	10.05	X	4.577	=	22.999
3	0.5	X	26.781	Х	8.038	=	107.633
4	0.5	X	34.798	X	14.32	=	249.154
5	0.5	Х	39.781	X	5.363	=	106.673
6	0.5	X	11.925	х	39.781	=	237.194
7	0.5	Х	36.357	X	9.056	=	164.624
8	0.5	Х	36.357	х	12.963	=	235.648
9	0.5	X	36.868	X	13.936	=	256.896
10	0.5	X	36.868	X	9.072	=	167.233
11	0.5	X	34.536	X	10.349	=	178.707
12	0.5	Х	33.947	х	8.437	=	143.205
13	0.5	Х	39.035	Х	4.435	=	86.560
14	0.5	х	39.035	Х	10.999	=	214.673
15	0.5	Х	35.93	Х	1.208	=	21.702
16	0.5	Х	35.661	Х	3.361	=	59.928
17	0.5	Х	47.353	х	23.505	=	556.516
18	0.5	Х	47.353	Х	21.382	=	506.251
	1	TOTAL	AREA OF PL	ОТ		=	3317.999
						SAY =	3318.000

O Bridge Company of the Company of t	
8-038 8-038	
39.787	
36.367	
98	
36.868	
34.536	
9.33.947 9.33.947 9.39.035 9.39.035	
MIDE	\
7PS 15 M	/

TPS F P NO 37 CALCULATION BY TRIANGULATION

AREA = 3318.00 SQ.M.

Sr	.No.	Item	Site Plan On
O.	., 10.	item	White Print
C)1.	Plot Line	
C)2.	Proposed TPS-5 Road	
C)3.	Internal Layout Road	
C)4.	Building Line	
C)5.	FSI /Built up Line	
C	06.	TILR Map	
C	07.	Car Parking	EJ
C	08.	Two Wheeler Parking	
(09.	Future tree	
1	10.	Open space	BAKK
	11	PLOT BOUNDRY AS	

PER ACC IN 2021 AREA=3318 SQ.M

3912.526

3318.000 3318.000

0.000

12. FINAL APPROVED PLOT BY TPS SECTION NAINA

a Area of Plot (as per 7/12) and NA order
b Area of Plot as per TILR (by triangulation method at true scale)

Area of survey no. 16/22/3

d Final area of plot as per TPS 5

a Existing road (ROW)

Area of Plot as per Physical Survey

e Area of plot considered {least of (a), (b),(c) and (d)}

		Existing road (ROW)				0.000					
2	b	Proposed widening of existing road				0.000					
2	С	Proposed road as per TILR(IDP/TPS-5	ROAD RESER	RVATION)		482.000					
	d	Area under reservation, if any				0.000					
		al (a+b+c+d)				482.000					
3	+	ance area of Plot (1-2)/Area of Plot No-	37 of TPS-5			3318.000					
4	_	enity Space, if any									
		Required Amenity Space (5% of 3)				0.00					
		Proposed Amenity Space				0.00					
5	_	Plot area (3-4b)				3318.00					
6	_	reational Open Space (If applicable)				2220.00					
-		Required RG/Open Space (10% of 5)				331.800					
		Proposed RG/open Space				339.025					
	_	al Entitlement of FSI in the proposal				555.025					
		Base FSI permissible				0.70					
		Premissible FSI with payment of pren	nimum (0.3)	1		0.30					
		TDR/ In-situ FSI	illinaiii (o.5	,		0.00					
7			ic)			0.60					
,		Ancillary FSI to sale BUA (60% on a+b+c) tal Permissible sale Built up area (7a+7b+7c+7d)									
				1011		1.60					
		Premissible EWS FSI (20% of permissi	DIE FSI(a+b-			0.00					
		Ancillary FSI to EWS BUA (60% on e)			1	0.00					
•		al Permissible EWS Built up area (7e+7f	1			0.00					
8	Per	misible Built up area									
	a	Permisible Built up area with refrenc				3318.00					
	$\overline{}$	Permissible Sale Built Up Area {(7a+7				5308.80					
	C	Permissible EWS Built Up area of (EW	Scompone	nt (20% of 8b)	including	0.00					
	1	ancillary (P line area)									
9		posed Built Up area									
	_	Proposed Sale Built Up Area (P-Line)				5073.170					
	b	Proposed Sale Built Up Area (with ref	frence to Ba	isic FSI, Premi	ium FSI, TDR)	3318.000					
	С	Consumed Ancillary FSI (Max 60% or 8				1755.170					
10	EWS	S flats details									
	a	Required EWS flats Built Up area (209	% of base &	premium cor	sume FSI) (0.2X	0.000					
	ь	Proposed EWS flats Built Up area									
	-	Proposed Built Up area of EWS compo	nent /D lin	ol .		0.000					
-	_	t up area Details	ment (P-III)	-		0.000					
	buil		Comm	Posi	Total cale	EVAC					
		Built up area	Comm	Resi	Total sale	EWS 0					
11	a	Total Proposed BUA (P line)	0.000	5073.170	5073.170						
	b	Net Proposed BUA (Excluding	0.000	3318.000	3318.000	0.000					
	С	Consume Ancillary BUA	0.000	1755.170	1755.170	0.000					
12	Pro	posed Built Up Area Details									
	а	Sale component (P line area)	gring half			5073.170					
	b	EWS component (P line area)				0					
13	Bala	ance Built Up Area (P- Line Area)									
	а	Sale component (12a-8b)				235.63					
		EWS component (12b-8c)									
14	+	ess Built Up Area of EWS flat (12b-8c)				0.00					
15	a	Total Built up sale Area including exce	ss EWS BUA	(12a+14)		5073.170					
	-	EWS Built up area after deducting exc				0.000					
16		al Ancillary area including ancillary of I				1755.17					
17		al FSI consumed	9								
		Sale component (15/5)				1.529					
		EWS component (10a/5)				0.000					
18	_	ance FSI									
		Sale component (7a+7b+7c+7d)-17a	19			0.071					
		EWS component (7e+7f)-17b				0.000					
	_	of units proposed									
	a					88					
19	1 "	Residential - Sale component									
	b	Residential - EWS component									
	_	Commercial	/1 tree for	over 100 cm	M	0 33					
		Trees to be planted against plot area				17					
	D	Trees to be planted against RG/open	space (5 tr	ee for evey 10	o sq. ivi.)						
	C	Existing trees				0					
20		Trees to be cut			11)//- 5)	0					
		Trees to be planted against tree fell (5 tree for e	very 1 tree fel	II) (d x 5)=	0					
	f	Total required trees (a+b+e)=				50					
	1 -	Existing Number of trees to be retain	(c-d)=			0					
	g					50					
	h	Req. Number of trees to be planted (PART OCCUPANCY CERTIFICATE)				30					



NOTES * ALL DIMENSIONS ARE IN METERS. * INTERNAL WALL THICKNESS 0.10 MM. * EXTERNAL WALL THICKNESS 0.15 MM.

SHEET NO.

Approved subject to the conditions mentioned in the Part Occupancy Certificate issued by this office bearing letter No.

CIDCO/NAINA/Panvel/Vihighar/BP-00387/OC/Part/ 2024/0529 Dated : 12 Jul 2024

	AREA STATEMENT FOR OCCUPANCY C	ERTIFICATE	
	(BUILDING NO-2)		
S.NO.	Description	Area (Sq.Mt.)	
1	Built up Area for which part occupancy is applied (Building No.2)	2548.370	
2	Additional Built Up area as per site inspection & as-Built dwg 2	2548.370	
3	Total no. of units constructed		
	a) Residentcial	48 Nos.	
	Tree	50 Nos.	
	Total No.Of Parking Provided		
	a)Four wheeler	18 Nos.	
	b) Two wheeler	48 Nos.	

CERTIFICATE OF AREA

CERTIFIED THAT I HAVE SURVEYED THE PLOT BEARING G.NO. 16/22/3 AT VILLAGE -VIHIGHAR , TAL- PANVEL DATED :13-11-2018 AND THAT THE DIMENSIONS OF SIDE ETC. OF PLOT STATED ON THE PLAN ARE AS MEASURED ON SITE AND THE AREA SO WORKED OUT IS 3912.526 SQ.M.

MR. TEJAS RAJNIKANT SHAH.

JEETENDRA PARMAR STATE/R/2022/APL/02047

STATE/R/2022/APL/02047

FORM OF CERTIFICATE.

I Jetendra Parmar have been employed by the applicant as Licensed engineer. I have examined the boundaries and the area of the plot and i do hereby certify that ,I have personally verified and checked all the statements made by the applicant who is the owner /Developer in possession of the plot in the above form and found them to be correct. JEETENDRA PARMAR

PROJECT:
PLAN OF A PROPOSED RESIDENTIAL BUILDINGS 1 AND 2, IN G. NO. 16/22/3, AT AT VILLAGE - VIHIGHAR TAL.- PANVEL, DIST.- RAIGAD. OWNER:

JEETENDRA PARMAR


AND ASSOCIATES




prratham/sub

JPA/C+R/019/2004 ARCHITECTURE ENGINEERING


A-101, "KANDPILE RESIDENCY", NEAR M.S.E.B. & FOREST OFFICE, SCALE TAKKA, PANVEL- 410206 AS SHOWN Email: jeetendra_parmar2000@yahoo.com DRN. BY Ar Rutvija

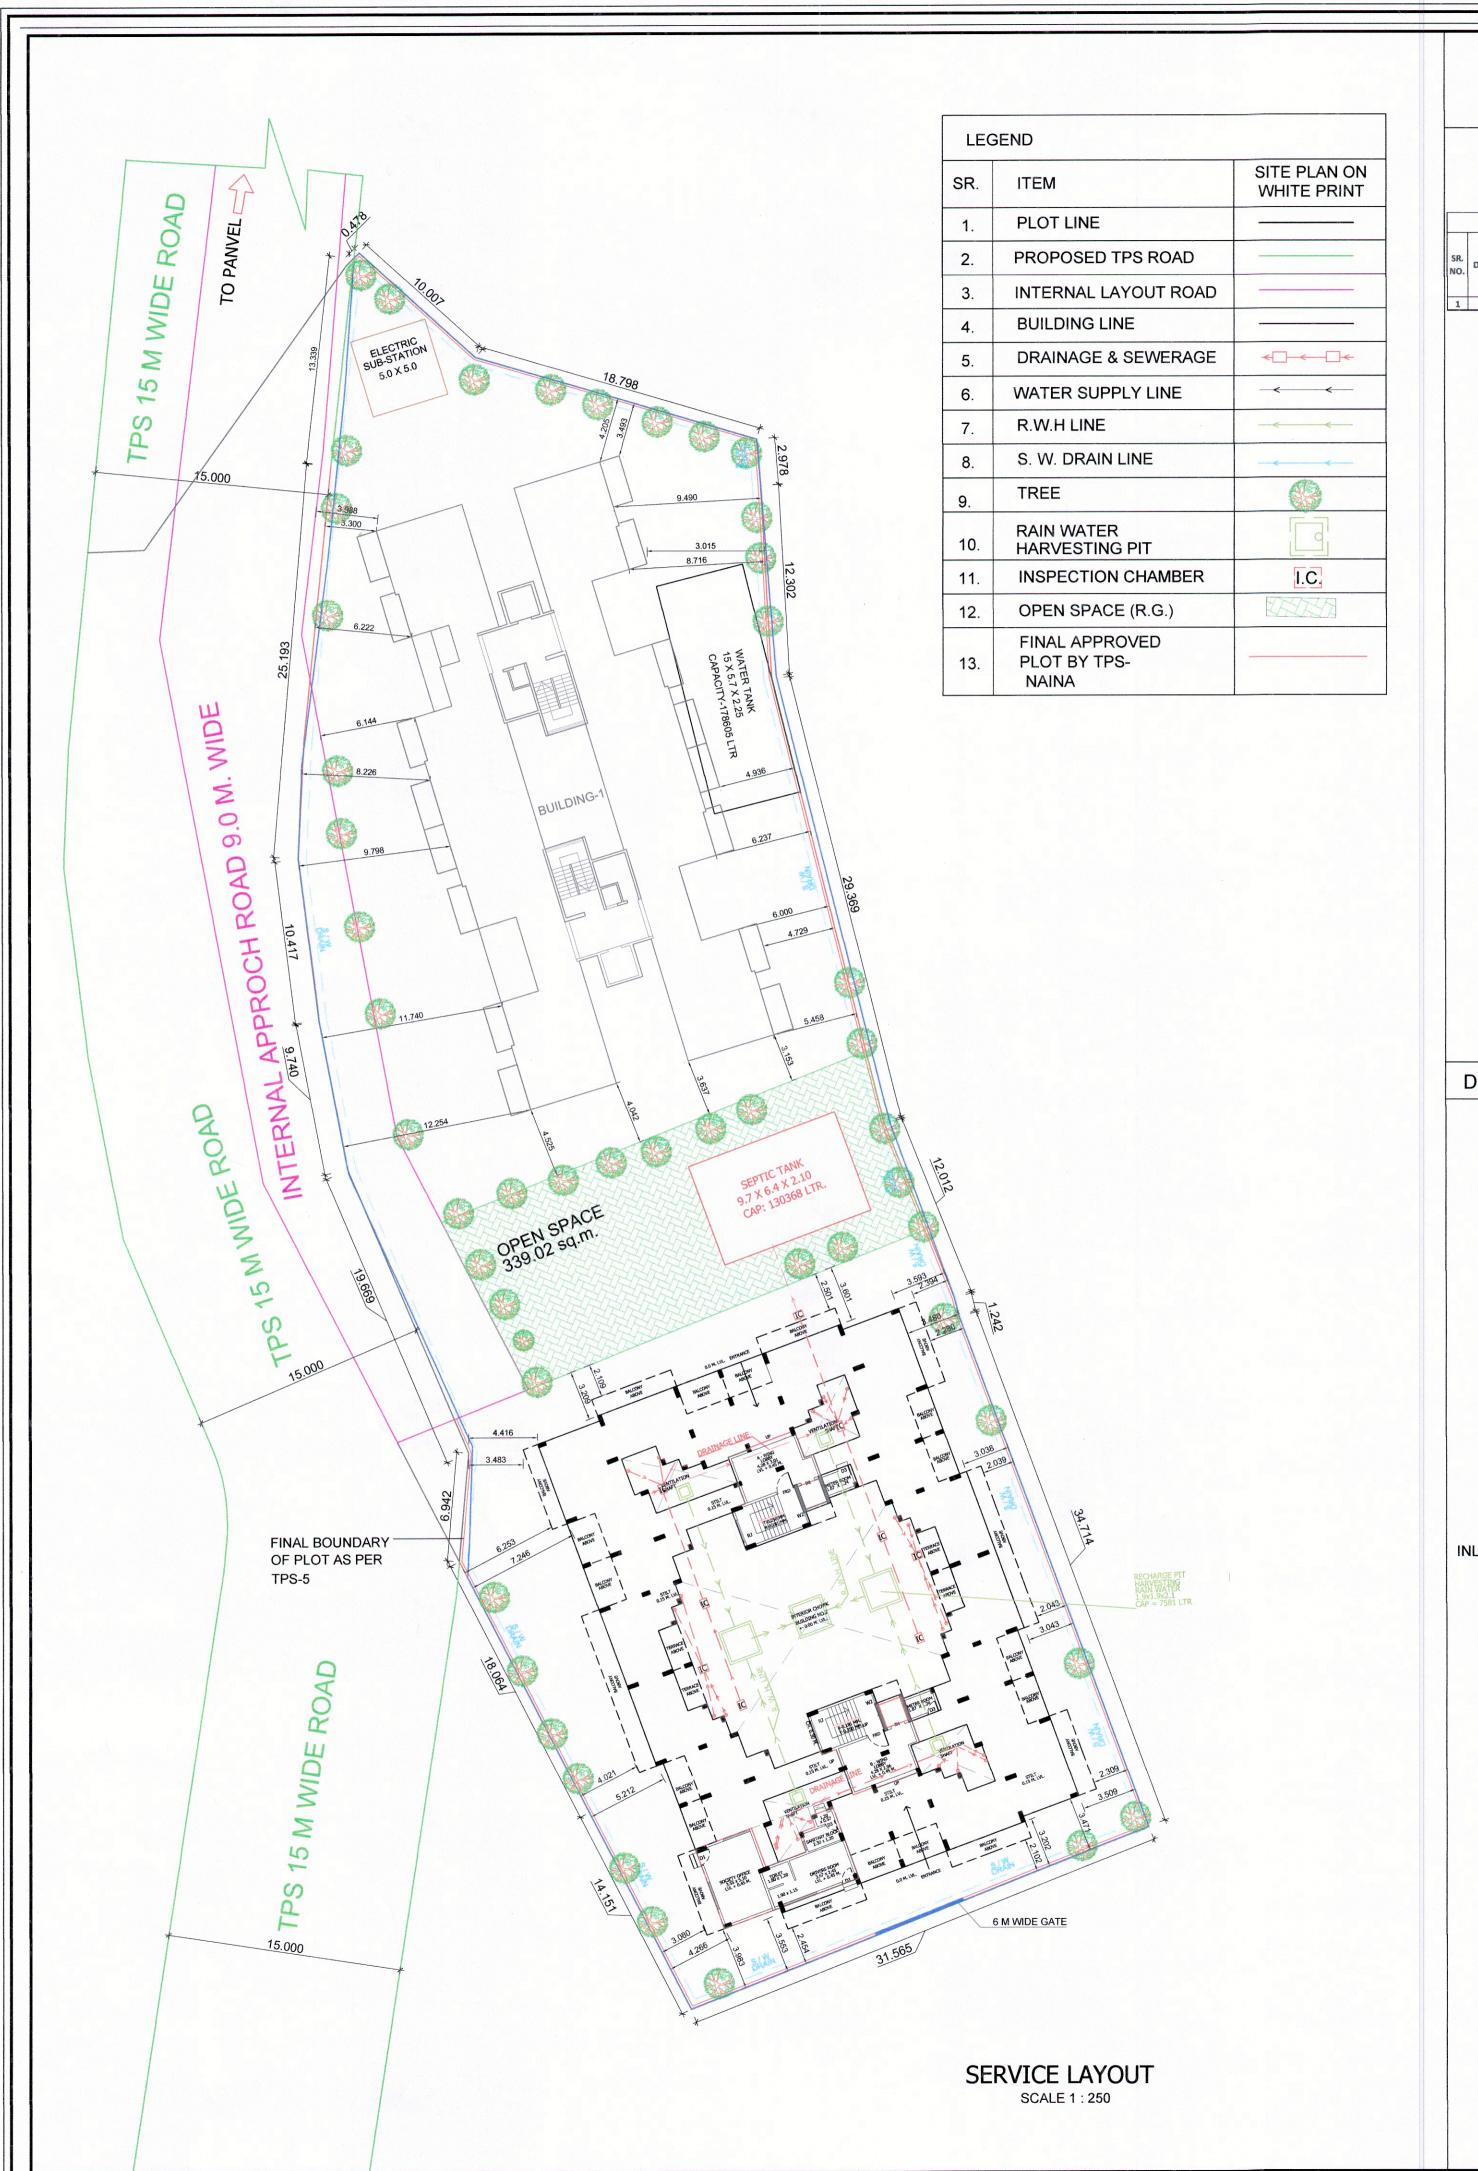


DETAILS OF SEPTIC TANK & SOAK PIT

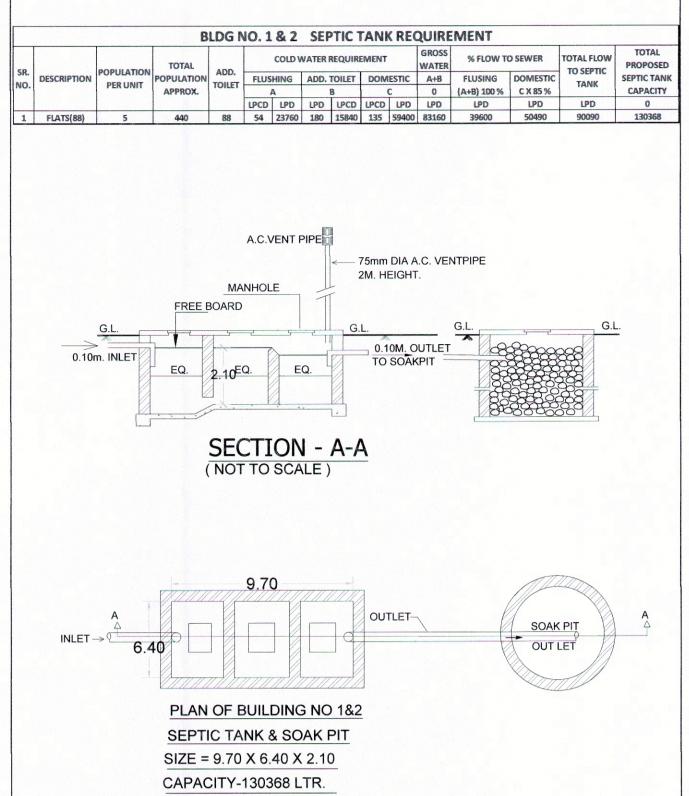

DETAILS OF RAIN WATER HARVESTING

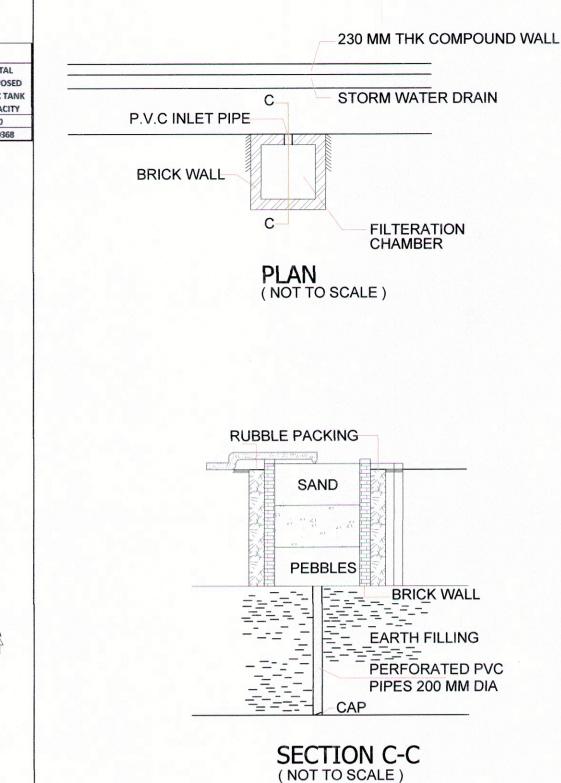



DETAILS OF U/ G WATER TANK

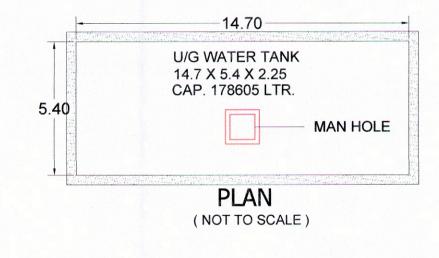

(NOT TO SCALE)

		BL	DG NO.1 &	2 WATER	STORAGE CA	PACITY CALC	CULATIO	N (U	S TA	NK)			
TOTAL				WATER	REQUIRMENT (UNDER GROUND WATER TANK PROVIDED							
/ WING	WING NUMBER TOILET POPULATION ADDL. TOILET CAP.		CAPACITY PERHEAD	TOTAL	L TANK NUMBER SIZE / DIMEN			SION		CAPACITY LITER			
[1]	[2]	[3]	[4]	[5]	[6]	[7]	[8]			[9]			[10]
			= [2] X 5	= [3] X 180	= [4] X 189	= [5] + [6]						100	
			BUIL	DING NO. 1				14.70	Х	5.40	Х	2.25	178.605
1-C	20	20	100	3600	18900	22500		14.70 A 3.40 A 2.23		2.20	170.000		
1-D	20	2.0	100	3600	18900	22500	1						
BUILDING NO. 2									ED	EE BOA	200	O MET	ED
2-A	24	16	120	2880	22680	25560		FREE BOARD 0.20 METER			LIN		
2-B	24	16	120	2880	22680	25560			-24				
TOTAL	88	72	440	12960	83160	96120			C	APACIT	Y		178605

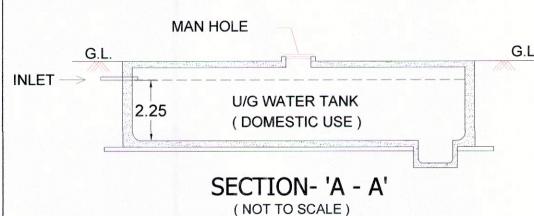

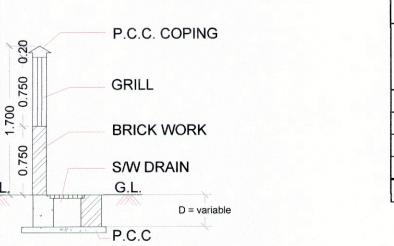

TYPICAL SECTION OF COMPOUND WALL / S.W. DRAIN LINE (NOT TO SCALE)

	WATER			OVI	ERHEA	D WATE	R TANK PRO	VISION
BUILDING	REQUIRED		TABII	/ CI7E / N	4CTCD	NUMBER	PROPOSED CAPACITY	
	(LITRE)		IAM	(SIZE (N	VIETER	,	OF TANK	(LITRES)
[1]	[2]			[3]			[4]	[5]
С	15750	4.40	Х	2.50	Χ	3.25	1	35750
D	15750	4.40	Х	2.50	Χ	3.25	1	35750
		ТОТ	AL				=	71500
NOTE 1 :- I	REQUIRED O	HT CAP	. = 50	% OF U.	G. TAN	IK CAPA	CITY	
	REQUIRED O							= 35000 LITRES.

	WATER			OVE	ERHEA	D WATE	R TANK PRO	VISION
BUILDING	REQUIRED		TABLE	SIZE (N	NUMBER	PROPOSED CAPACITY		
	(LITRE)		IAIVI	(SIZE (IV	/IE I ER	,	OF TANK	(LITRES)
[1]	[2]		[3]				[4]	[5]
Α	12780	4.15	Х	2.50	Х	2.05	1	21269
В	12780	4.15	Х	2.50	Х	2.05	1	21269
		TOT	AL				=	42538

SHEET NO.


STAMP OF APPROVAL

Approved subject to the conditions mentioned in the Part Occupancy Certificate issued by this office bearing letter

CIDCO/NAINA/Panvel/Vihighar/BP-00387/OC/Part/2024/ 0529 Dated : 12 Jul 2024

PART OCCUPANCY CERTIFICATE IS FOR BUILDING NO.2 ONLY (G+4)

SANCTION IDP MAP

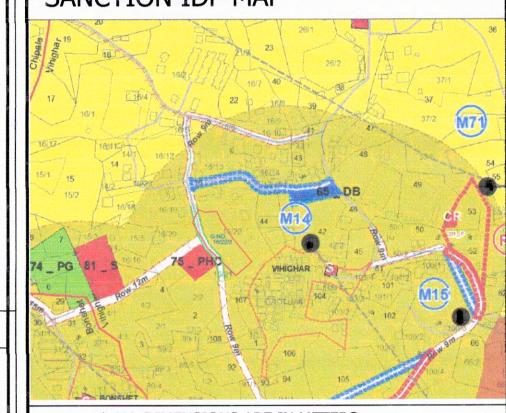

NOTE * ALL DIMENSIONS ARE IN METERS. * INTERNAL WALL THICKNESS 0.10 MM. * EXTERNAL WALL THICKNESS 0.15 MM.

CONTENT OF SHEET

LAYOUT PLAN, PARKING REQUIREMENT, BLOCK PLAN, PLOT AREA

CERTIFICATE OF AREA

CALCULATION BY TRANGULATION.

CERTIFIED THAT I HAVE SURVEYED THE PLOT BEARING G.NO. 16/22/3 AT VILLAGE VIHIGHAR , TAL- PANVEL DATED :13-11-2018 AND THAT THE DIMENSIONS OF SIDE

ETC. OF PLOT STATED ON THE PLAN ARE AS MEASURED ON SITE AND THE AREA SO

MR. TEJAS RAJNIKANT SHAH.

WORKED OUT IS 3912.526 SQ.M.

JEETENDRA PARMAR STATE/R/2022/APL/02047 (SIGN. OF LICENSED ENGINEER

FORM OF CERTIFICATE.

Jetendra Parmar have been employed by the applicant as Licensed engineer. I have examined the boundaries and the area of the plot and i do hereby certify that ,I have personally verified and checked all the statements made by the applicant who is the owner /Developer in possession of the plot in the above form and found them to be correct.


MR. TEJAS KAJNIKANT SHAH.

JEETENDRA PARMAR STATE/R/2022/APL/02047 (SIGN. OF LICENSED ENGINEER)

PROJECT:

PLAN OF A PROPOSED RESIDENTIAL BUILDINGS IN G. NO. 16/22/3, AT VILLAGE - VIHIGHAR, TAL.- PANVEL, DIST.- RAIGAD.

ARCHITECT / ENGINEER NAME & SIGN

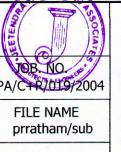

SCALE

AS SHOWN

JEETENDRA PARMAR AND ASSOCIATES

ARCHITECTURE ENGINEERING

> A-101, "KANDPILE RESIDENCY", NEAR M.S.E.B. & FOREST OFFICE, TAKKA, PANVEL- 410206 Email: jeetendra_parmar2000@yahoo.com

