

SANCTIONED IDP MAP SCALE : NTS

8 TOTAL EXCESS TERRACE

537.084


LAYOUT PLAN SCALE 1:200

TOTAL BUILTUP AREA


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Location Plan SCALE 1 : 2000

1	* TOTAL AREA STATEMENT										
1	2	3	4	3	DDOD	OCED DAI	CONV	9	10	11	12
SR.	SR. NIII PRIOS	PROPOSED	PERMISSIBLE			POSED BALCONY			PERMISSIBLE	PROPOSED	EXCESS
NO. BUILDINGS	BUILDINGS	AREA	BALCONY AREA	ENCL	OSED	OPEN	TOTAL	EXCESS	TERRACE AREA	TERRACE	enses di uma sama
			(15% OF 3)	OPEN	CLOSE	OTE	(5+6+7)	(8 - 4)	(20% OF 3)	AREA	
1	GROUND	21.430	3.214	0.00	0.00	0.00	0.00	0.00	4.286	0.000	0.00
2	FIRST	144.092	21.614	10.40	10.40	0.00	20.80	0.00	28.818	18.593	0.00
3	SECOND	144.092	21.614	10.40	10.40	0.00	20.80	0.00	28.818	16.530	0.00
4	THIRD	144.092	21.614	10.40	10.40	0.00	20.80	0.00	28.818	18.593	0.00
5	FORTH	83.378	12.507	5.20	5.20	0.00	10.40	0.00	16.676	8.265	0.00
6	TOTAL	537.084	80.563	72.	800	0.000	72.800	0.000	107.416	61.981	0.00
7	TOTAL EXCESS BALC	0.000	1								

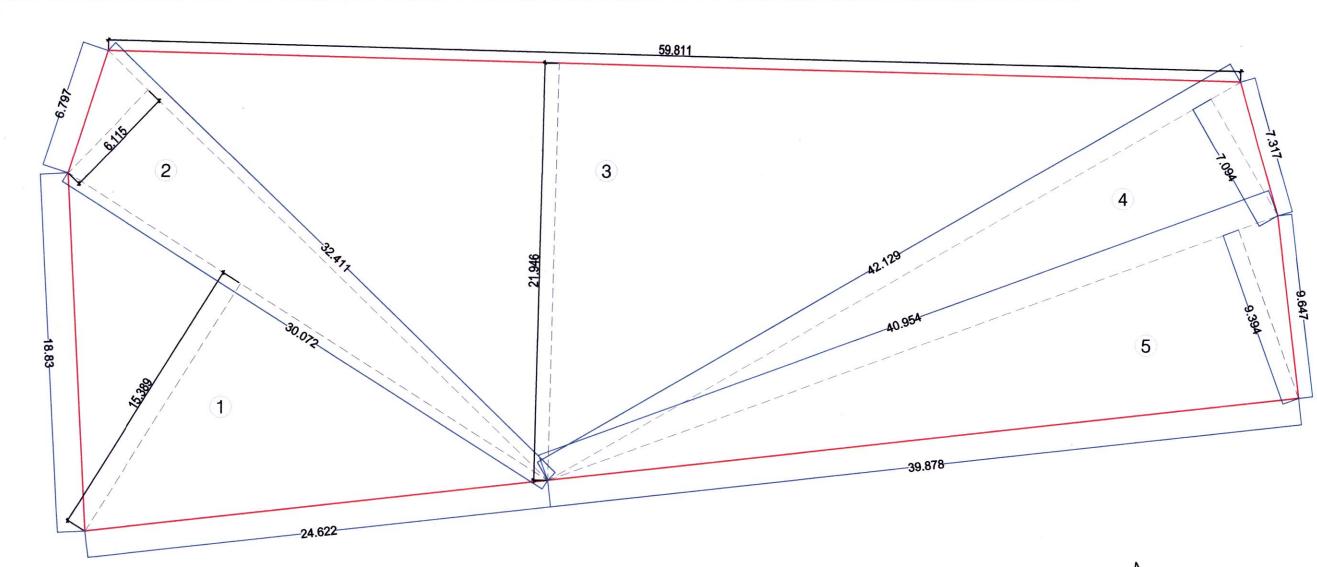

TILR AREA DAIGRAM (1328 SCALE 1: 200 SEPTIC TANK SUZE-3.0 X 2.0 CAP- 12.000 LITERS	12.0 M. WIDE BUILDING LINE FROM EXISTING ROAD C/L.	
OUT LET	Compound wall 14.172 SUPPORTED TERRACE GOVE SAL METER ROOM 3 SUPPORTED TERRACE GOVE STERRACE GOV	12.000 6.000 14.898 BUM MOS P 15.700 EXISTING GRAMPA 15.700
27.801	SUPPORTED TERRACE (2) 157 & 3RD FLR. SUPPORTED TERRACE (2) 157 & 3RD FLR. PARTILL BNC: SAL ABOVE TANKSEE 1 SUPPORTED TERRACE (2) 157 & 3RD FLR. PARTILL BNC: SAL ABOVE TANKSEE 1 SUPPORTED TERRACE (2) 157 & 3RD FLR. SU	16.257 ROAD 17.877
10.55	21.412 12.0 M. WIDE BUILDING LINE FROM EXISTING ROAD C/L.	12.000

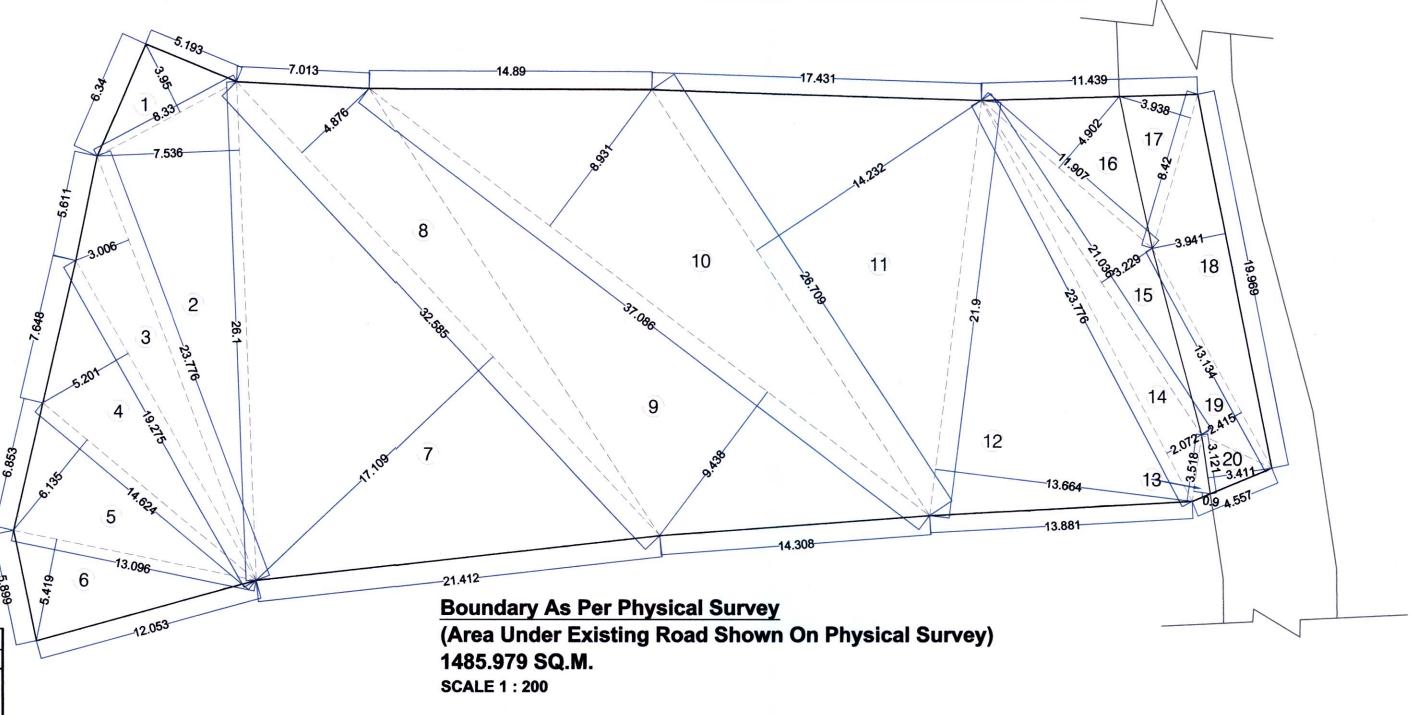

			A. AREA	UN	DER PLOT	
1	(0.500	x	8.330	x	3.950	16.452
2	0.500	x	26.100	x	7.536	98.345
3	0.500	x	23.776	x	3.006	35.735
4	0.500	x	19.275	x	5.201	50.125
5	0.500	x	14.624	x	6.135	44.859
6	0.500	x	13.096	X	5.419	35.484
7	0.500	x	32.585	x	17.109	278.748
8	0.500	x	32.585	x	4.876	79.442
9	0.500	x	37.086	x	9.439	175.027
10	0.500	x	37.086	x	8.931	165.607
11	0.500	x	26.709	x	14.232	190.061
12	0.500	x	21.900	x	13.664	149.621
13	0.500	x	3.518	x	0.900	1.583
14	0.500	x	23.776	x	2.072	24.632
15	0.500	x	21.036	x	3.229	33.963
16	0.500	x	11.907	x	4.902	29.184
	ARE	ΑL	INDER PLO)TC	A)=	1408.868
	В.	AR	EA UNDE	RE	XISTING RO	AD
17	0.500	X	8.420	X	3.938	16.579
18	0.500	X	19.969	X	3.941	39.349
19	0.500	X	13.134	X	2.415	15.859
20	0.500	X	3.121	X	3.411	5.323
OTA	L AREA	UN	IDER EXIS	TIN	G ROAD(B)=	77.110
	TOTAL	AR	EA OF PLO	T (A)+(B)=	1485.978

		Т	ILR AREA	A ST	ATEMENT	
			A. AREA	UND	ER PLOT	
1	0.500	x	30.072	x	15.389	231.38
2	0.500	x	32.411	x	6.115	99.09
3	0.500	x	59.811	x	21.946	656.30
4	0.500	x	42.129	x	7.094	149.43
5	0.500	x	40.954	x	9.394	192.36
			TOTAL (A)		1328.58

Room
XOOM .

a) AREA FO THE PLOT (as per 7/12)	1200.000
b) AREA OF THE PLOT (as per triangulation plan of TILR at true scale)	1328.585
c) AREA FO THE PLOT (as per physical survey)	1485.979
AREA OF PLOT, CONSIDERED {least of (a), (b) & (c)}	1200.000
[A] AREA STATEMENT FOR PLOT OUTSIDE 200M GAOTHAN BOUNDARY	
1 AREA OF THE PLOT	1200.000
DEDUCTION FOR	
2 A) Existing Road acquisition Area	77.110
B) Proposed Road	NIL
C) Any Reservation (IDP)	NIL
TOTAL = (A + B + C)	77.110
3 GROSS AREA OF THE PLOT (1 - 2A)	1122.890
4 DEDUCTION FOR AMENITY SPACE, IF ANY	
5 R.G / OPEN SPACES REQUIRED	
6 NET AREA OF PLOT = (3 - 4)	1122.890
7 PERMISSIBLE FSI	0.50
8 PERMISSIBLE BUILT UP AREA (6 x 7)	561.445
9 R.G / OPEN SPACES PROVIDED	
10 PROPOSED BUILT UP AREA	537.084
11 BALANCE BUILT UP AREA (8 - 10)	24.361
12 FSI CONSUMED (10 / 6)	0.478
13 FSI BALANCE (7 - 12)	0.022
14 NO. OF UNITS PROPOSED	14
a) RESIDENTIAL	14
b) COMMERCIAL	0
15 NO OF TREES PROPOSED TO BE PLANTED	14
16 TOTAL AREA STATEMENT	*
17 TDR	NA
a) PERMISSIBLE	
b) PROPOSED TO BE UTILISED	
18 PARKING STATEMENT	**

PROFORMA - I

AREA STATEMENT


a) PARKING REQUIRED

b) PARKING PROVIDED

METER ROOM AREA CALCULATION (SCALE 1:100)


		METER RO	OOM AREA	A CALCULA	TION				
SR. NO. NUMBER		NUMBER OF DEDUCTION	1/2	BASE (M)	HEIGHT (M)	AREA (IN SQ.M.)			
(1)	(2)	(3)	(4)	(5)	(6)	(7)=3X4X5X6			
		TYPICAL 1ST TO	3RD FLOC	R AREA CA	LCULATION				
1	Α	1	1	3.080	4.600	14.168			
	SUB TOTAL(A) =								

		**Parking Area S	tatemen	t		
Sr. No.	Occupancy	One Parking for Every	Number	Standard	Parking type	
31.110.		One raiking for Every	of units	Car	Car	Scooter
(1)	(2)	(3)	(4)	(5)=(3)x(4)	(6)	(7)
1	4 tenements having carpet area upto 35 sq.m. each.	0.25	14	3.5	4	
		Subtotal Parking required			4	
	Visitor I	Parking 10% of above (16	X 10%)		1	
		Total Parking Required	••••••••••••••••••••••••••••••••••••••		5	7
	6	8				
VII	Note: No. of Scoo	ter Parking = (No. of Car) X (2 i.e. Area of Scoote	5 - Sept. 180	ea of parking) X (10%) /	

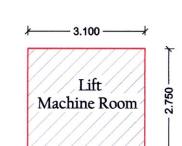

LIFT MACHINE ROOM AREA CALCULATION (SCALE 1:100)

		METER RO	DOM AREA	A CALCULA	TION				
SR. NO.	NUMBER	NUMBER OF DEDUCTION	1/2	BASE (M)	HEIGHT (M)	AREA (IN SQ.M.)			
(1)	(2)	(3)	(4)	(5)	(6)	(7)=3X4X5X6			
		TYPICAL 1ST TO	3RD FLOC	R AREA CA	LCULATION				
1	Α	1	1	3.100	2.750	8.525			
	1 A 1 1 3.100 2.750 SUB TOTAL(A) =								

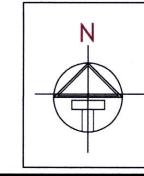

OTAWII	O.	<i>/</i> (I	•	110	V /	•
is OC as	s bu	ilt d	ra	wir	na	

SHEET

1/3

STAMP OF APPROVAL

bearing no.

This is OC as built drawing is approved subject to the conditions mentioned in Occupancy Certificate

CIDCO/NAINA/Panvel/Adai/BP-00384/OC/Full/2 022/0306 Dated 2 January 2023

Sr. No.

Site Plan on white Print

Plot Line
Existing Street
Future Street
Permissible Building lines
BuA line
Marginal Open Spaces
T.I.L.R. BOUNDARY
Proposed Work

Site Plan on Building Plan
Buildi

CONTENT OF SHEET

LOCATION PLAN, LAYOUT PLAN, PLOT AREA, PLOT AREA CALCULATION
BUILTUP AREA STATEMENT, PROFORMA-1 PARKING AREA STATEMENT,
TOTAL AREA STATEMENT INCLUDING BUA BALCONY TERRACE

Certificate Of Area

AREA SQ.M.

Certified That The Plot Under Reference Was surveyed By Me On 18-5-2019 and The Dimensions of sides etc. Of Plot Stated On Plan are As measured On Site and The Area So Work Out Tallies with The Area Stated in Document Of Ownership/T.P. Scaeme Records/Land Records Department/City Survey Record.

(Signature of POA Holder)

Form of Certificate

Ar. Parag Mehetar

PMA ARCHITECTS

(Signature of Architect)

CA/2013/58335

(Signature of POA Holder)

Form of Certificate

I,(Ar.Parag Mehetar) Have Been Employed By The Applicant As His Architect. I Have Examined The Boundaries & The Area Of The Plot & I Do Hereby Certify That I have Personally Verified & Checked All The Statement Made By The Applicant Who Is The

Owner / Lessee in Possession Of The Plot As In The Above Form & Found Them To Be Correct.
Dated 14.08.2019

Address :- Shop No.12, Godrej Plaza, Panvel - 410 206. Email Id :- nirmaan_architect@yahoo.in Mobile No :- 9819595299

NAME OF OWNER
MR.BINOJ METHEW.

(Signature of POA HOLDER)

Ar. Parag Meretar
PMA ARCHITECTS
(Signature of Architect)
AR.PARAG MEHETAR

Reg No:CA/13/58335

Ar. Parag Meheta PMA ARCHITECTS

(Signature of Architect) CA/2013/58335

DESCRIPTION OF PROP. & PROPERTY

RESIDENTIAL BUILDING ON SURVEY.NO. 116/8, AT. VILLAGE - ADAI, TAL.- PANVEL, DIST. - RAIGAD.



ARCHITECTS

10.2, 1st floor, A wing, Yashokiran Hsg Society,
Sawarkar chowk, Panyel - 410206.

(AR.PARAG MEHETAR) Reg.No.CA/2013/58335

2.2022 DRAWN CHECKED SCALE

NAINA SUDHIR KARANDE PARAG MEHETAR AS SPECIFIED

SHEET NO.1/3

