


U/G WATER STORAGE CAPACITY									
Water Requirement (in litre)								UGT provided	
WING	Total no. of units	Addl. Toilet	Population	Addl. Toilet	Population (@135)	Total	for 1.5 days	Total capacity required	Size/ Dimension
[1]	[2]	[3]	[4]=[2]x5	[5]=[3]x180	[6]=[4]x135	[7]=[5]x6	[8]	[9]	[10]
A	16	9	80	1620	10500	12420	32805	2.85 X 2.75 X 4.80 CU.M.	33,523
B	14	0	70	0	9450	9450	32805		
TOTAL	30	9	150	1620	20250	21870	32805	GRAND TOTAL	33,523


O.H. WATER STORAGE CAPACITY									
Water Requirement (in litre)								UGT provided	
WING	Total no. of units	Addl. Toilet	Population	Addl. Toilet	Population (@135)	Total	Total capacity required	Size/ Dimension	Capacity PProvided (litrs)
[1]	[2]	[3]	[4]=[2]x5	[5]=[3]x180	[6]=[4]x135	[7]=[5]x6	[9]	[10]	[11]
A	16	9	80	1620	10500	12420	21870	2.85 X 2.00 X 2.4	12,720
B	14	0	70	0	9450	9450	21870	2.65 X 1.80 X 2.00	9,540
TOTAL	30	9	150	1620	20250	21870	GRAND TOTAL	2	22,260

WING - A & B																				
SEPTIC TANK STORAGE CAPACITY																				
Sr. No	DESCRIPTION			FLUSHING		DOMESTIC		FIRE		FLUSHING		DOMESTIC		TOTAL COLD WATER		%AGE FLOW TO SEWER			REQD. SEPTIC TANK	PROVIDED SEPTIC TANK
								OHT	UGWT	OHT	UGWT	OHT	(A + B)	DOMESTIC	FLUSHING	TOTAL				
A	WING	Total Population	LPCD	LPD	LPCD	LPD	LTR	LTR	LTR	LTR	LTR	LPD	%	LPD	%	LPD	TO Septic Tank			
1	WING-B	70	54	3780	135	9450	0	5670	1890	14175	4725	13230	85	8032.5	100	3780	11812.5	26689.5	2.20 X 6.60 X 1.85 CU.M.	
2	WING-A	80	54	4320	135	10800	0	6480	2160	16200	5400	15120	85	9180	100	4320	13500			
3	Add. Toilets	9					180	1620	0	0	2430	810	1620	85	1377	100	1377			
Grand Total		150					8100	21870	12150	4050	32805	10935	29970	18589.5	8100	26689.5		In Litres	26862 Litres	
TOTAL (ROUND OFF IN KLD)						8.1	21.9	12.2	4.1	32.8	10.9	30.0	18.6	8.1	26.7	26.7		26.7	26.9	

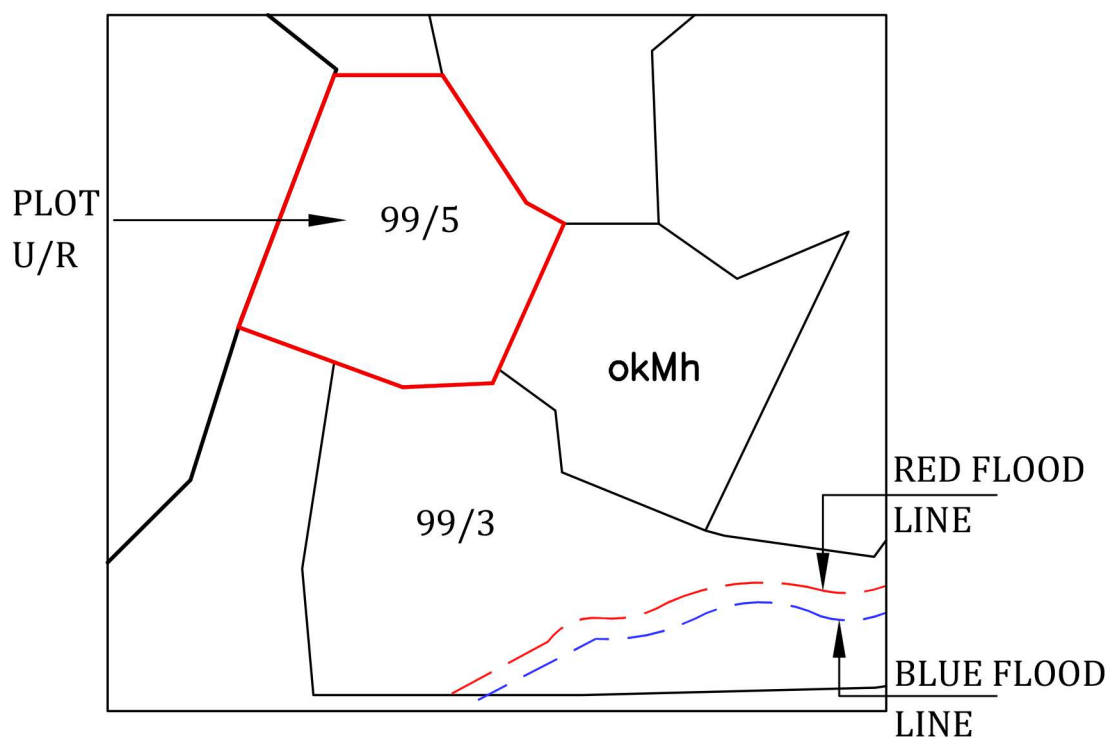

RED LINE & BLUE LINE

TENAMENT STATEMENT				
BLDG. NO. (PROPOSED BLDG.)	CARPET AREA UPTO 35 SQ.MT.	CARPET AREA 35.00 TO 45.00 SQ.MT.	CARPET AREA 45.00 TO 60.00 SQ.MT.	TOTAL
(WING-A)	16	0	0	16
(WING-B)	1	13	0	14
	17	13	0	30

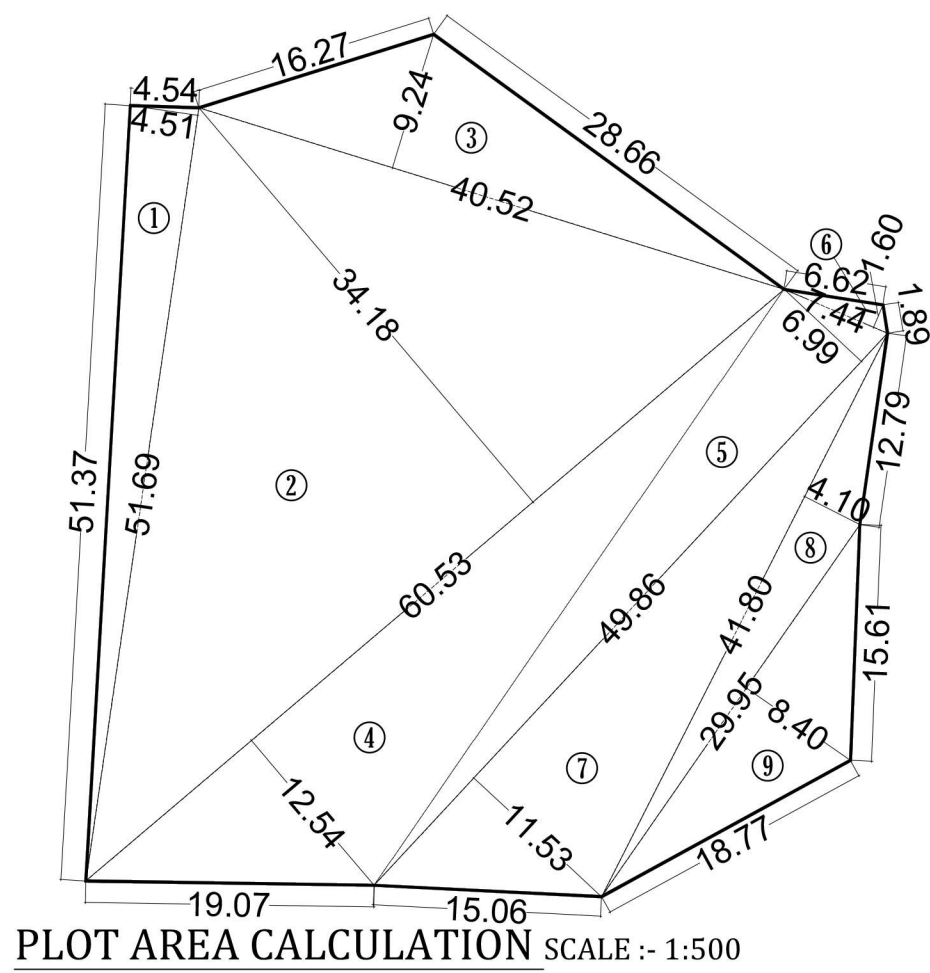


PLOT AREA CALCULATION SCALE :- 1:500

* Enclosed Balcony Area Calculation (BLDG NO.1, WING A & WING B)					
Floors	Built Up Area (in sq.mt.)	Permissible Balcony (15%)	Proposed Balcony	Total	Excess Balcony
GROUND FLOOR	201.57	30.24	81 2.90 X 0.7 X 4 = 8.12 + 2.75 X 0.3 X 4 = 3.30 82 2.30 X 1.325 X 4 = 12.19 83 3.10 X 1.05 X 2 = 6.51 84 2.30 X 1.45 X 1 = 3.335	33.45	3.22
1st floor	301.21	45.18	81 2.90 X 0.7 X 4 = 8.12 + 2.75 X 0.30 X 4 = 3.311 82 2.30 X 1.325 X 4 = 12.19 83 2.30 X 1.45 X 4 = 13.34 81 2.90 X 0.7 X 4 = 8.12 + 2.75 X 0.30 X 4 = 3.311 82 2.30 X 1.325 X 4 = 12.19 83 2.30 X 1.45 X 4 = 13.34	36.96	0.00
2nd floor	301.21	45.18	81 2.90 X 0.7 X 4 = 8.12 + 2.75 X 0.30 X 4 = 3.311 82 2.30 X 1.325 X 4 = 12.19 83 2.30 X 1.45 X 4 = 13.34	36.96	0.00
3rd floor	301.21	45.18	81 2.90 X 0.7 X 4 = 8.12 + 2.75 X 0.30 X 4 = 3.311 82 2.30 X 1.325 X 4 = 12.19 83 2.30 X 1.45 X 4 = 13.34	36.96	0.00
Total	165.78			144.32	3.22

Terrace Area Calculation (BLDG NO.1, WING A & WING B)				
Floors	Built Up Area (in sq.mt.)	Permissible Terrace (20%)	Proposed Terrace	Total
1st floor	301.21	60.24	T1 1.97 X 1.08 X 2 = 4.26 T2 1.82 X 1.08 X 2 = 3.93 T3 1.50 X 1.08 X 2 = 3.24 T4 1.57 X 1.08 X 2 = 3.39	14.82
2nd floor	301.21	60.24	T1 1.98 X 1.08 X 3 = 6.38 T2 3.30 X 1.08 X 1 = 3.55 T3 1.85 X 1.08 X 4 = 7.96 T1 1.97 X 1.08 X 2 = 4.26 T2 1.82 X 1.08 X 2 = 3.93	17.88
3rd floor	301.21	60.24	T3 1.50 X 1.08 X 2 = 3.24 T4 1.57 X 1.08 X 2 = 3.39	14.82
Total				47.53


PLOT AREA CALCULATION TABLE			
1	51.69 x 4.51 x 0.50	=	116.561 SQ.MT.
2	60.53 x 34.18 x 0.50	=	1034.458 SQ.MT.
3	40.52 x 9.24 x 0.50	=	187.202 SQ.MT.
4	60.53 x 12.54 x 0.50	=	379.523 SQ.MT.
5	49.86 x 6.99 x 0.50	=	174.261 SQ.MT.
6	7.44 x 1.60 x 0.50	=	5.952 SQ.MT.
7	49.86 x 11.53 x 0.50	=	287.443 SQ.MT.
8	41.80 x 4.10 x 0.50	=	85.690 SQ.MT.
9	29.95 x 8.40 x 0.50	=	125.790 SQ.MT.
TOTAL		=	2396.880 SQ.MT.

ROAD AREA CALCULATION TABLE			
1	16.27 x 1.43 x 0.50	=	11.63 SQ.MT.
2	19.80 x 8.32 x 0.50	=	82.37 SQ.MT.
3	21.61 x 3.96 x 0.50	=	42.79 SQ.MT.
4	28.66 x 1.07 x 0.50	=	15.33 SQ.MT.
5	6.62 x 1.07 x 0.50	=	3.54 SQ.MT.
6	2.02 x 1.51 x 0.50	=	1.53 SQ.MT.
TOTAL		=	157.19 SQ.MT.

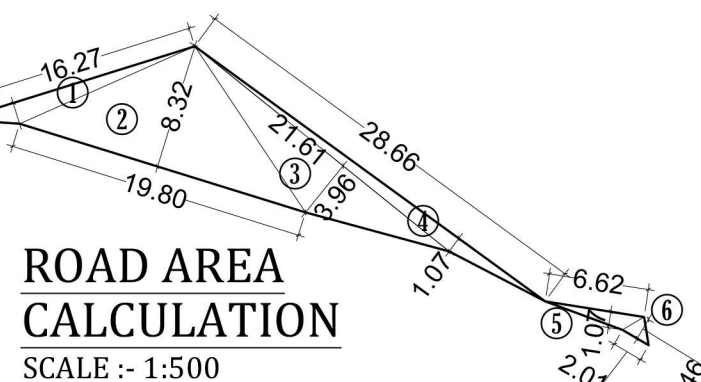


ROAD AREA CALCULATION SCALE :- 1:500


R.G. AREA STATEMENT	
TOTAL R.G. REQUIRED	2219.65 X 10.0% = 221.97
R.G. PROVIDED	
R.G. 1	= 251.37
TOTAL R.G.	= 251.37

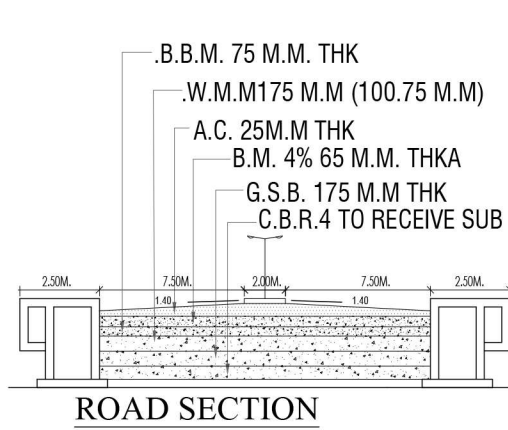


ROAD SECTION

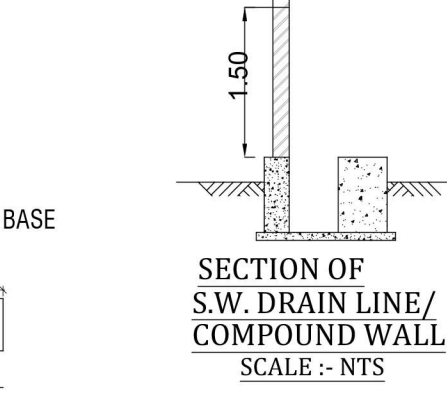


SECTION OF S.W. DRAIN LINE/ COMPOUND WALL SCALE :- NTS

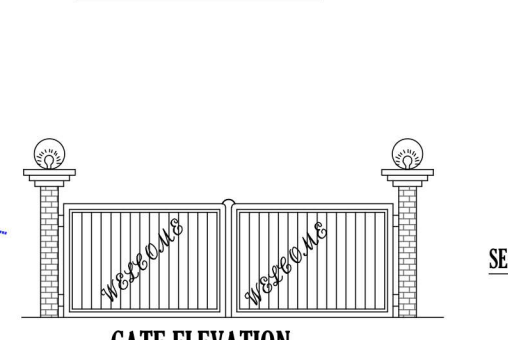


GATE ELEVATION

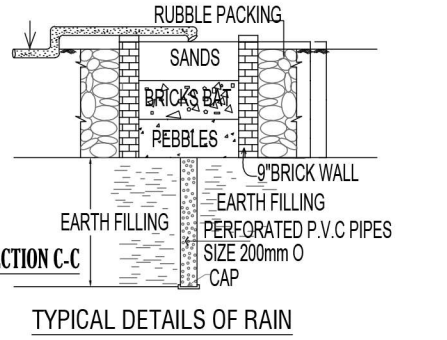


TYPICAL DETAILS OF RAIN WATER HARVESTING

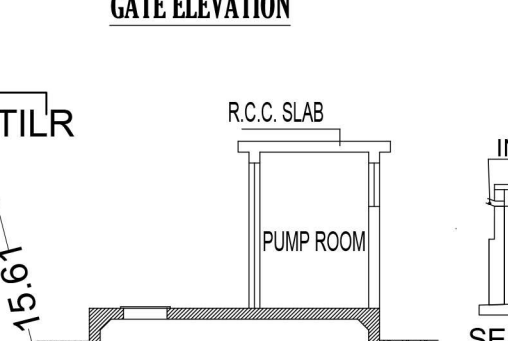


SECTION OF U.G. WATER TANK & PUMP ROOM SCALE :- NTS

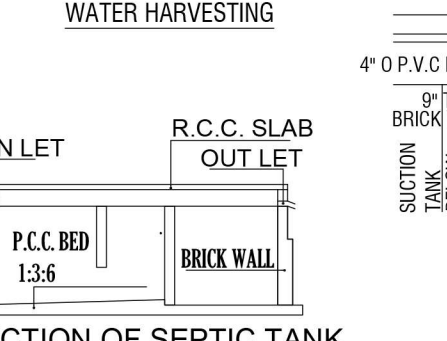


SECTION OF SEPTIC TANK SCALE 1:50

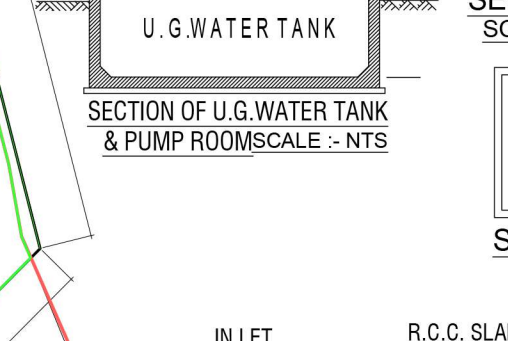


SECTION OF U.G. WATER TANK & PUMP ROOM SCALE :- NTS

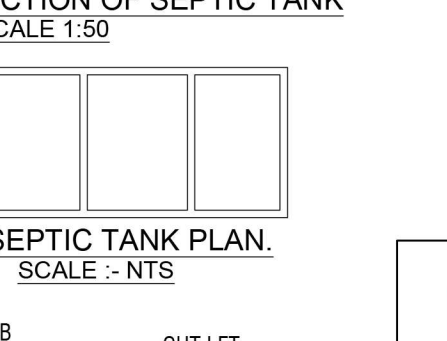


SECTION OF SEPTIC TANK SCALE 1:50

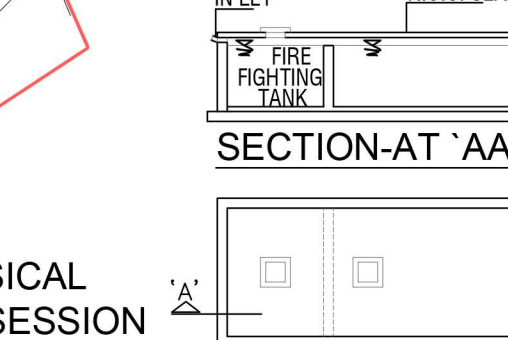


SECTION OF U.G. WATER TANK & PUMP ROOM SCALE :- NTS

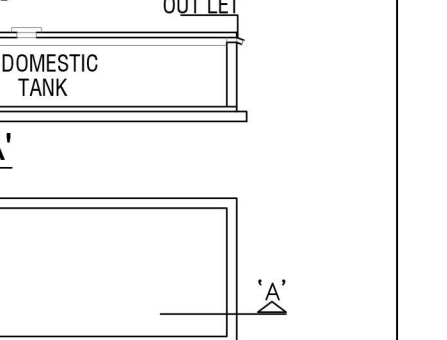


SECTION OF SEPTIC TANK SCALE 1:50

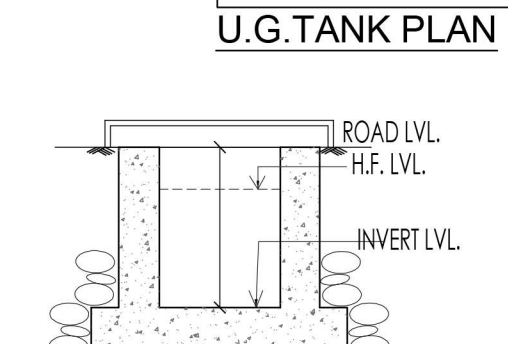


SECTION OF U.G. WATER TANK & PUMP ROOM SCALE :- NTS

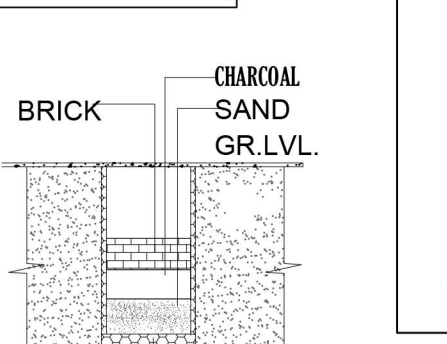

SECTION OF SEPTIC TANK SCALE 1:50

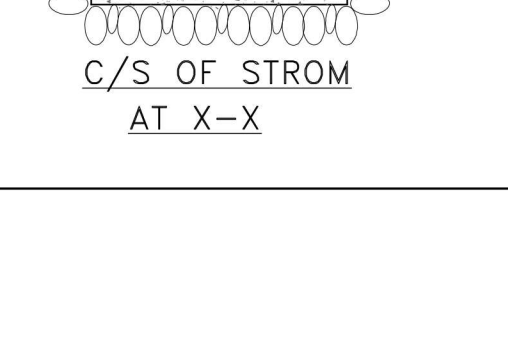

SECTION OF U.G. WATER TANK & PUMP ROOM SCALE :- NTS

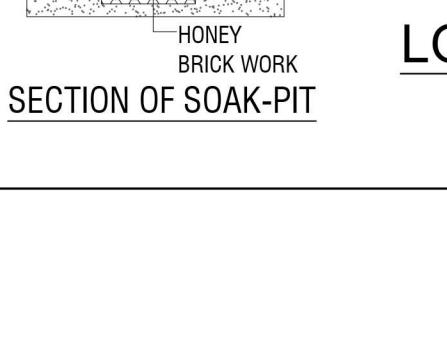


SECTION OF SEPTIC TANK SCALE 1:50


TENEMENTS AREA STATEMENT (Ground to 3rd FLOOR)				
BUILDING NUMBER	FLOORS	FLAT NUMBER	CARPET AREA (SQM)	BUILT UP AREA (SQM)
BLDG NO.1 (WING A)	Ground	1	24.360	5.900
		2	24.360	5.900
		3	24.360	5.900
		4	24.360	5.900
	1st & 3rd	101, 301	24.360	5.900
		102, 302	24.360	5.900
		103, 303	24.360	5.900
		104, 304	24.360	5.900
	2nd	201	24.360	5.900
		202	24.360	5.900
		203	24.360	5.900
		204	24.360	5.900

TENEMENTS AREA STATEMENT (1ST TO 3RD FLOOR)				
BUILDING NUMBER	FLOORS	FLAT NUMBER	CARPET AREA (SQM)	BUILT UP AREA (SQM)
BLDG NO.1 (WING B)	GROUND	2	32.600	3.255
		4	36.040	6.600
		101, 301	41.070	3.340
		102, 302	41.070	3.340
	1st to 3rd	103, 303	37.370	3.340
		104, 304	41.070	3.340
		201	41.070	3.340
		202	41.070	3.340
	2nd	203	37.370	3.340
		204	41.070	3.340

R.G. AREA CALCULATION			
ADDITION			
1	1.715 x 0.339 x 0.66	=	0.384 SQ.MT.
2	17.851 x 1.233 x 0.50	=	11.005 SQ.MT.
3	21.823 x 9.203 x 0.50	=	100.419 SQ.MT.
4	21.823 x 6.576 x 0.50	=	71.754 SQ.MT.
5	18.611 x 2.568 x 0.50	=	23.897 SQ.MT.
6	18.611 x 3.483 x 0.50	=	32.411 SQ.MT.
7	11.793 x 2.021 x 0.50	=	11.917 SQ.MT.
TOTAL		=	251.79 SQ.MT.
DEDUCTION			
a	2.63 x 0.24 x 0.66	=	0.41 SQ.MT.
TOTAL		=	0.41 SQ.MT.
TOTAL AREA		=	251.37 SQ.MT.

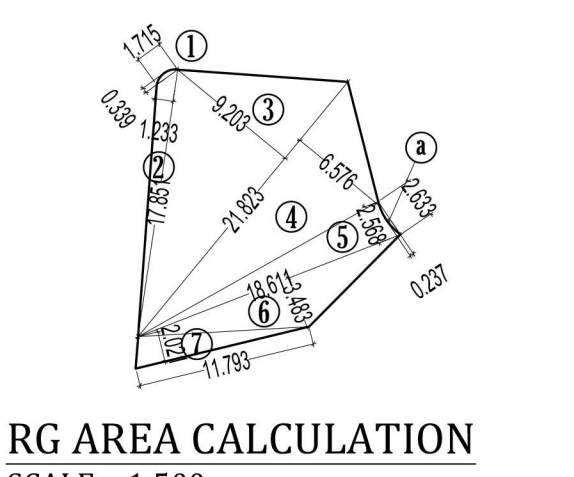

RG AREA CALCULATION SCALE :- 1:500

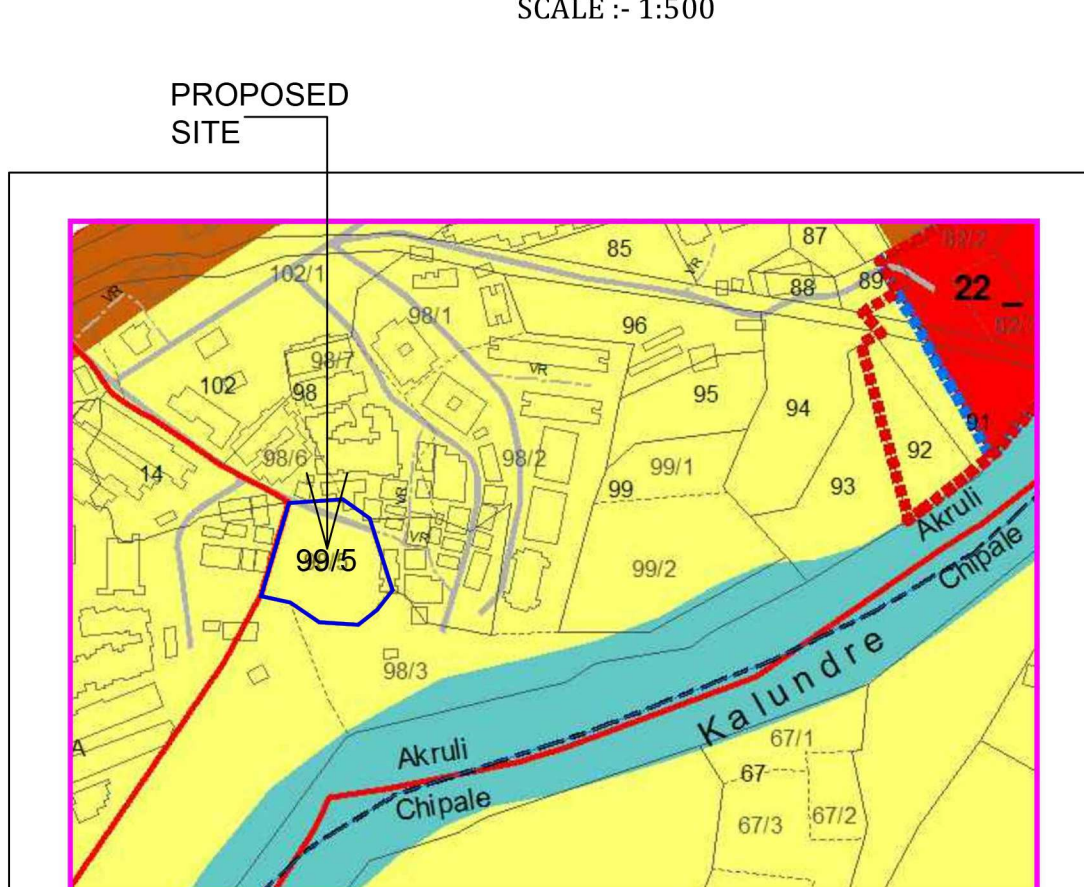

LOCATION PLAN SCALE :- 1:4000

STAMP FOR APPROVAL

01/03

Amended Development permission Granted

Subject to the conditions mentioned in this office's letter no: CIDCO/NAINA/Panvel/Akurli/BP-00308/ACC/2020/0044

Dated : 18 Aug 2020

PROFORMA - A

A	AREA STATEMENT	AREA IN SQ.MT.
1	AREA OF LAND AS PER 7/12	2430.00
2	AREA OF LAND AS PER MEASUREMENT PLAN BY TILR	2396.88
3	AREA OF LAND AS PER PHYSICAL POSSESSION	2376.83
4	MINIMUM AREA CONSIDER FOR FSI	2376.83
5	DEDUCTION	
a	AREA UNDER EXISTING ROAD TOTAL	157.19
6	NET PLOT AREA(4-5)	2219.65
7	RECREATIONAL OPEN SPACE PROVIDED	251.37
8	PERMISSIBLE FSI ON NET PLOT AREA	0.50
9	PERMISSIBLE BUILT UP AREA (6X8)	1109.82
10	EXISTING BUILT UP AREA	0.00
11	PROPOSED BUILT UP AREA	1105.190
12	EXCESS BALCONY AREA TAKEN IN FSI	3.220
13	TOTAL BUILT UP AREA (10+11+12)	1108.410
14	FSI CONSUMED (13/6)	0.4994
15	FSI BALANCED	1.4125
16	NO. OF UNIT PROPOSED	
a)	RESIDENTIAL	30.00
17	PROPOSED TREE PLANTATION	35.00
B	BALCONY AREA STATEMENT	*
C	TDR	NA
D	PARKING STATEMENT	**
E	LOADING/UNLOADING SPACES	NA

Sr.No.	LEGEND	Site Plan on white print	Building Plan on white print
1	Plot Line		
2	Existing Street		
3	Future Street		
4	Drainage & Sewerage Work		
5	RWH Line		
6	Proposed Work		
7	S.W.Drain		
8	Car parking		

CERTIFICATE OF AREA

Certified that the plot under reference was surveyed by me on 02.06.2017 and the dimensions of side etc. of plot stated on plan are as measured on site and the area so worked out tallies with the area stated in document of ownership/T.P. Scheme Records/ Land Records Department /City survey record.

Signature of Owner

Signature of Architect

SHRI VIDIP VINODKUMAR JATIA

FOR SQUARE ONE HOUSING CORPORATION (PROPRIETOR)

AR.DEVYANI KHADILKAR

FORM OF CERTIFICATE

I, Ar. Devyani khadilkar, for M/s Spaceage Consultants have been employed by the applicant as his Architect. I have examined the boundary and the area of the plot and i do hereby certify that i have personally verified and checked all the statement made by applicant who is the owner/lessee in possession of the plot as in the above form and found them to be correct.

Signature of Owner

Signature of Architect

SHRI VIDIP VINODKUMAR JATIA

FOR SQUARE ONE HOUSING CORPORATION (PROPRIETOR)

AR.DEVYANI KHADILKAR

CONTENTS OF SHEET

BLOCK PLAN, LOCATION PLAN, BUILT UP AREA SUMMARY , R.G. AREA STATEMENT, TENAMENT STATEMENT, DETAILS.

DESCRIPTION OF PROPOSAL & PROPERTY


PROPOSED DEVELOPMENT

CONTENTS OF SHEET




TYPICAL FLOOR PLAN & CALCULATION, B.U. AREA & GROSS B.U. AREA STATEMENT, TENAMENT AREA STATEMENT, PARKING AREA STATEMENT (BLDG NO.1, WING A)

STAMP & DATE OF APPROVAL OF PLAN

Amended Development permission Granted
Subject to the conditions mentioned in this office's letter no: CIDCO/NAINA/Panvel/Akurli/BP-00308/ACC/2020/0044
Dated : 18 Aug 2020

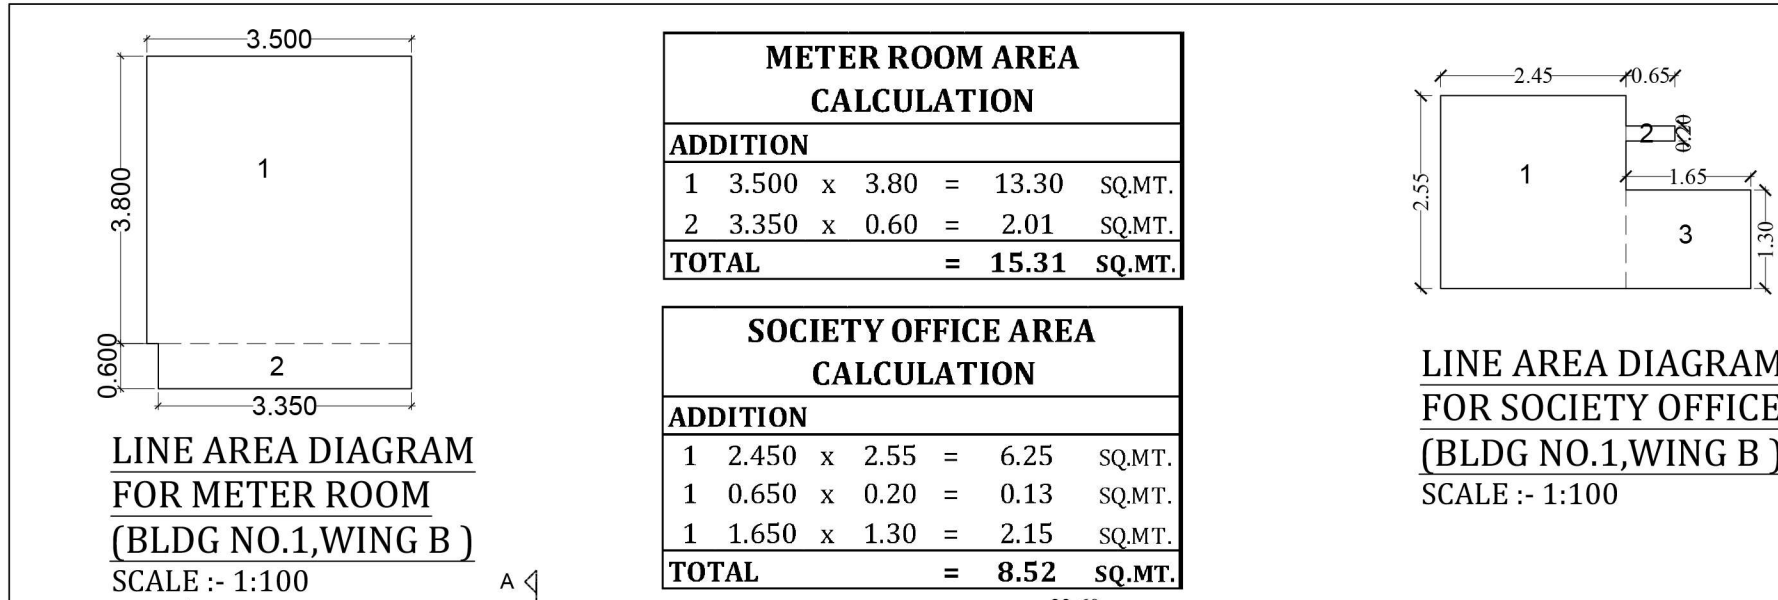

LINE AREA DIAGRAM FOR SOCIETY OFFICE (BLDG NO.1, WING B) SCALE :- 1:100

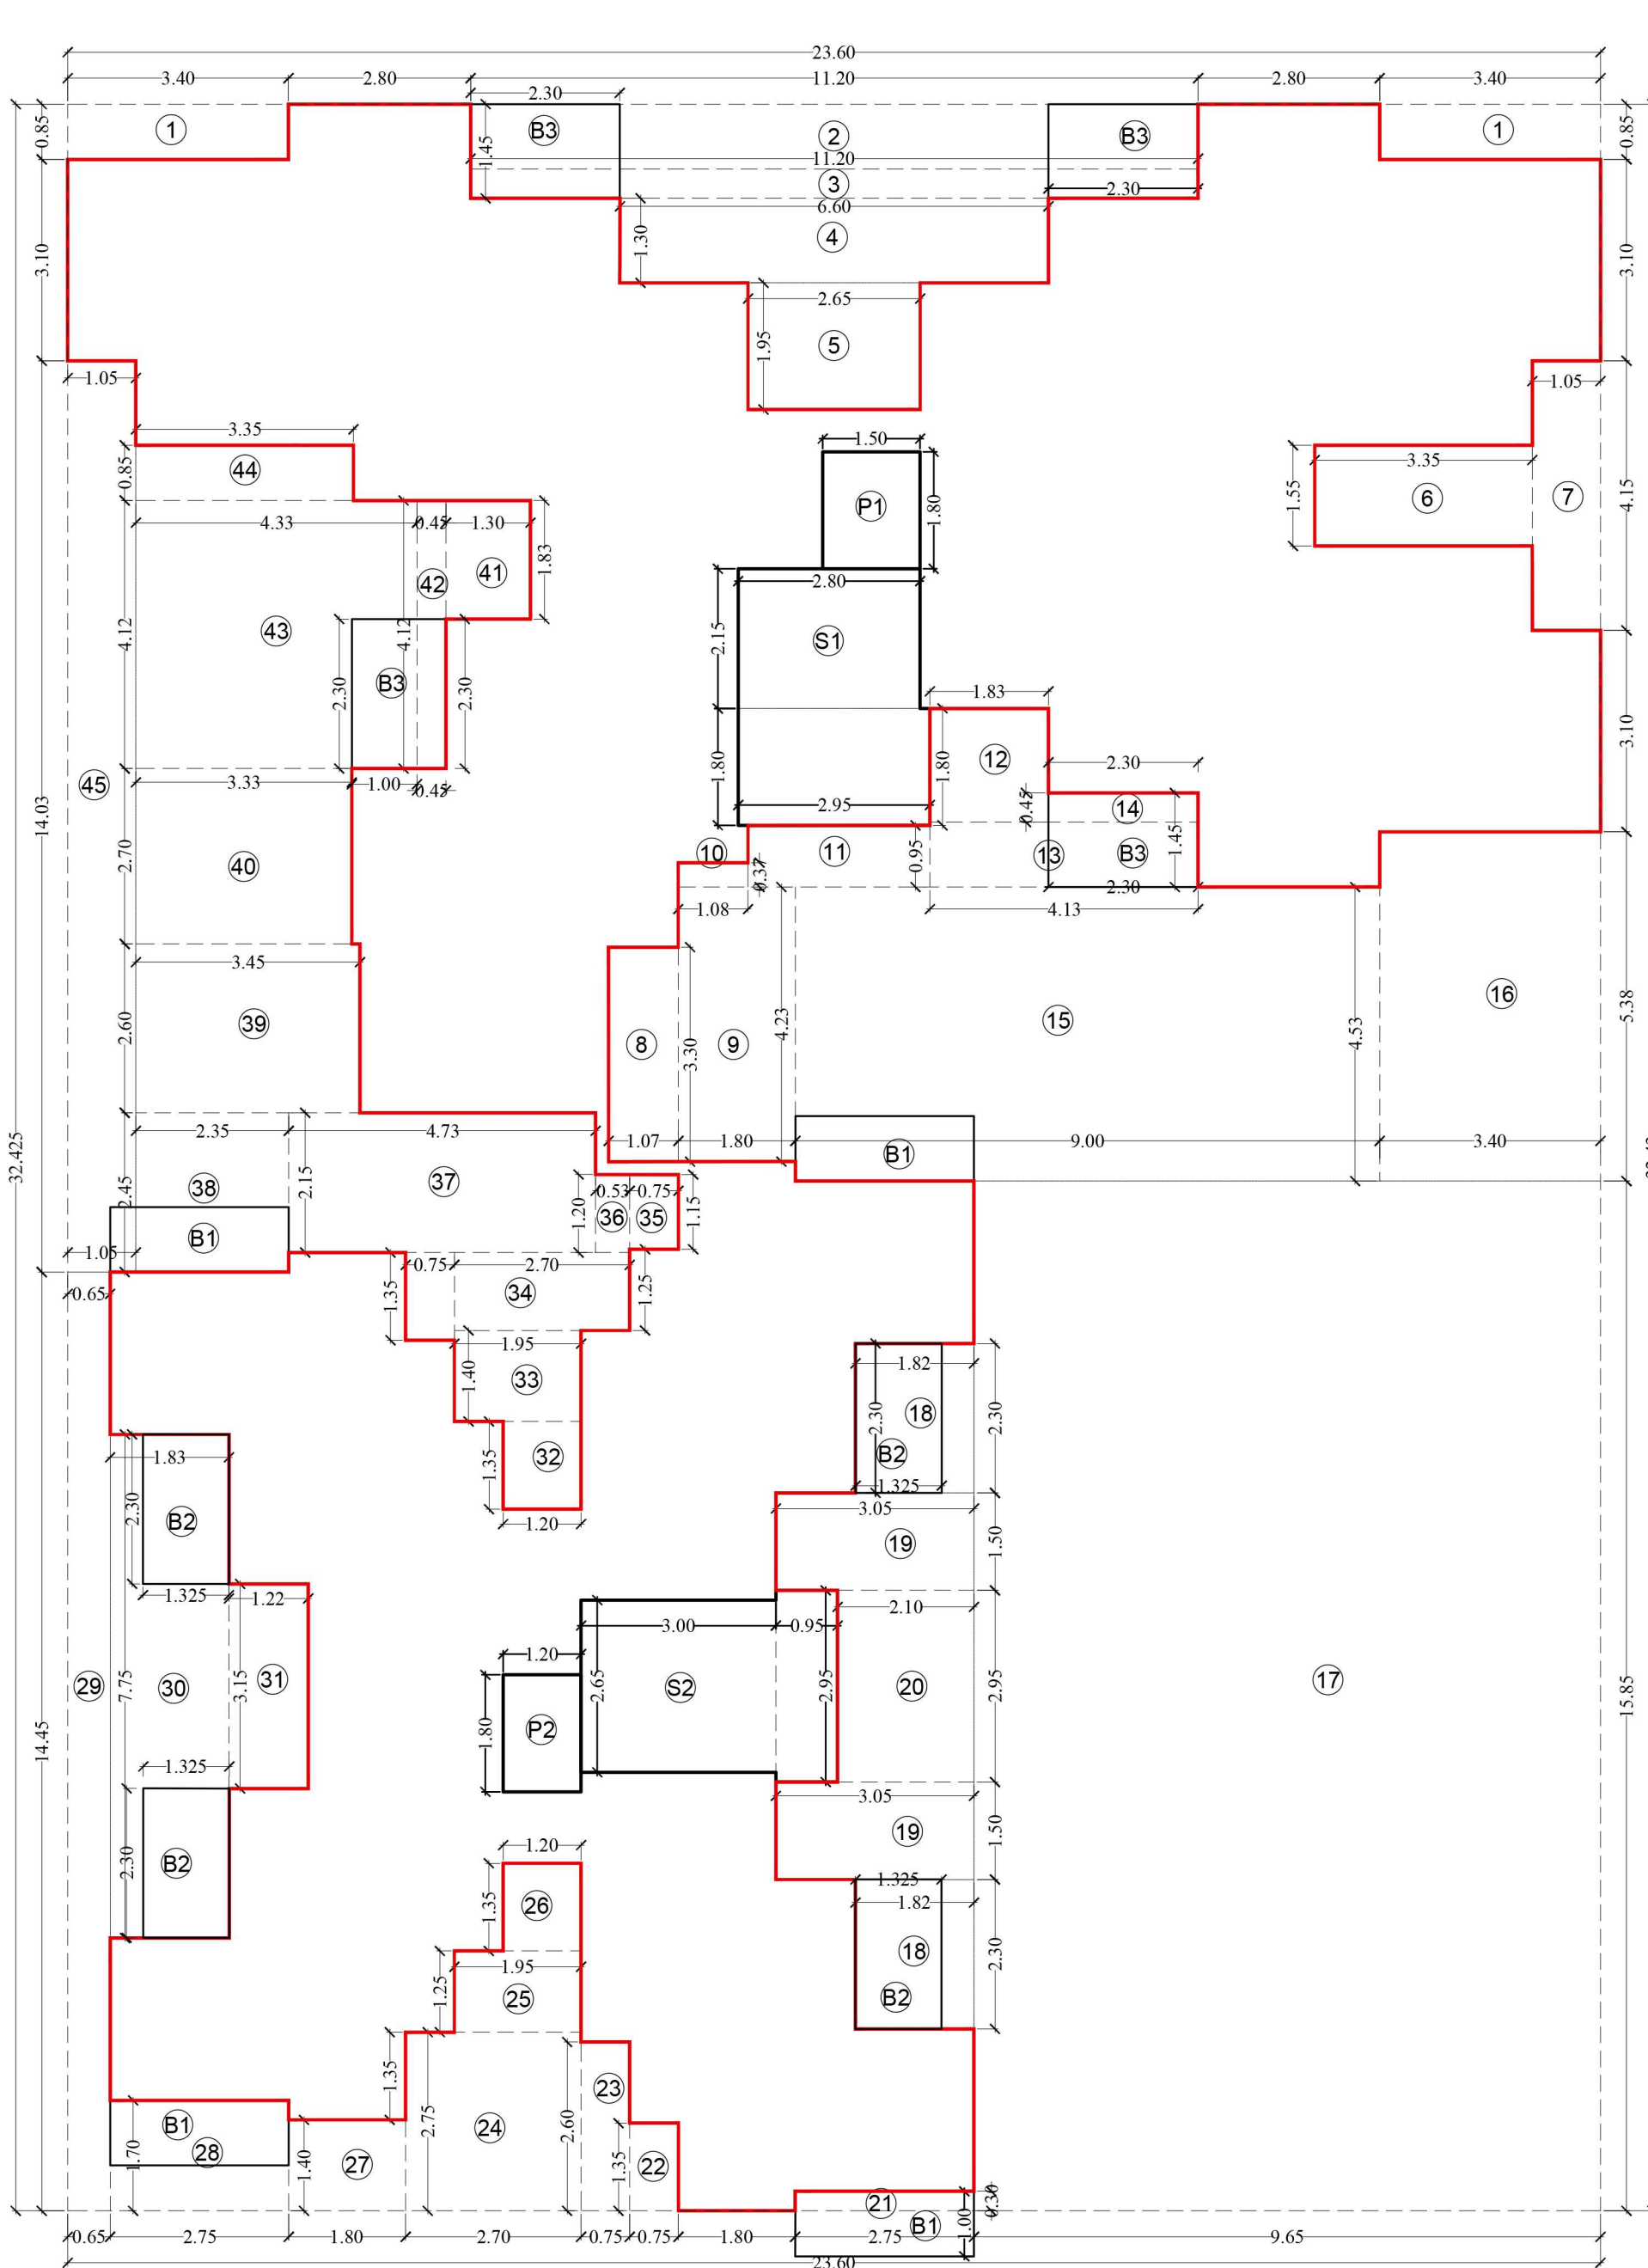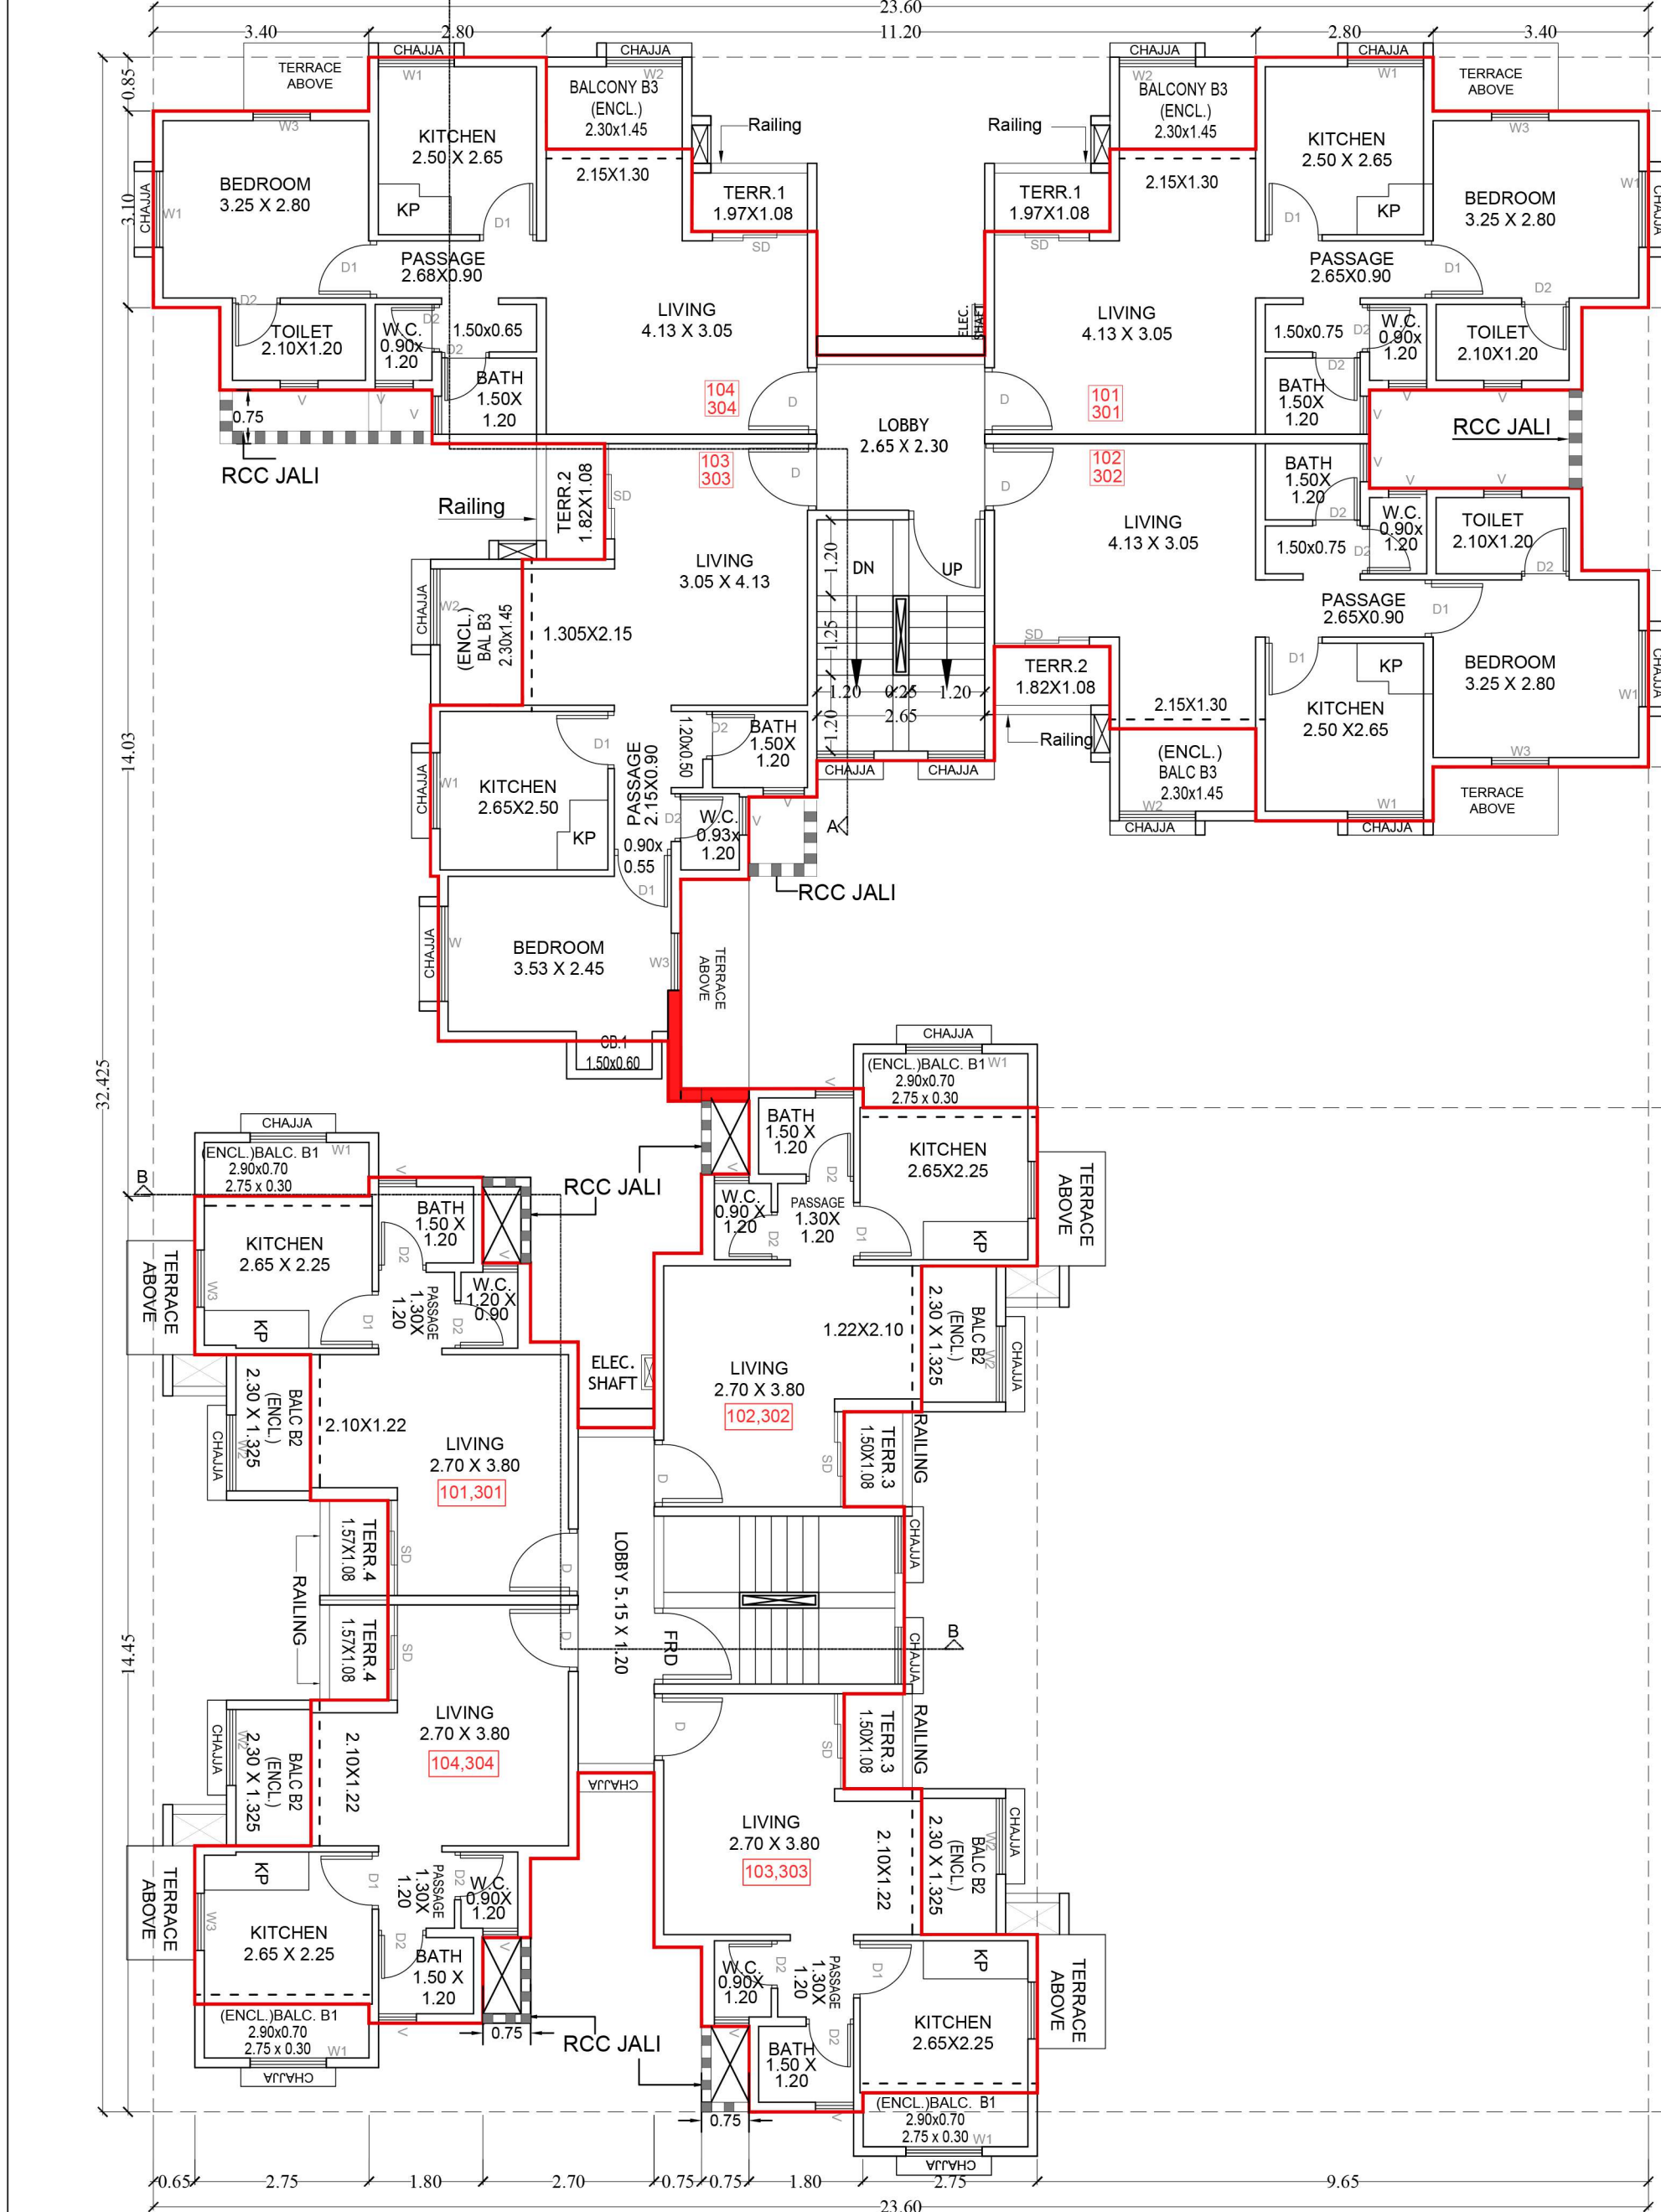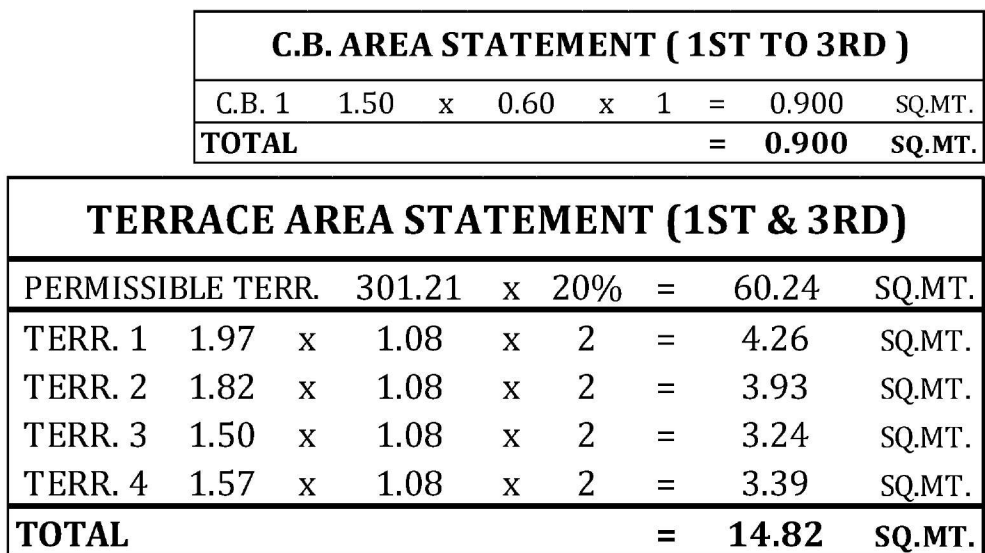

BUILT UP AREA CALCULATION FOR TYPICAL 1ST TO 3RD FLOOR (BLDG NO.1, WING B)	
ADDITION (X)	
A	23.60 x 32.43 x 1 = 765.24 SQ.MT.
TOTAL	= 765.24 SQ.MT.
STANDARD DEDUCTION (Y1)	
1	3.40 x 0.85 x 2 = 5.78 SQ.MT.
2	11.20 x 1.00 x 1 = 11.20 SQ.MT.
3	11.20 x 0.45 x 1 = 5.04 SQ.MT.
4	6.61 x 1.30 x 1 = 8.59 SQ.MT.
5	2.65 x 1.95 x 1 = 5.17 SQ.MT.
6	3.35 x 1.55 x 1 = 5.19 SQ.MT.
7	1.05 x 4.15 x 1 = 4.36 SQ.MT.
8	1.07 x 3.30 x 1 = 3.54 SQ.MT.
9	1.80 x 4.23 x 1 = 7.61 SQ.MT.
10	1.08 x 0.37 x 1 = 0.40 SQ.MT.
11	2.80 x 0.95 x 1 = 2.66 SQ.MT.
12	1.83 x 1.75 x 1 = 3.20 SQ.MT.
13	4.13 x 1.00 x 1 = 4.13 SQ.MT.
14	2.30 x 0.45 x 1 = 1.04 SQ.MT.
15	9.00 x 4.53 x 1 = 40.77 SQ.MT.
16	3.40 x 5.38 x 1 = 18.29 SQ.MT.
17	9.65 x 15.85 x 1 = 152.95 SQ.MT.
18	1.82 x 2.30 x 2 = 8.37 SQ.MT.
19	3.05 x 1.50 x 2 = 9.15 SQ.MT.
20	2.10 x 2.95 x 1 = 6.20 SQ.MT.
21	2.75 x 0.30 x 1 = 0.83 SQ.MT.
22	0.75 x 1.35 x 1 = 1.01 SQ.MT.
23	0.75 x 2.60 x 1 = 1.95 SQ.MT.
24	2.70 x 2.75 x 1 = 7.43 SQ.MT.
25	1.95 x 1.25 x 1 = 2.44 SQ.MT.
26	1.30 x 1.35 x 1 = 1.62 SQ.MT.
27	1.65 x 1.40 x 1 = 2.31 SQ.MT.
28	2.75 x 1.70 x 1 = 4.68 SQ.MT.
29	0.65 x 14.45 x 1 = 9.39 SQ.MT.
30	1.83 x 7.75 x 1 = 14.18 SQ.MT.
31	1.22 x 3.15 x 1 = 3.84 SQ.MT.
32	1.20 x 1.35 x 1 = 1.62 SQ.MT.
33	1.95 x 1.40 x 1 = 2.73 SQ.MT.
34	2.70 x 1.25 x 1 = 3.38 SQ.MT.
35	0.75 x 1.35 x 1 = 1.01 SQ.MT.
36	0.75 x 1.15 x 1 = 0.86 SQ.MT.
37	0.53 x 1.20 x 1 = 0.64 SQ.MT.
38	4.73 x 2.15 x 1 = 10.17 SQ.MT.
39	2.35 x 2.45 x 1 = 5.76 SQ.MT.
40	3.45 x 2.60 x 1 = 8.97 SQ.MT.
41	3.33 x 2.70 x 1 = 8.99 SQ.MT.
42	1.30 x 1.83 x 1 = 2.38 SQ.MT.
43	0.45 x 4.12 x 1 = 1.85 SQ.MT.
44	4.33 x 4.12 x 1 = 17.84 SQ.MT.
45	3.35 x 0.85 x 1 = 2.85 SQ.MT.
46	1.05 x 14.03 x 1 = 14.73 SQ.MT.
TOTAL	= 437.09 SQ.MT.
STAIRCASE & PASSAGE DEDUCTION (Y2)	
S1	2.80 x 2.15 x 1 = 6.01 SQ.MT.
"	2.95 x 1.80 x 1 = 5.31 SQ.MT.
S2	3.00 x 2.65 x 1 = 7.96 SQ.MT.
"	0.95 x 2.95 x 1 = 2.80 SQ.MT.
P1	1.50 x 1.80 x 1 = 2.70 SQ.MT.
P2	1.20 x 1.80 x 1 = 2.16 SQ.MT.
TOTAL	= 26.94 SQ.MT.
TOTAL DEDUCTION (Y3) (Y1 + Y2)	= 464.02 SQ.MT.
BUILT-UP AREA (Y4) (X - Y3)	= 301.21
PERM. BALCONY (Y5) (Y4 x 15%)	= 45.18
BALCONY AREA STATEMENT	
B1	2.90 x 0.70 x 4 = 8.12 SQ.MT.
"	2.75 x 0.30 x 4 = 3.31 SQ.MT.
B2	2.30 x 1.325 x 4 = 12.19 SQ.MT.
B3	2.30 x 1.45 x 4 = 13.34 SQ.MT.
TOTAL BALCONY (Y6)	= 36.96 SQ.MT.
EXCESS BALCONY (Y7)	= 0.00 SQ.MT.
NET BUILT-UP AREA (Y8) (Y4 + Y7)	= 301.21 SQ.MT.

LIGHT AND VENTILATION STATEMENT FOR 1ST TO 3RD FLOOR (BUILDING NO. 1 WING A) FLAT NO. 104, 204, 304

SR.NO.	ROOM	ROOM (SQM)	WIN REQ. (SQM)	AREA OF WIN PROV.(SQM)	TYPE OF WINDOW PROVD.
1	LIVING	15.63	2.605	4.605	W2, SD
2	KITCHEN	8.55	1.425	3.045	W1, W3
3	BATH	1.800	0.300	0.540	V
4	W.C.	1.080	0.180	0.540	V

LIGHT AND VENTILATION STATEMENT FOR 1ST TO 3RD FLOOR (BUILDING NO. 1 WING B) FLAT NO. 104, 204, 304

SR.NO.	ROOM	ROOM (SQM)	WIN REQ. (SQM)	AREA OF WIN PROV.(SQM)	TYPE OF WINDOW PROVD.
1	LIVING	18.48	3.080	4.605	W2, SD
2	BED	9.10	1.517	3.045	W1, W3
4	KITCHEN	6.63	1.105	1.740	W1
5	TOILET	2.52	0.420	0.540	V
6	BATH	1.800	0.300	0.540	V
7	W.C.	1.080	0.180	0.540	V

DOOR SCHEDULE		
NAME	OPENING SIZE	LINTEL
D	1.05 X 2.35	2.35
D01	0.90 X 2.35	2.35
D02	0.75 X 2.35	2.35
D03	1.00 X 2.35	2.35
OP	0.90 X 2.35	2.35
SD	1.50 X 2.35	2.35

WINDOW SCHEDULE			
NAME	OPENING SIZE	LINTEL	SILL
W	1.50 X 1.45	2.35	0.90
W1	1.50 X 2.35	2.35	0.15
W1	1.20 X 1.45	2.35	0.90
W2	1.20 X 0.90	2.35	1.45
W3	0.90 X 1.45	2.35	0.90
W4	0.90 X 2.35	2.20	0.15
V	0.60 X 0.90	2.35	1.45

DESCRIPTION OF PROPOSAL & PROPERTY

PROPOSED DEVELOPMENT PERMISSION ON LAND BEARING GUT NO. 99/5 AT VILLAGE - AKURLI, TAL. - PANVEL DIST - RAIGAD

NORTH	JOB. NO.	DRG. NO.	DRAWN BY
	-	02/03	-
	SCALE	DATE	CHECKED BY
	1:100	-	-

REVISIONS DESCRIPTION :

R-0

NAME OF THE OWNER SIGNATURE


SHRI VIDIP VINODKUMAR JATIA

FOR SQUARE ONE HOUSING CORPORATION (PROPRITOR)

NAME OF ARCHITECT	DEVYANI KHADILKAR
LIC. NO.	CA/90/13184


ADDRESS
B-106, Nalraj Building, Mulund Goregaon Link Road Mulund (w), Mumbai - 400 080



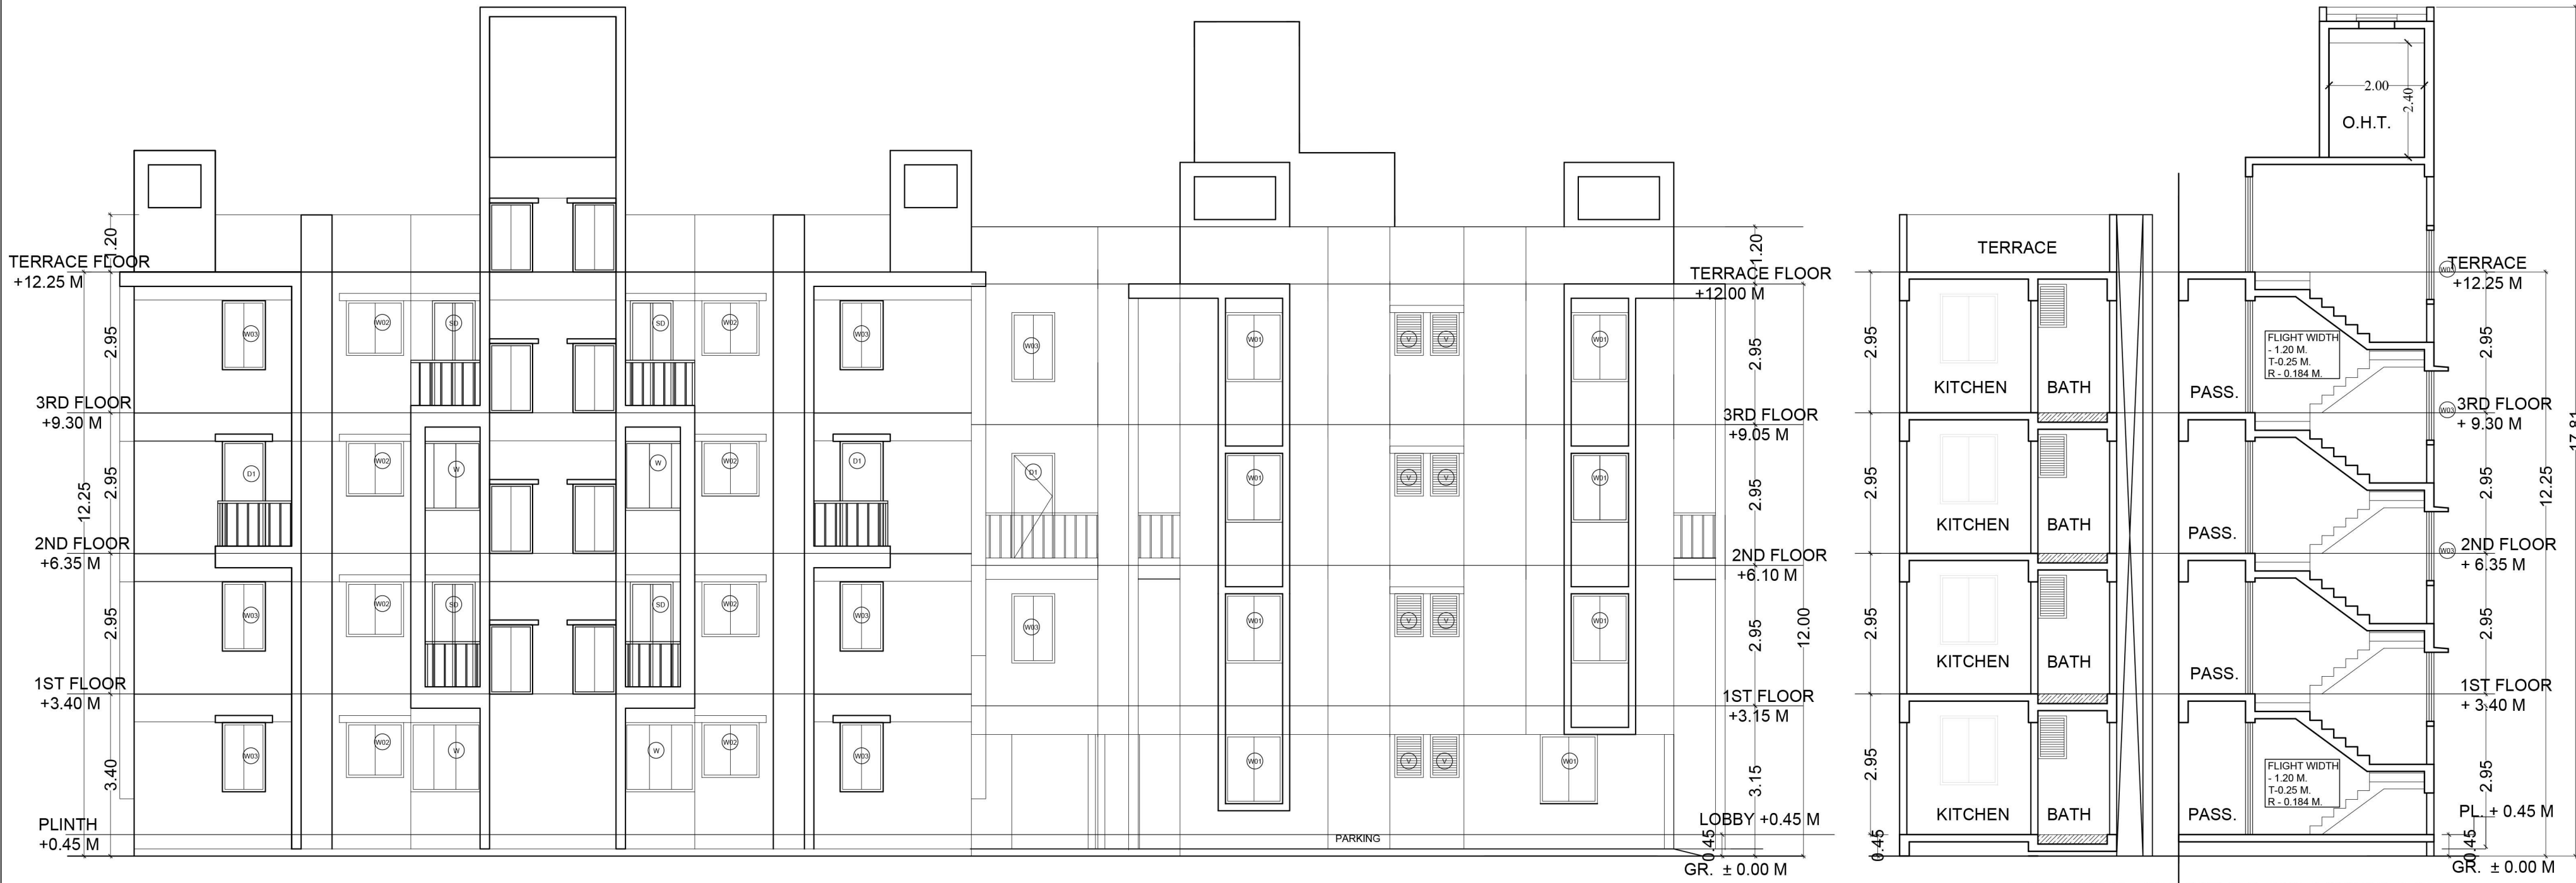


ELEVATION (BLDG. NO.1,WING A & WING B)
SCALE :- 1:100


SECTION - BB (BLDG. NO.1,WING A)
SCALE :- 1:100

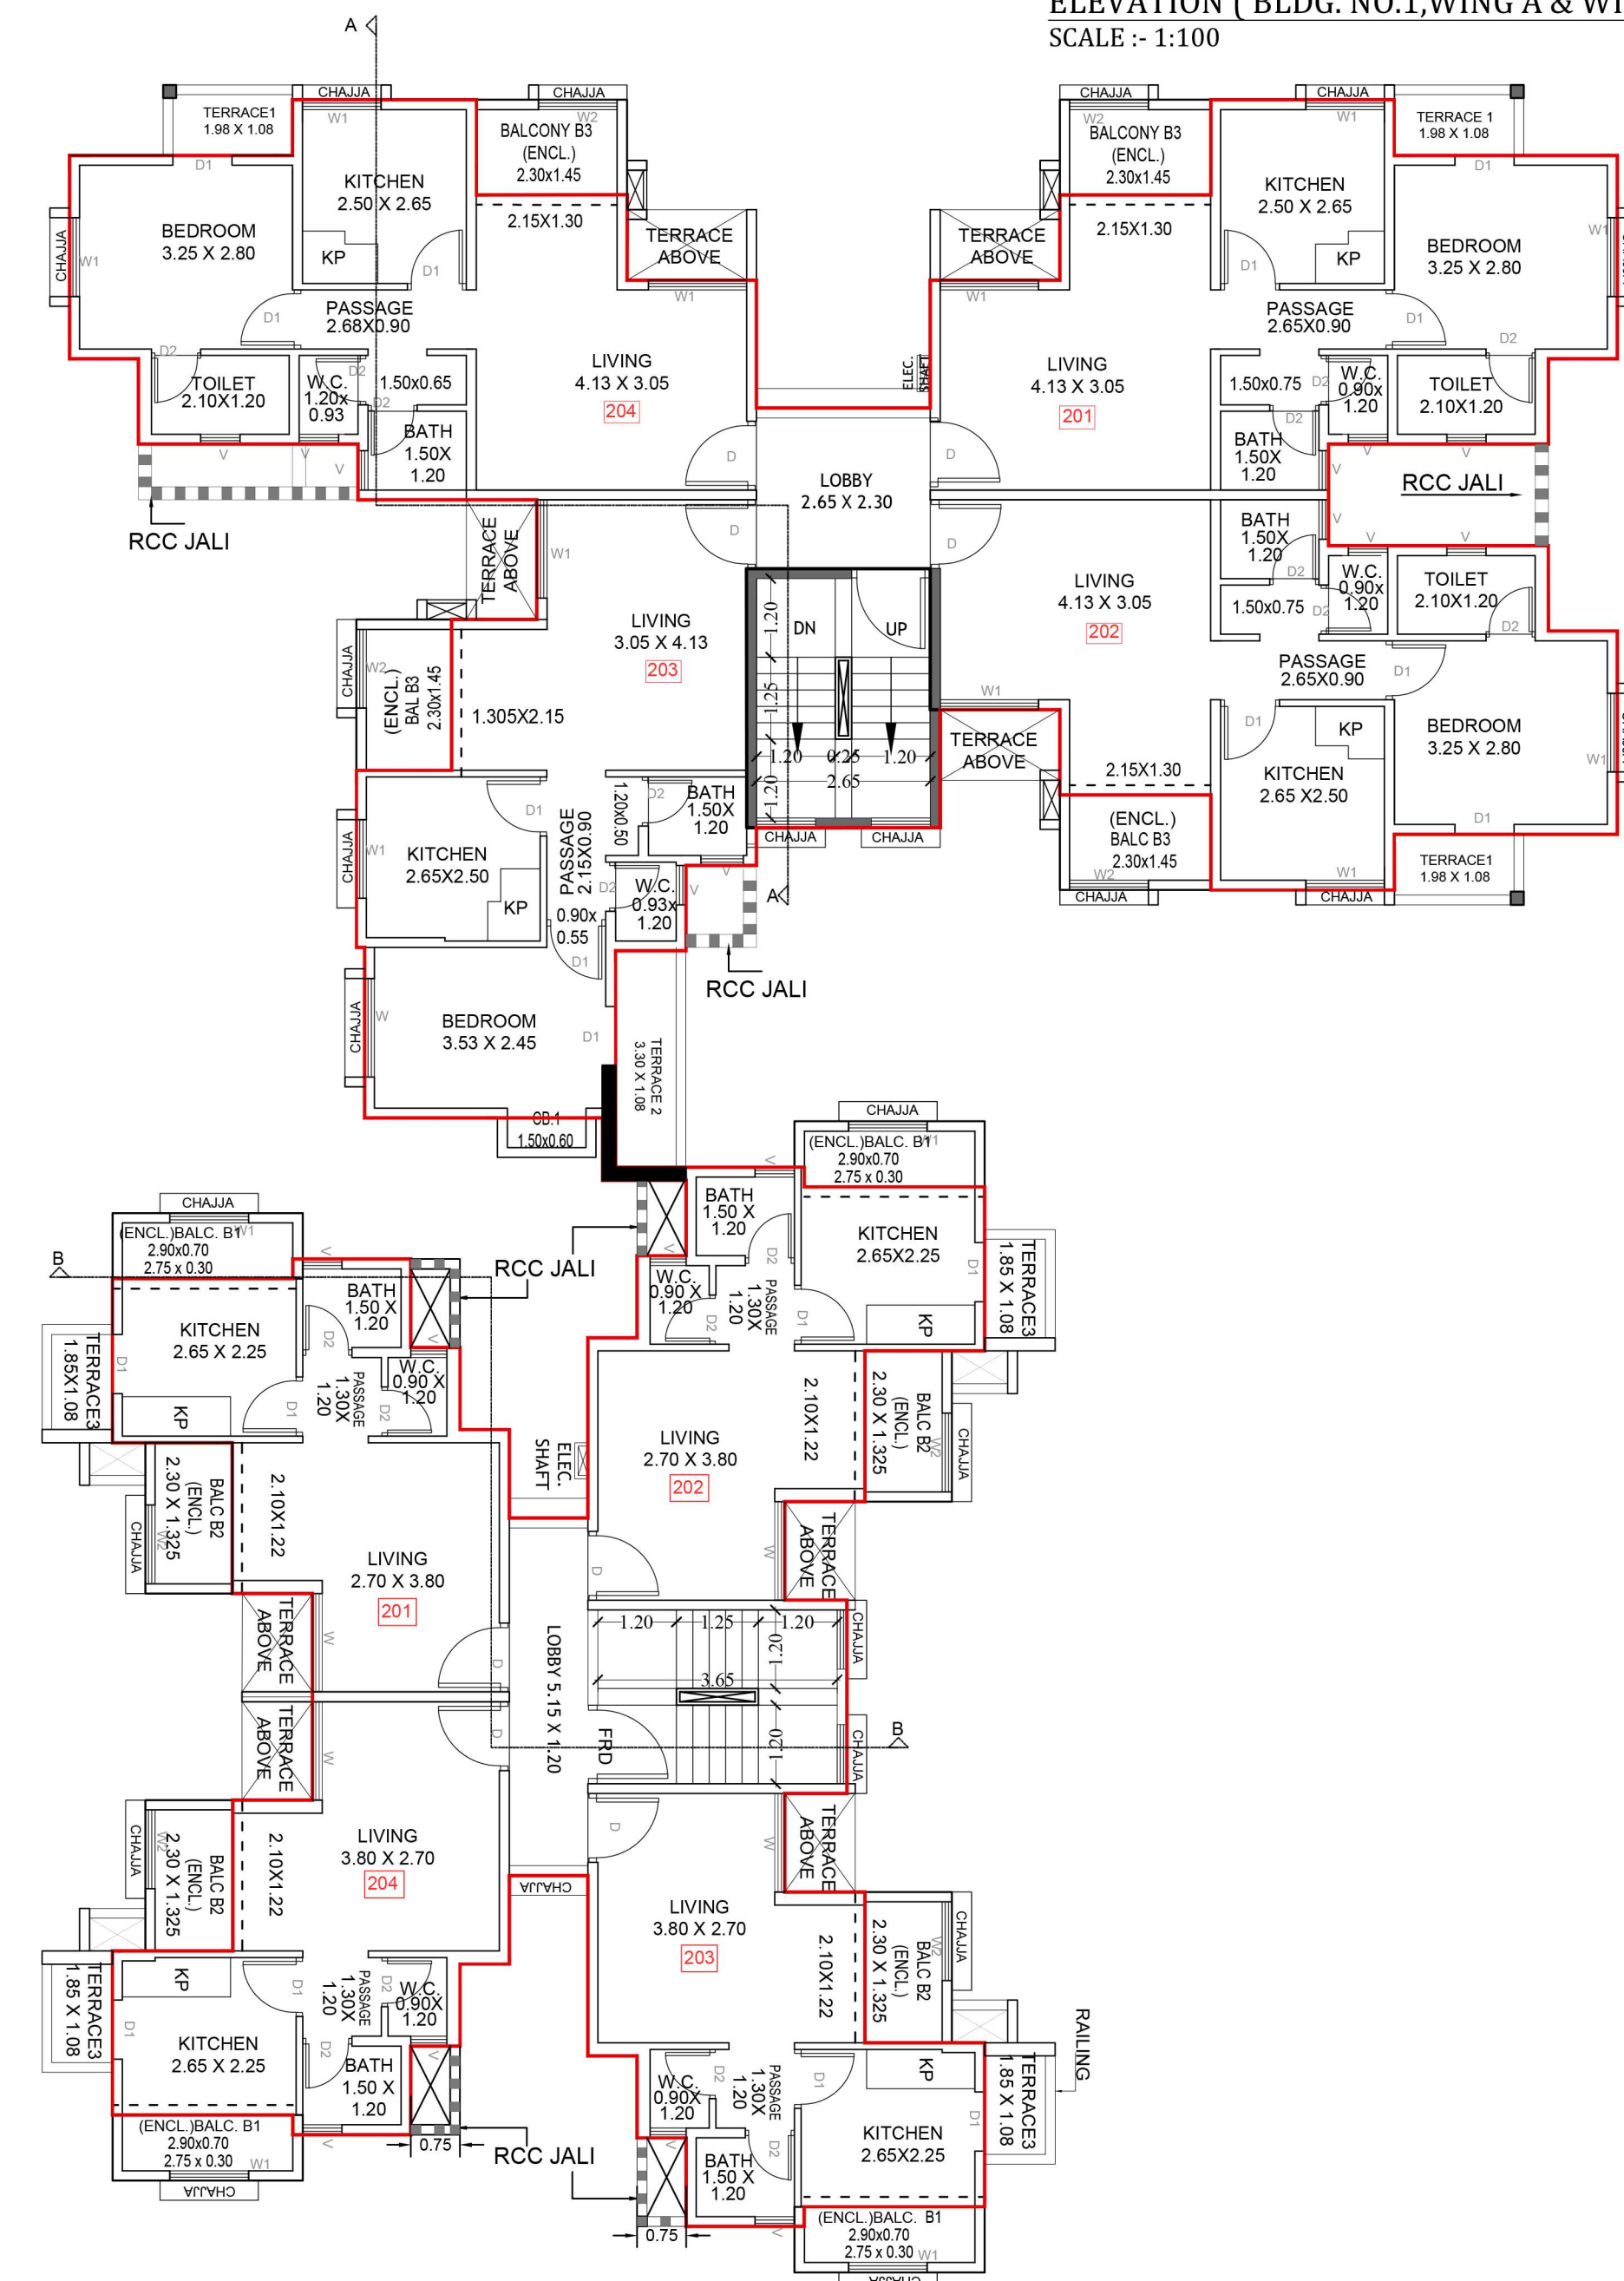

2ND FLOOR PLAN (BLDG NO.1,WING A & WING B)
SCALE :- 1:100

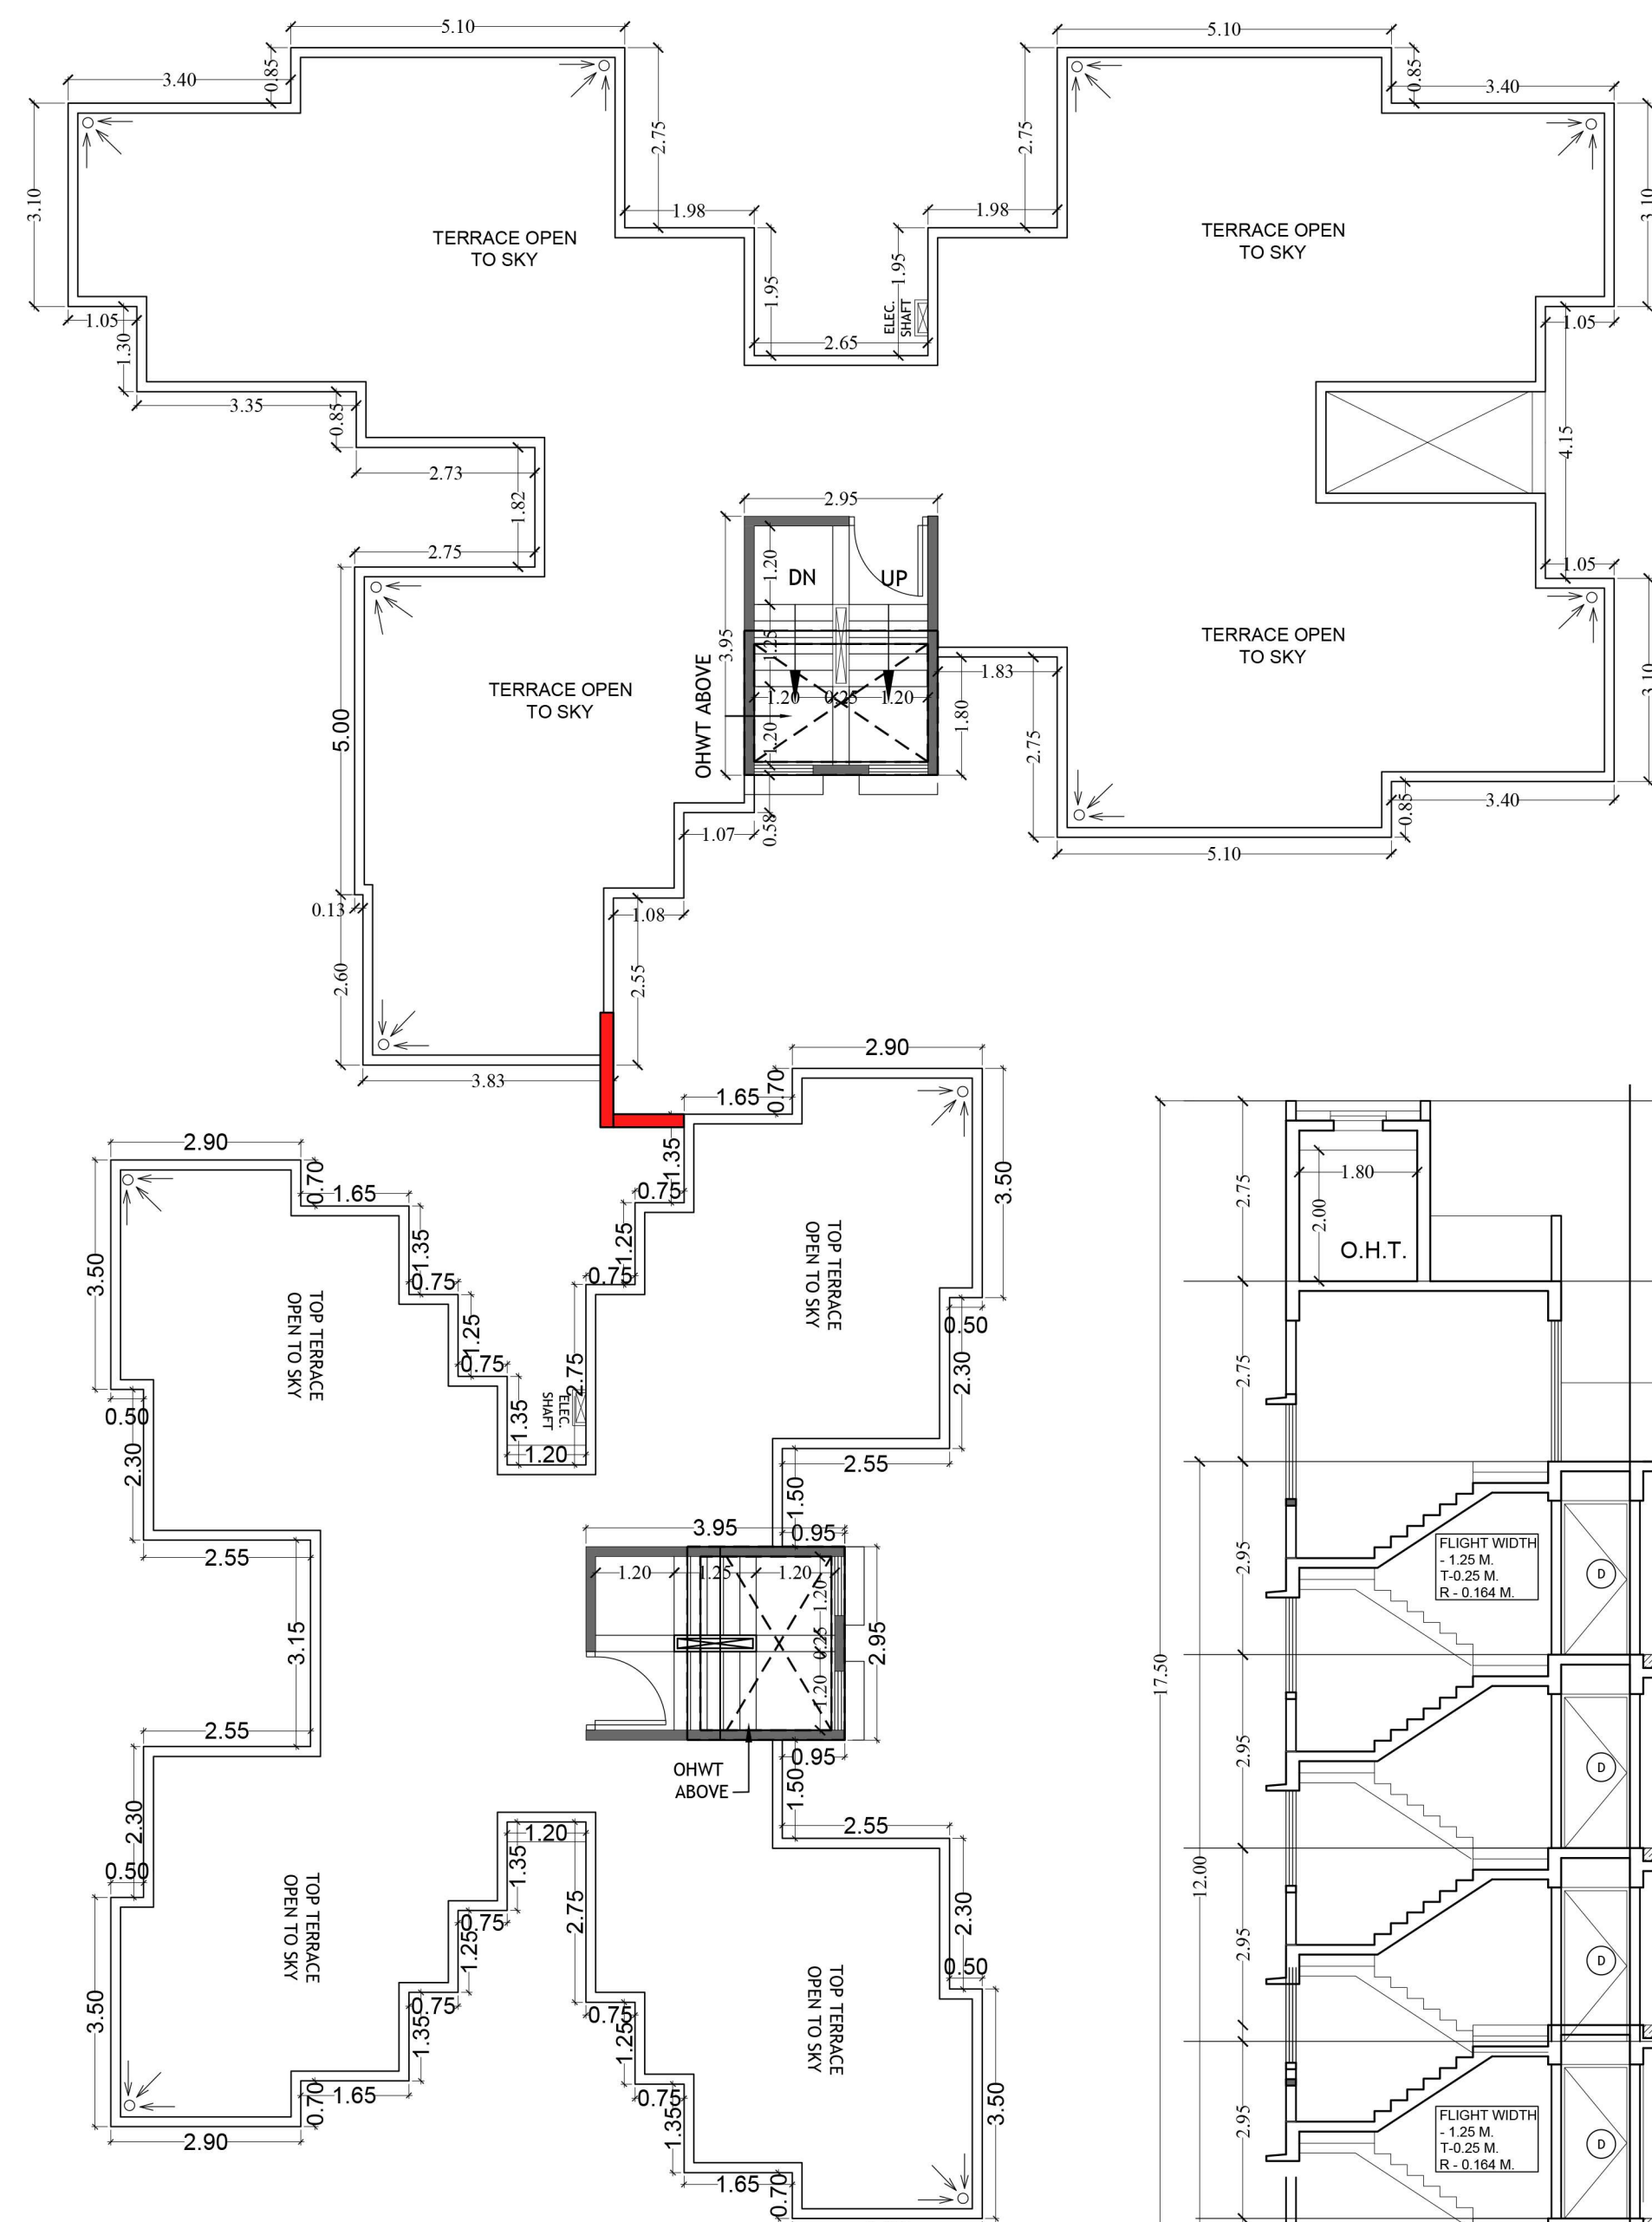

TERRACE FLOOR PLAN (BLDG NO.1,WING A & WING B)
SCALE :- 1:100

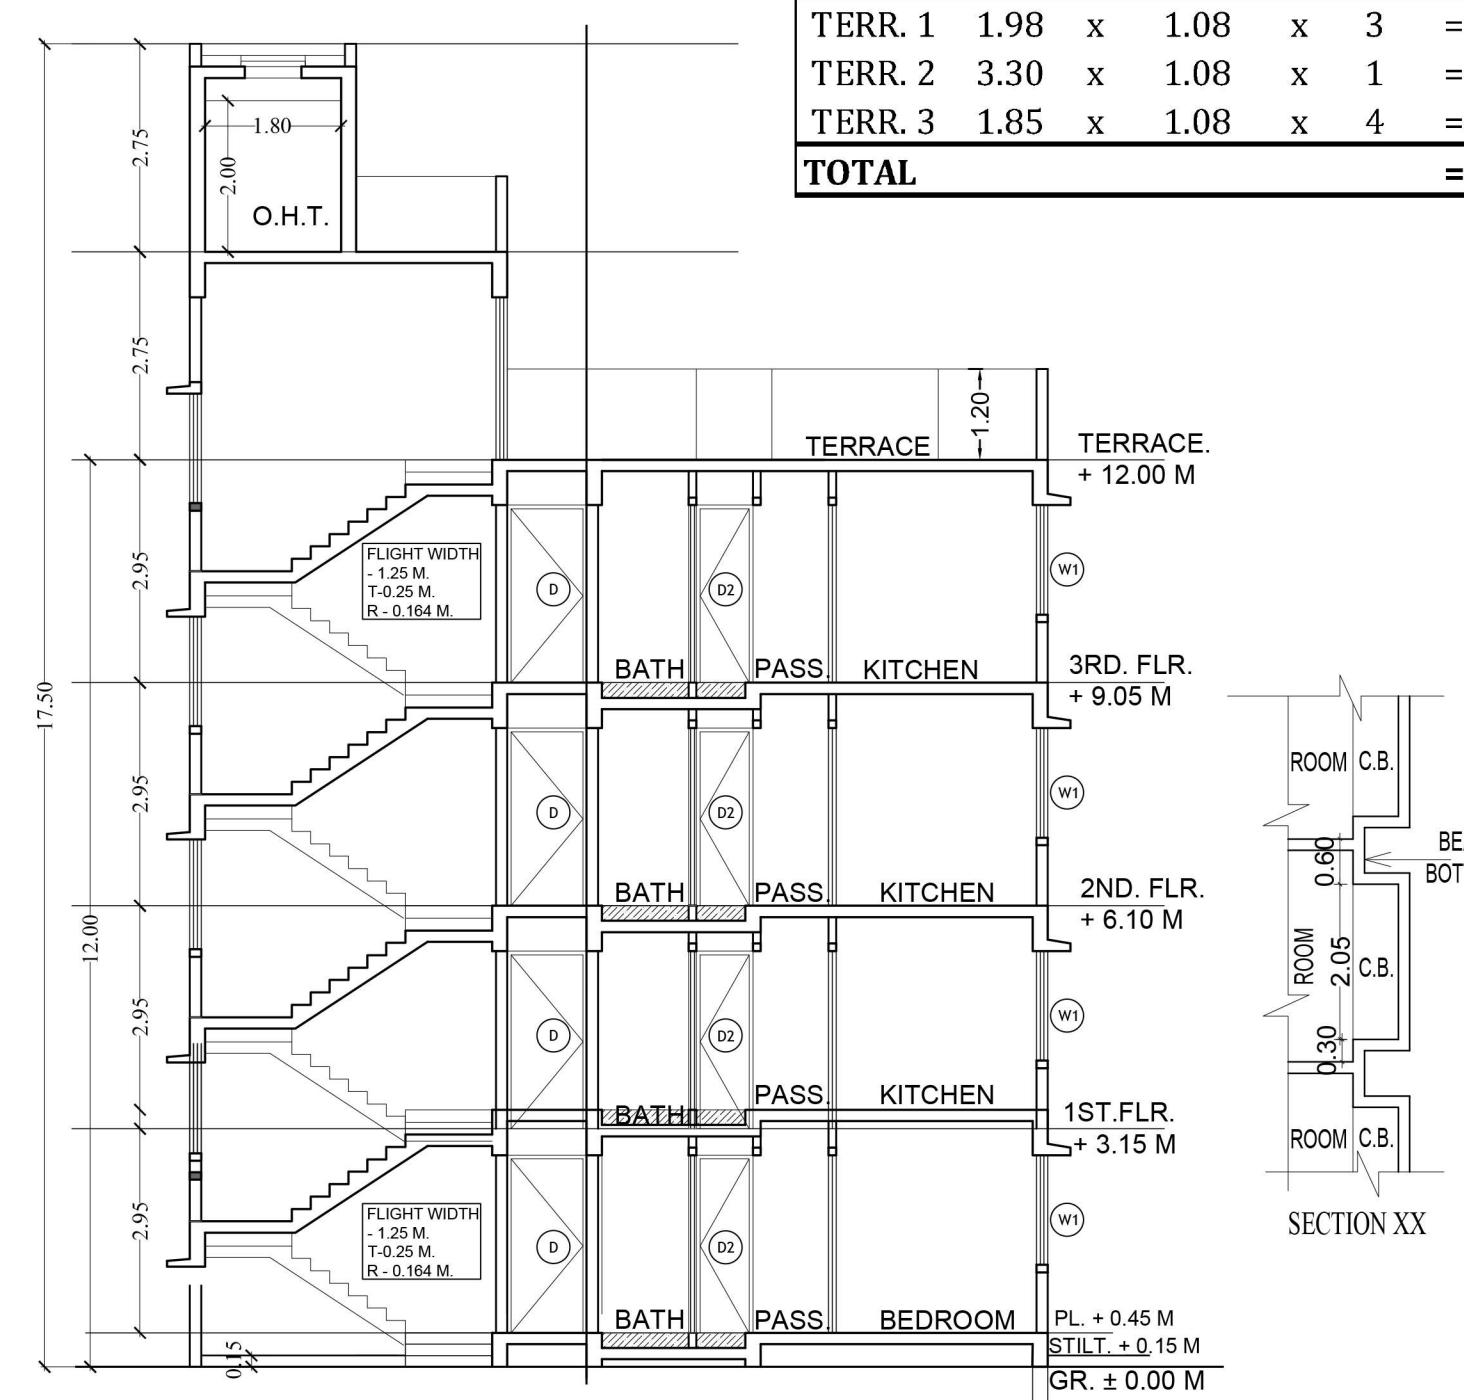

SECTION - AA (BLDG. NO.1,WING B)
SCALE :- 1:100

C.B. AREA STATEMENT (2nd floor)				
C.B. 1	1.50	x	0.60	x 1 = 0.900 SQ.MT.
TOTAL				= 0.900 SQ.MT.

TERRACE AREA STATEMENT (2nd FLOOR)				
PERMISSIBLE TERR.	301.20	x	20%	= 60.24 SQ.MT.
TERR. 1	1.98	x	1.08	x 3 = 6.38 SQ.MT.
TERR. 2	3.30	x	1.08	x 1 = 3.55 SQ.MT.
TERR. 3	1.85	x	1.08	x 4 = 7.96 SQ.MT.
TOTAL				= 17.88 SQ.MT.

DOOR SCHEDULE		
NAME	OPENING SIZE	LINTEL
D	1.05 X 2.35	2.35
D01	0.90 X 2.35	2.35
D02	0.75 X 2.35	2.35
D03	1.00 X 2.35	2.35
OP	0.90 X 2.35	2.35
SD	1.50 X 2.35	2.35

WINDOW SCHEDULE			
NAME	OPENING SIZE	LINTEL	SILL
W	1.50 X 1.45	2.35	0.90
W1	1.20 X 1.45	2.35	0.90
W2	1.20 X 0.90	2.35	1.45
W3	0.90 X 1.45	2.35	0.90
V	0.60 X 0.90	2.35	1.45

PROFORMA B03/03

CONTENTS OF SHEET

TYPICAL FLOOR PLAN & CALCULATION,B.U.AREA & GROSS B.U.AREA STATEMENT, TENAMENT AREA STATEMENT, PARKING AREA STATEMENT (BLDG NO.1,WING A)

STAMP & DATE OF APPROVAL OF PLAN

Amended Development permission Granted
Subject to the conditions mentioned in this office's letter no: CIDCO/NAINA/Panvel/Akurli/BP-00308/ACC/2020/0044
Dated : 18 Aug 2020

DESCRIPTION OF PROPOSAL & PROPERTY

PROPOSED DEVELOPMENT PERMISSION ON LAND BEARING GUT NO. 99/5 AT VILLAGE - AKURLI, TAL - PANVEL DIST - RAIGAD

NORTH

JOB. NO.

DRG. NO.

DRAWN BY

03/03

SCALE

DATE

CHECKED BY

1:100

-

-

REVISIONS

DESCRIPTION :

R-0

NAME OF THE OWNER

SIGNATURE

SHRI VIDIP VINODKUMAR JATIA

FOR SQUARE ONE HOUSING CORPORATION (PROPRITOR)

NAME OF ARCHITECT

DEVYANI KHADILKAR

LIC. NO.

CA/90/13184

ADDRESS

8-106, Natraj Building, Mulund Goregaon Link Road Mulund (w), Mumbai - 400 080