

Block escriptio	Number of blocks	Length (meter)	Breath (meter)		Area (sqm.)
1	1	40.200	14.275	-	573.855
		St	JBTOTAL : A	=	573.855
			DEDUCTI	ON	
1	1	6.900	1.375	=	9.488
2	1	1.050	3.475		3.649
3	1	2.650	1.375		3.644
4	2	2.850	0.550	=	3.135
5	2	2.850	1.050	-	5.985
6	1	2.650	1.875	=	4.969
7	1	1.050	3.975		4.174
8	1	4.100	1.875	-	7.688
10	1	2.850	3.600	=	10.260
11	2	1.300	1.000	-	2.600
12	1	2.600	2.150	-	5.590
13	1	2.850	3.525	=	10.046
14	1	3.000	0.975	=	2.925
15	1	2.650	1.800	-	4.770
15 A	1	2.650	4.500		11.925
16	1	2.850	0.975	-	2.779
				=	1.275
16 A	1	3.000	0.425	=	
17	1	2.850	0.925	=	2,636 4,204
17A	1	2.850	1.475	-	7-1000000
18	1	2.650	2.300	=	6.095
19	1	2.500 5.450	0.125	=	0.313 12.535
20	1	4.400	2.300 0.925	=	4.070
22	2	1.500	4.150	-	12.450
23	1	2.200	2.150		4.730
24	2	1.000	0.800		1,600
25	2	2.200	1.800	=	7.920
26	2	1.300	2.150	=	5.590
27	1	2.450	3.650	=	8.943
28	2	1.150	0.500	-	1.150
29	2	2.650	2.100	=	11.130
30	2	2.500	2.600		13.000
31	1	2.400	1.200	=	2.880
32	1	3.200	1.200	-	3.840
		-	JBTOTAL : B	=	197.985
NET BUI	LT UP AREA (-	375.870

BUILDING-1

BALCONY AREA STATEMENT

			4TH F	LOOR			
BALCONY	LENGTH	BREATH		NUMBER	Al	REA IN SQ	М.
TYPE	(METER)	(METER)	TOTAL	OF BALCONY	PARTLY ENCLOSED	OPEN	ENCLOSED
OPEN B2	2.850	1.600	4.560	2	0.000	9.120	0.000
OPEN B3	2.900	1.800	5.220	1	0.000	5.220	0.000
OPEN B4	3.000	1.600	4.800	2	0.000	9.600	0.000
ODEN DE	2.900	0.975	2.828		0.000	2.828	0.000
OPEN B6	2.750	0.825	2.269	1	0.000	2.269	0.000
OPEN B5	2.850	1.800	5.130	2	0.000	10.260	0.000
OPEN B7	2.500	1.500	3,750	1	0.000	3.750	0.000
OPEN B8	2.500	1.125	2.813	1	0.000	2.813	0.000
			SUBTOTAL	10	0.000	45.859	0.000
TOTA	L PROPOSEI	BALCONY	AREA PER F	LOOR		45.859	
	NET BUIL	T UP AREA	OF FLOOR			375.870	
PERMISSI		Y AREA PER	R FLOOR = (N 5 %	ET BUILT		56.381	
BAL	ANCE BALCO	NY AREA PE	ER FLOOR, IF	ANY		10.522	

TERRACE AREA STATEMENT 4TH FLOOR

EXCESS BALCONY AREA PER FLOOR, IF ANY


TERRACE TYPE	LENGTH (METER)	BREATH (METER)	TOTAL	NUMBER OF TERRACE	AREA IN SQM.
Tra .	4.300	1.550	6.665		13.330
T1	4.150	1.500	6.225	2	12.450
T2	2.850	2.550	7.268	2	14.535
	3,000	0.550	1.650	1 *	3.300
Т3	2.650	2.700	7.155	1	7.155
T4	2.800	1.350	3.780		3.780
1975	2.650	0.825	2.186	•	2.186
	SUBT	OTAL		6	56.736
	TOTAL PRO	POSED TERR	RACE AREA	4TH FLOOR	56.736
	NET B	UILT UP ARI	EA OF PER	FLOOR	375.870
PERMISSIE	75.174				
BALANCE TERRACE AREA EACH 4TH FLOOR					18.438
	EXCESS '	TERRACE AR	EA EACH 47	TH FLOOR	NA

STAMP OF APPROVAL 4/17

BUILDING NO.1

Approved subject to the condition mentioned in this office letter no.

CIDCO/NAINA/Panvel/Vihighar/BP-63/ACC/2020/52 Dated 16/10/2020

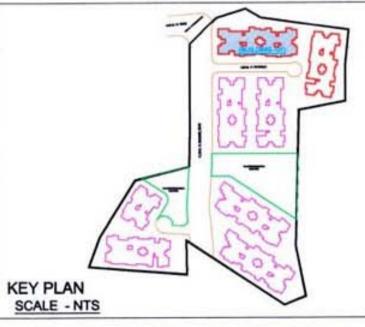

ALL DIMENSIONS ARE IN METERS.

 INTERNAL WALL THICKNESS 0.10 M. EXTERNAL WALL THICKNESS 0.15 M.

CONTENT OF THE SHEET

GR., 1ST, 2ND, 3RD & 4th FLOOR PLAN, AREA DIAGRAM & CALCULATION, TERRACE FLOOR PLAN, SECTION AA & BB, ELEVATION OF (BUILDING -01).



AR. SWAPNIL KALYANKAR

M/s. Prayag Builders & Devlopers through Prayag Bulliars & Developers

1) MR. PRADEEP KRUSHNA BARON

REGD. NO. CA / 2010 / 47491 (Signature of Architect.)

(Signature of OWNER)

NAME OF THE OWNER

1) (MR. PRADEEP KRUSHNA BHOPI)


DESCRIPTION OF PROPOSAL & PROPERTY


Proposed Residential Building On Land Bearing Survey No. 100 / 5B , At Village - Vihighar, Tal- Panvel, Dist Raigad, Maharastra.

ARCHITECT NAME & SIGNATURE

JOB NO. DWG. NO. DATE 25-09-2020 SCALE 1: 100 , N.T.S. DRN BY KISHOR THAKUR SWAPNIL KALYANKAR CHKD BY



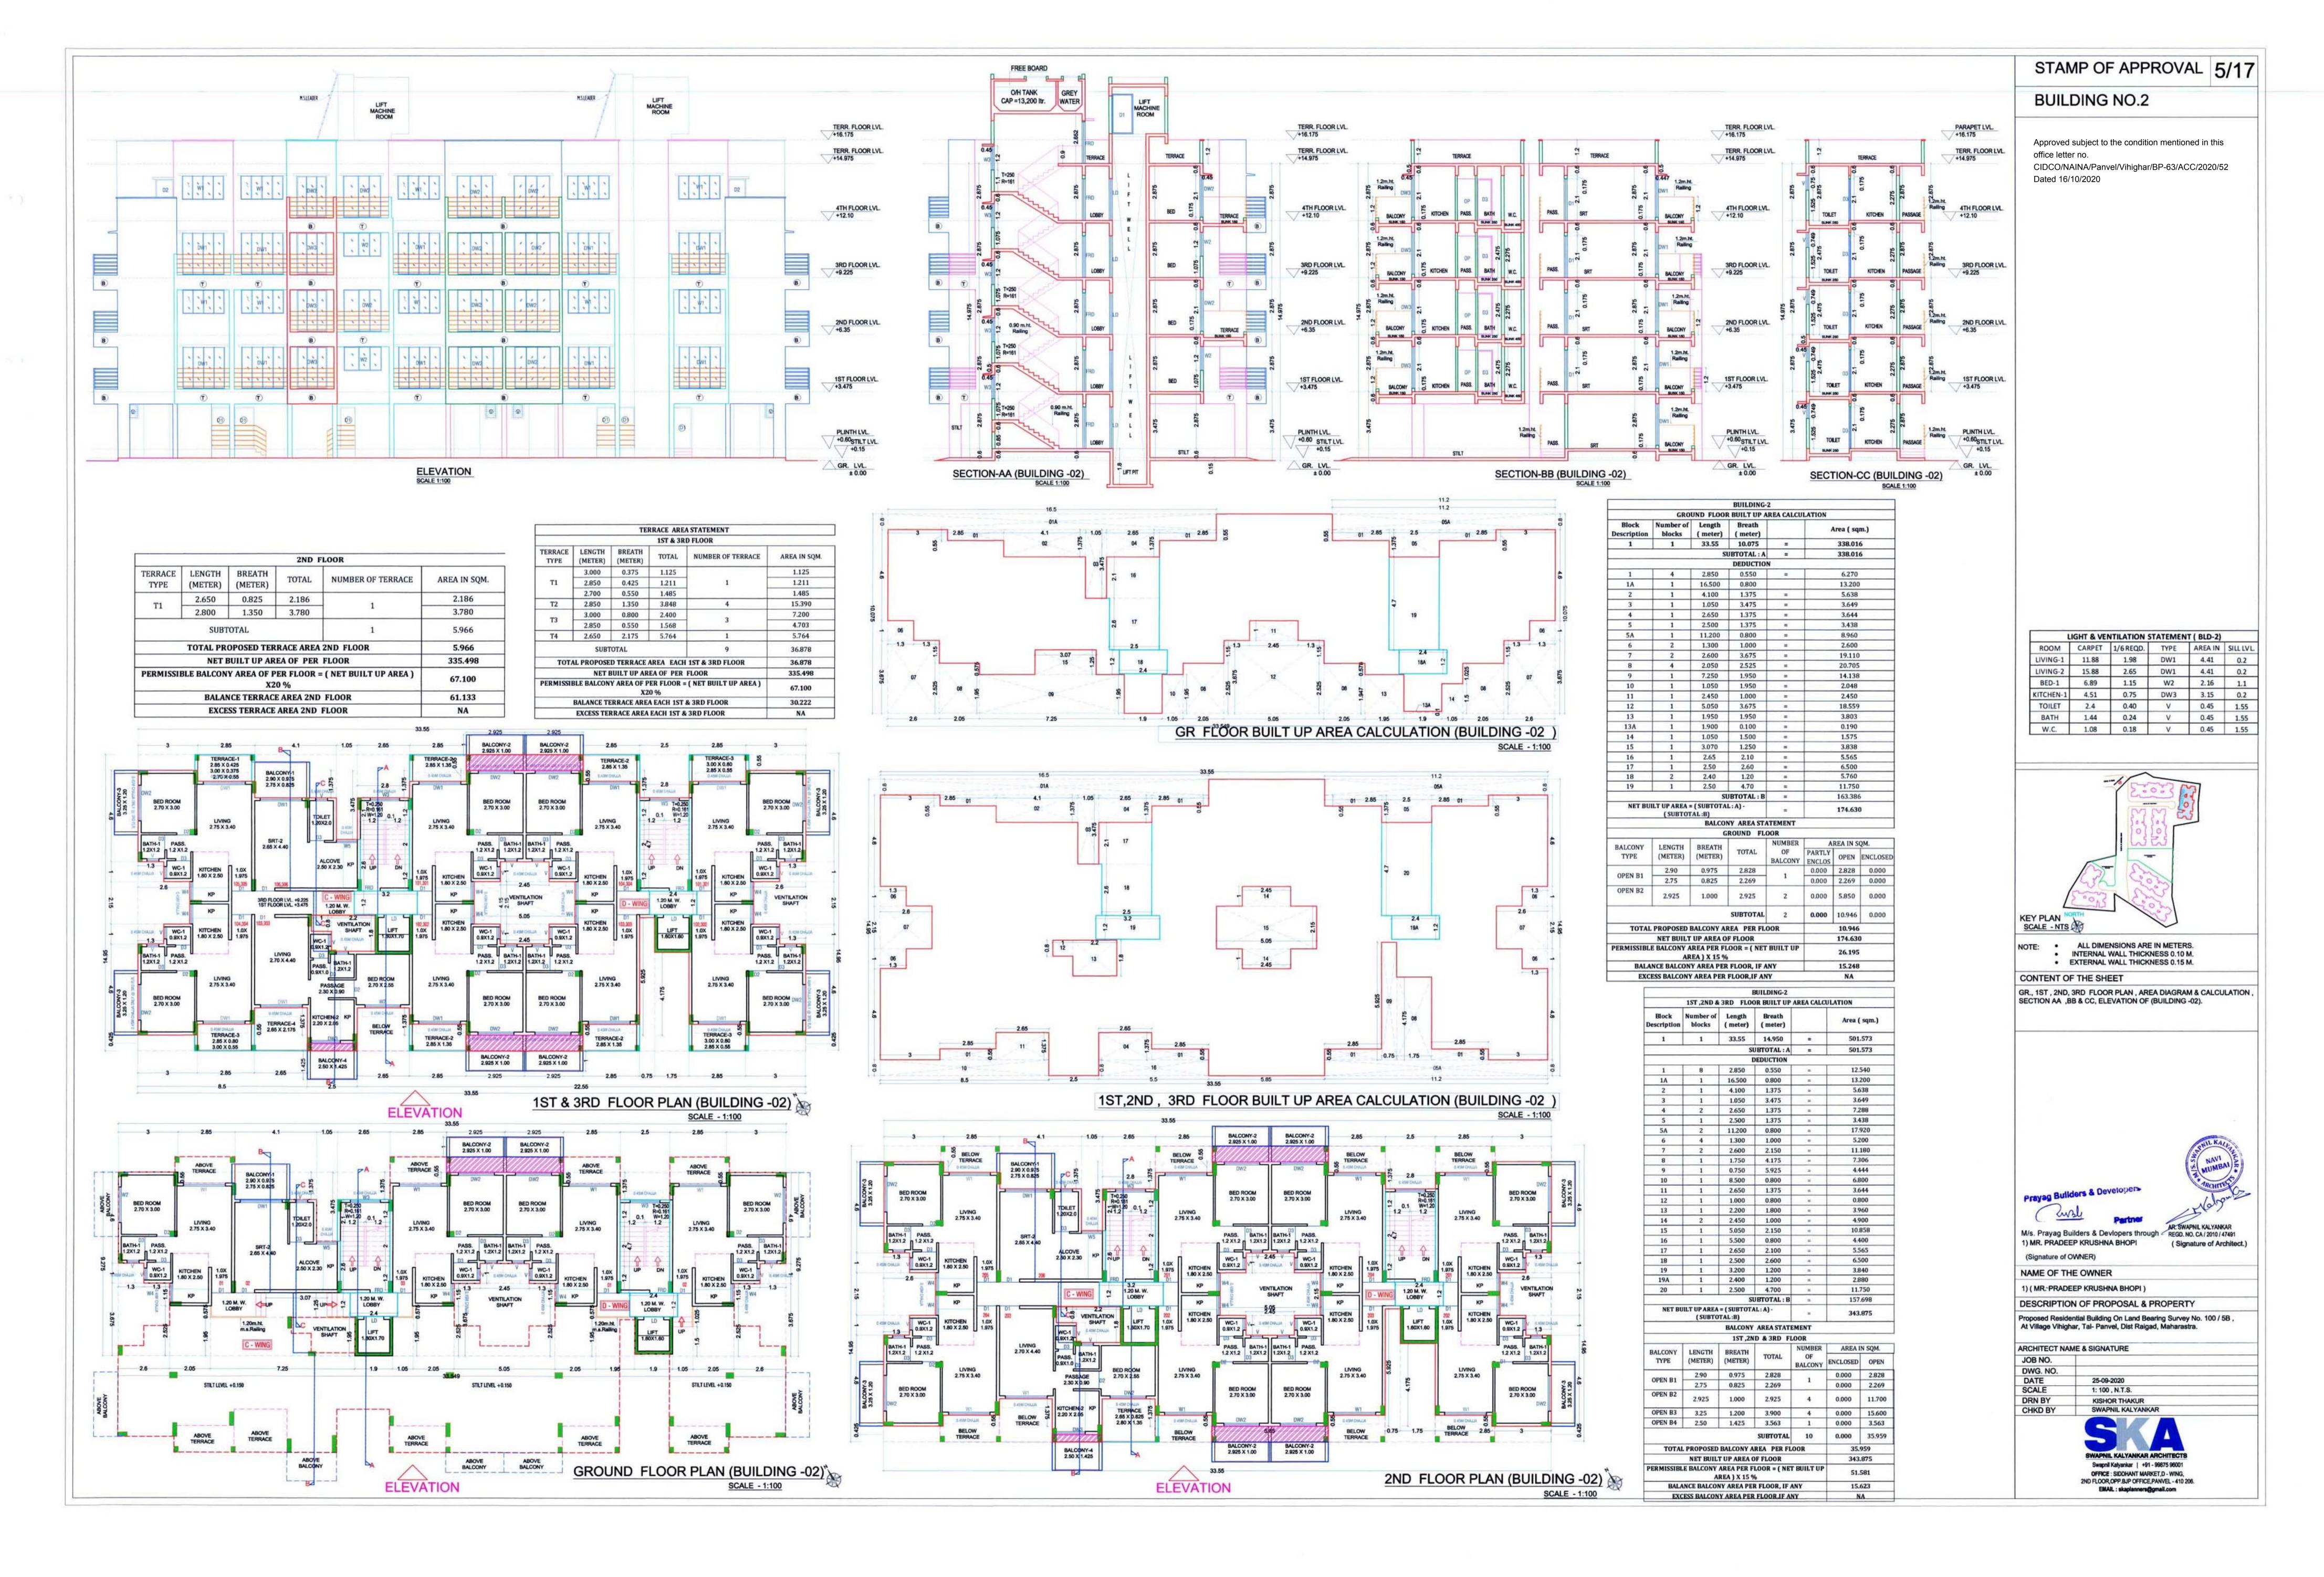

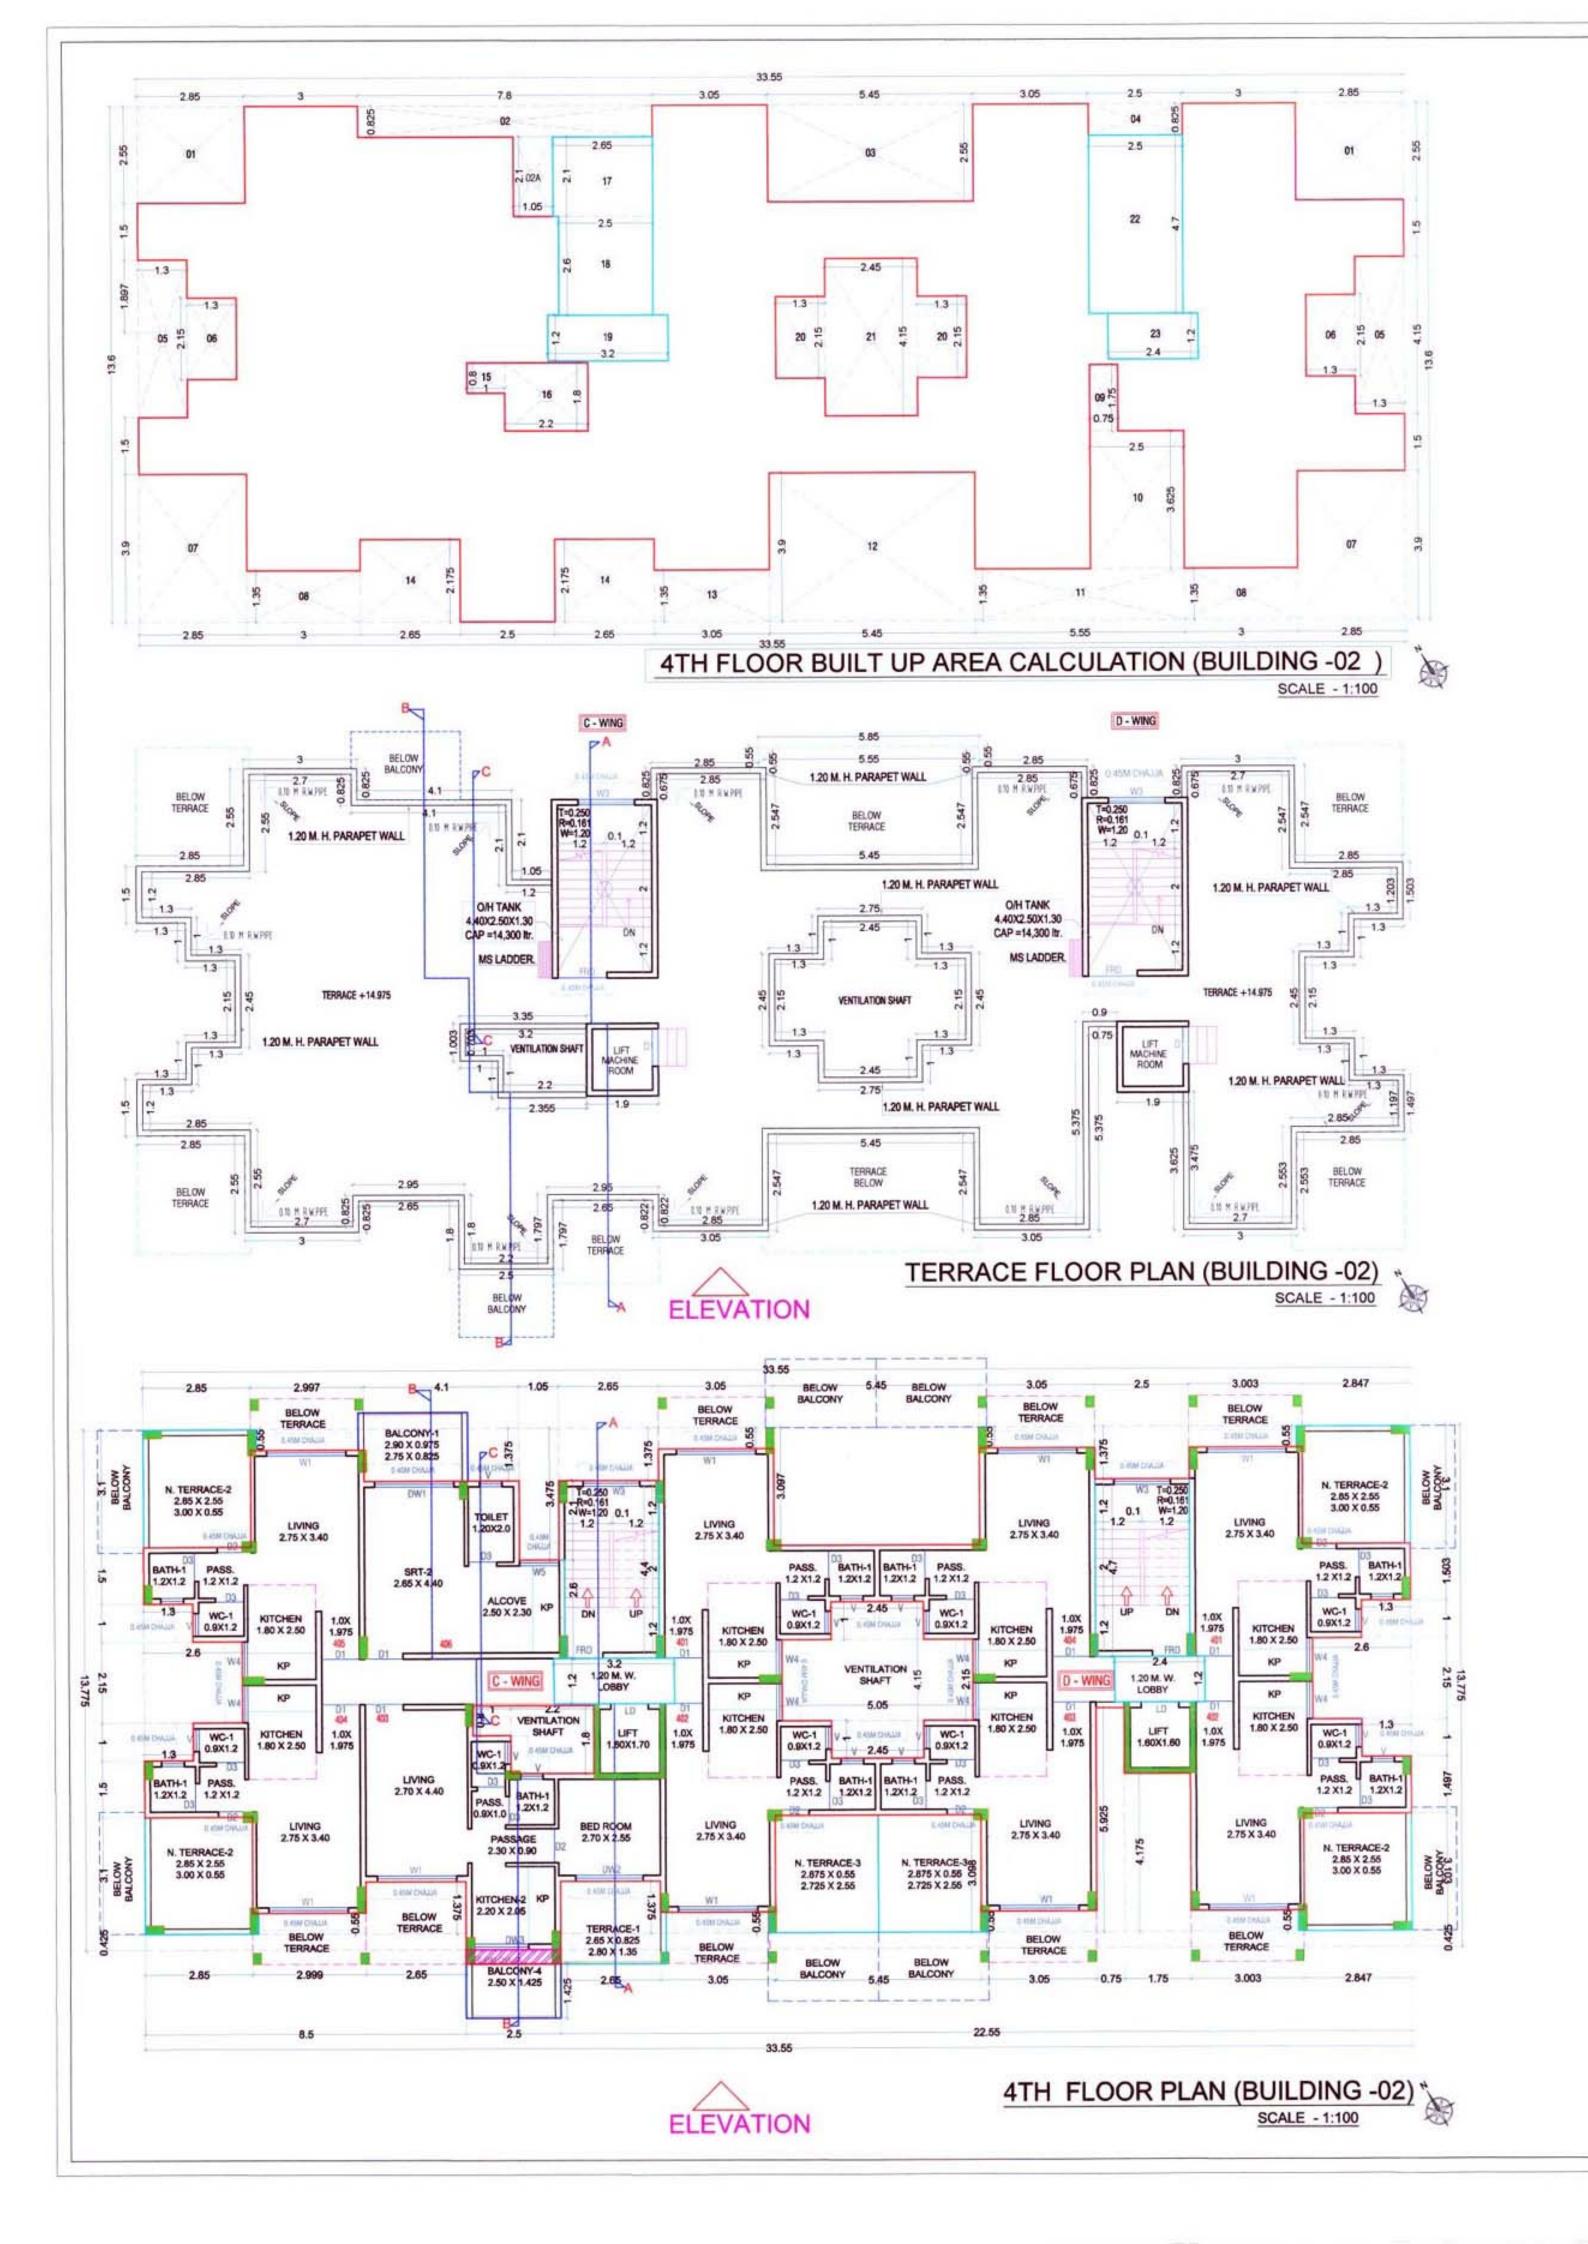


STAMP OF APPROVAL 6/17

BUILDING NO.2

Approved subject to the condition mentioned in this office letter no.

CIDCO/NAINA/Panvel/Vihighar/BP-63/ACC/2020/52 Dated 16/10/2020

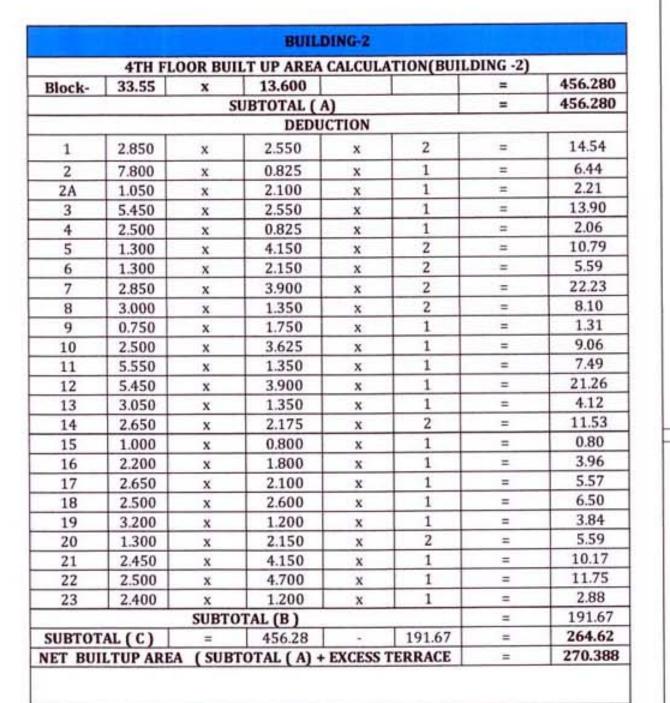


BALCONY AREA STATEMENT

			4TH	FLOOR			
BALCONY	LENGT	BREATH	TOTAL	NUMBER		AREA IN SO	QM.
TYPE	Н	(METER)	TOTAL	OF	PARTLY	OPEN	ENCLOSED
	2.90	0.975	2.828		0.000	2.828	0.000
OPEN B1	2.75	0.825	2.269	1	0.000	2.269	0.000
OPEN B2	2.50	1.425	3.563	1	0.000	3.563	0.000
			UBTOTAL	2	0.000	8.659	0.000
TOTAL P	ROPOSEI	BALCONY	AREA PER	RFLOOR		8.659	
1	NET BUIL	T UP AREA	OF FLOOR		0	264.615	
PERMISSI	BLE BAL	CONY AREA	PER FLOO	R = (NET	1	39.692	
BALANCE BALCONY AREA PER FLOOR, IF ANY					31.034		
EXCES	S BALCO	NY AREA PE	R FLOOR,I	F ANY		NA	

		TES	RRACE ARE	EA STATEMENT	
			4TH	FLOOR	
TERRACE TYPE	LENGT H	BREATH (METER)	TOTAL	NUMBER OF TERRACE	AREA IN SQM
Tra	2.650	0.825	2.186		2.186
T1	2.800	1.350	3.780	1	3.780
ma	2.850	2.550	7.268	4	29.070
Т3	3.000	0.550	1.650	4	6.600
T4	2.875	0.550	1.581	2	3.163
65.50	2.725	2.550	6.949	N. C.	13.898
	SUB	TOTAL		7	58.696
TOT	AL PROP	OSED TERR	RACE AREA	4TH FLOOR	58.696
	NET BU	ILT UP ARE	A OF PER	FLOOR	264.615
PERMISSI	BLE BALC	CONY AREA	OF PER FLO	OOR = (NET BUILT	52.923
	BALANC	E TERRACE	AREA 4TH	FLOOR	0.000
	EXCESS	TERRACE	AREA 4TH	FLOOR	5.77

		9	CHEDU	LE OF DOO	RS & WINDOWS	
TYPE	SIZ	E IN M	M	AREA IN	DISCREPTION	SILL LVL.
FRD	1	Х	2.1	2.1	DOOR	
D1	1	X	2.1	2.1	T.W. PANEL DOOR	
D2	0.9	X	2.1	1.89	T.W. PANEL DOOR	
D3	0.75	X	2.1	1.575	T.W. PANEL DOOR	
DW1	2.1	X	2.1	4.41	AL. SLIDING FRENCH WINDOW	0.2
DW2	1.8	X	2.1	3.78	AL SLIDING FRENCH WINDOW	0.2
DW3	1.5	X	2.1	3.15	AL. SLIDING FRENCH WINDOW	0.2
W1	2.1	X	1.2	2.52	AL. SLIDING WINDOW	1.1
W2	1.8	X	1.2	2.16	AL. SLIDING WINDOW	1.1
W3	1.5	X	1.2	1.8	AL. SLIDING WINDOW	1.1
W4	1	X	1.2	1.2	AL. SLIDING WINDOW	1.1
W5	1.05	X	1.2	1.26	AL. SLIDING WINDOW	1.1
٧	0.6	X	0.75	0.45	ALLOUVERD WINDOW	1.55

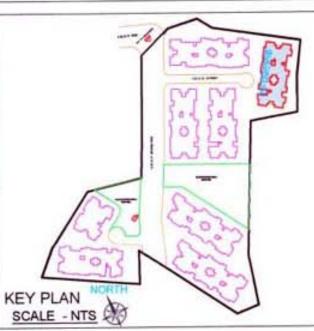

ALL DIMENSIONS ARE IN METERS INTERNAL WALL THICKNESS 0.10 M. EXTERNAL WALL THICKNESS 0.15 M.

CONTENT OF THE SHEET

4th FLOOR PLAN, AREA DIAGRAM & CALCULATION, TERRACE FLOOR PLAN.



M/s. Prayag Builders & Devlopers through
1) MR. PRADEEP KRUSHNA BHOPI

REGD. NO. CA / 2010 / 47491 (Signature of Architect.)

(Signature of OWNER) NAME OF THE OWNER

1) (MR. PRADEEP KRUSHNA BHOPI)


DESCRIPTION OF PROPOSAL & PROPERTY


Proposed Residential Building On Land Bearing Survey No. 100 / 5B , At Village - Vihighar, Tal- Panvel, Dist Raigad, Maharastra.


ARCHITECT NAME & SIGNATURE


JOB NO.		
DWG. NO.		
DATE	25-09-2020	
SCALE	1: 100 , N.T.S.	
DRN BY	KISHOR THAKUR	
CHKD BY	SWAPNIL KALYANKAR	




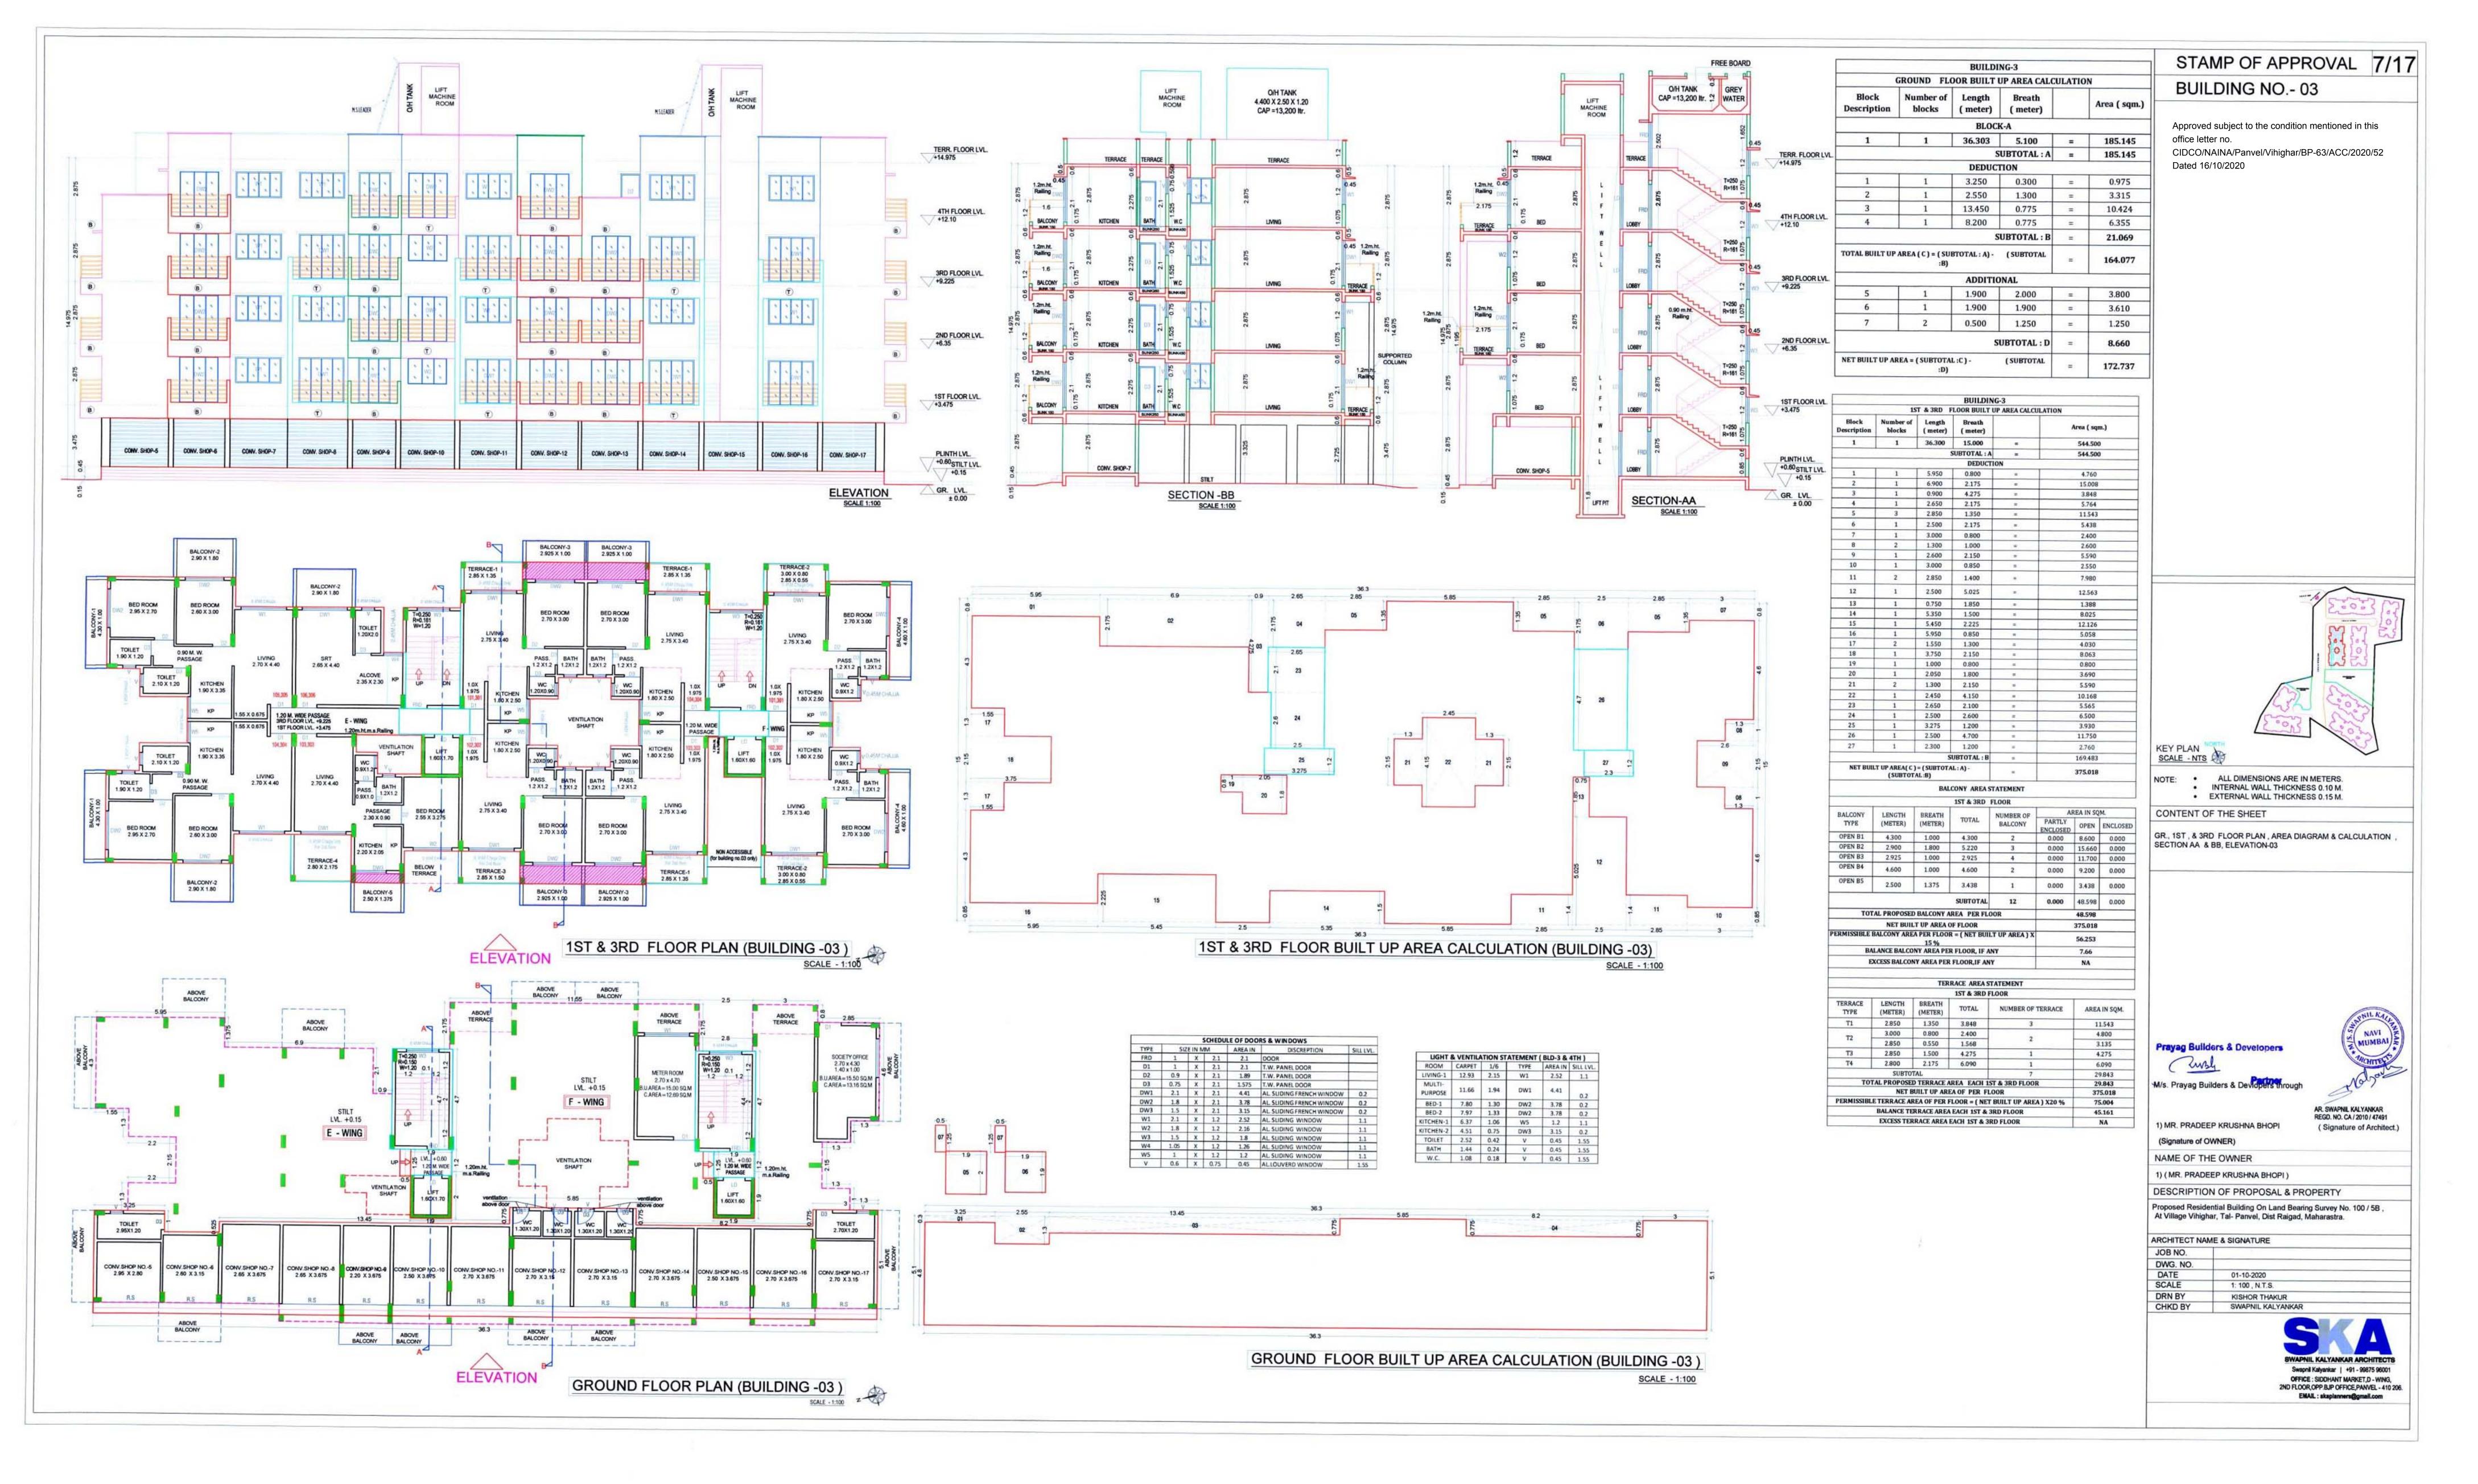


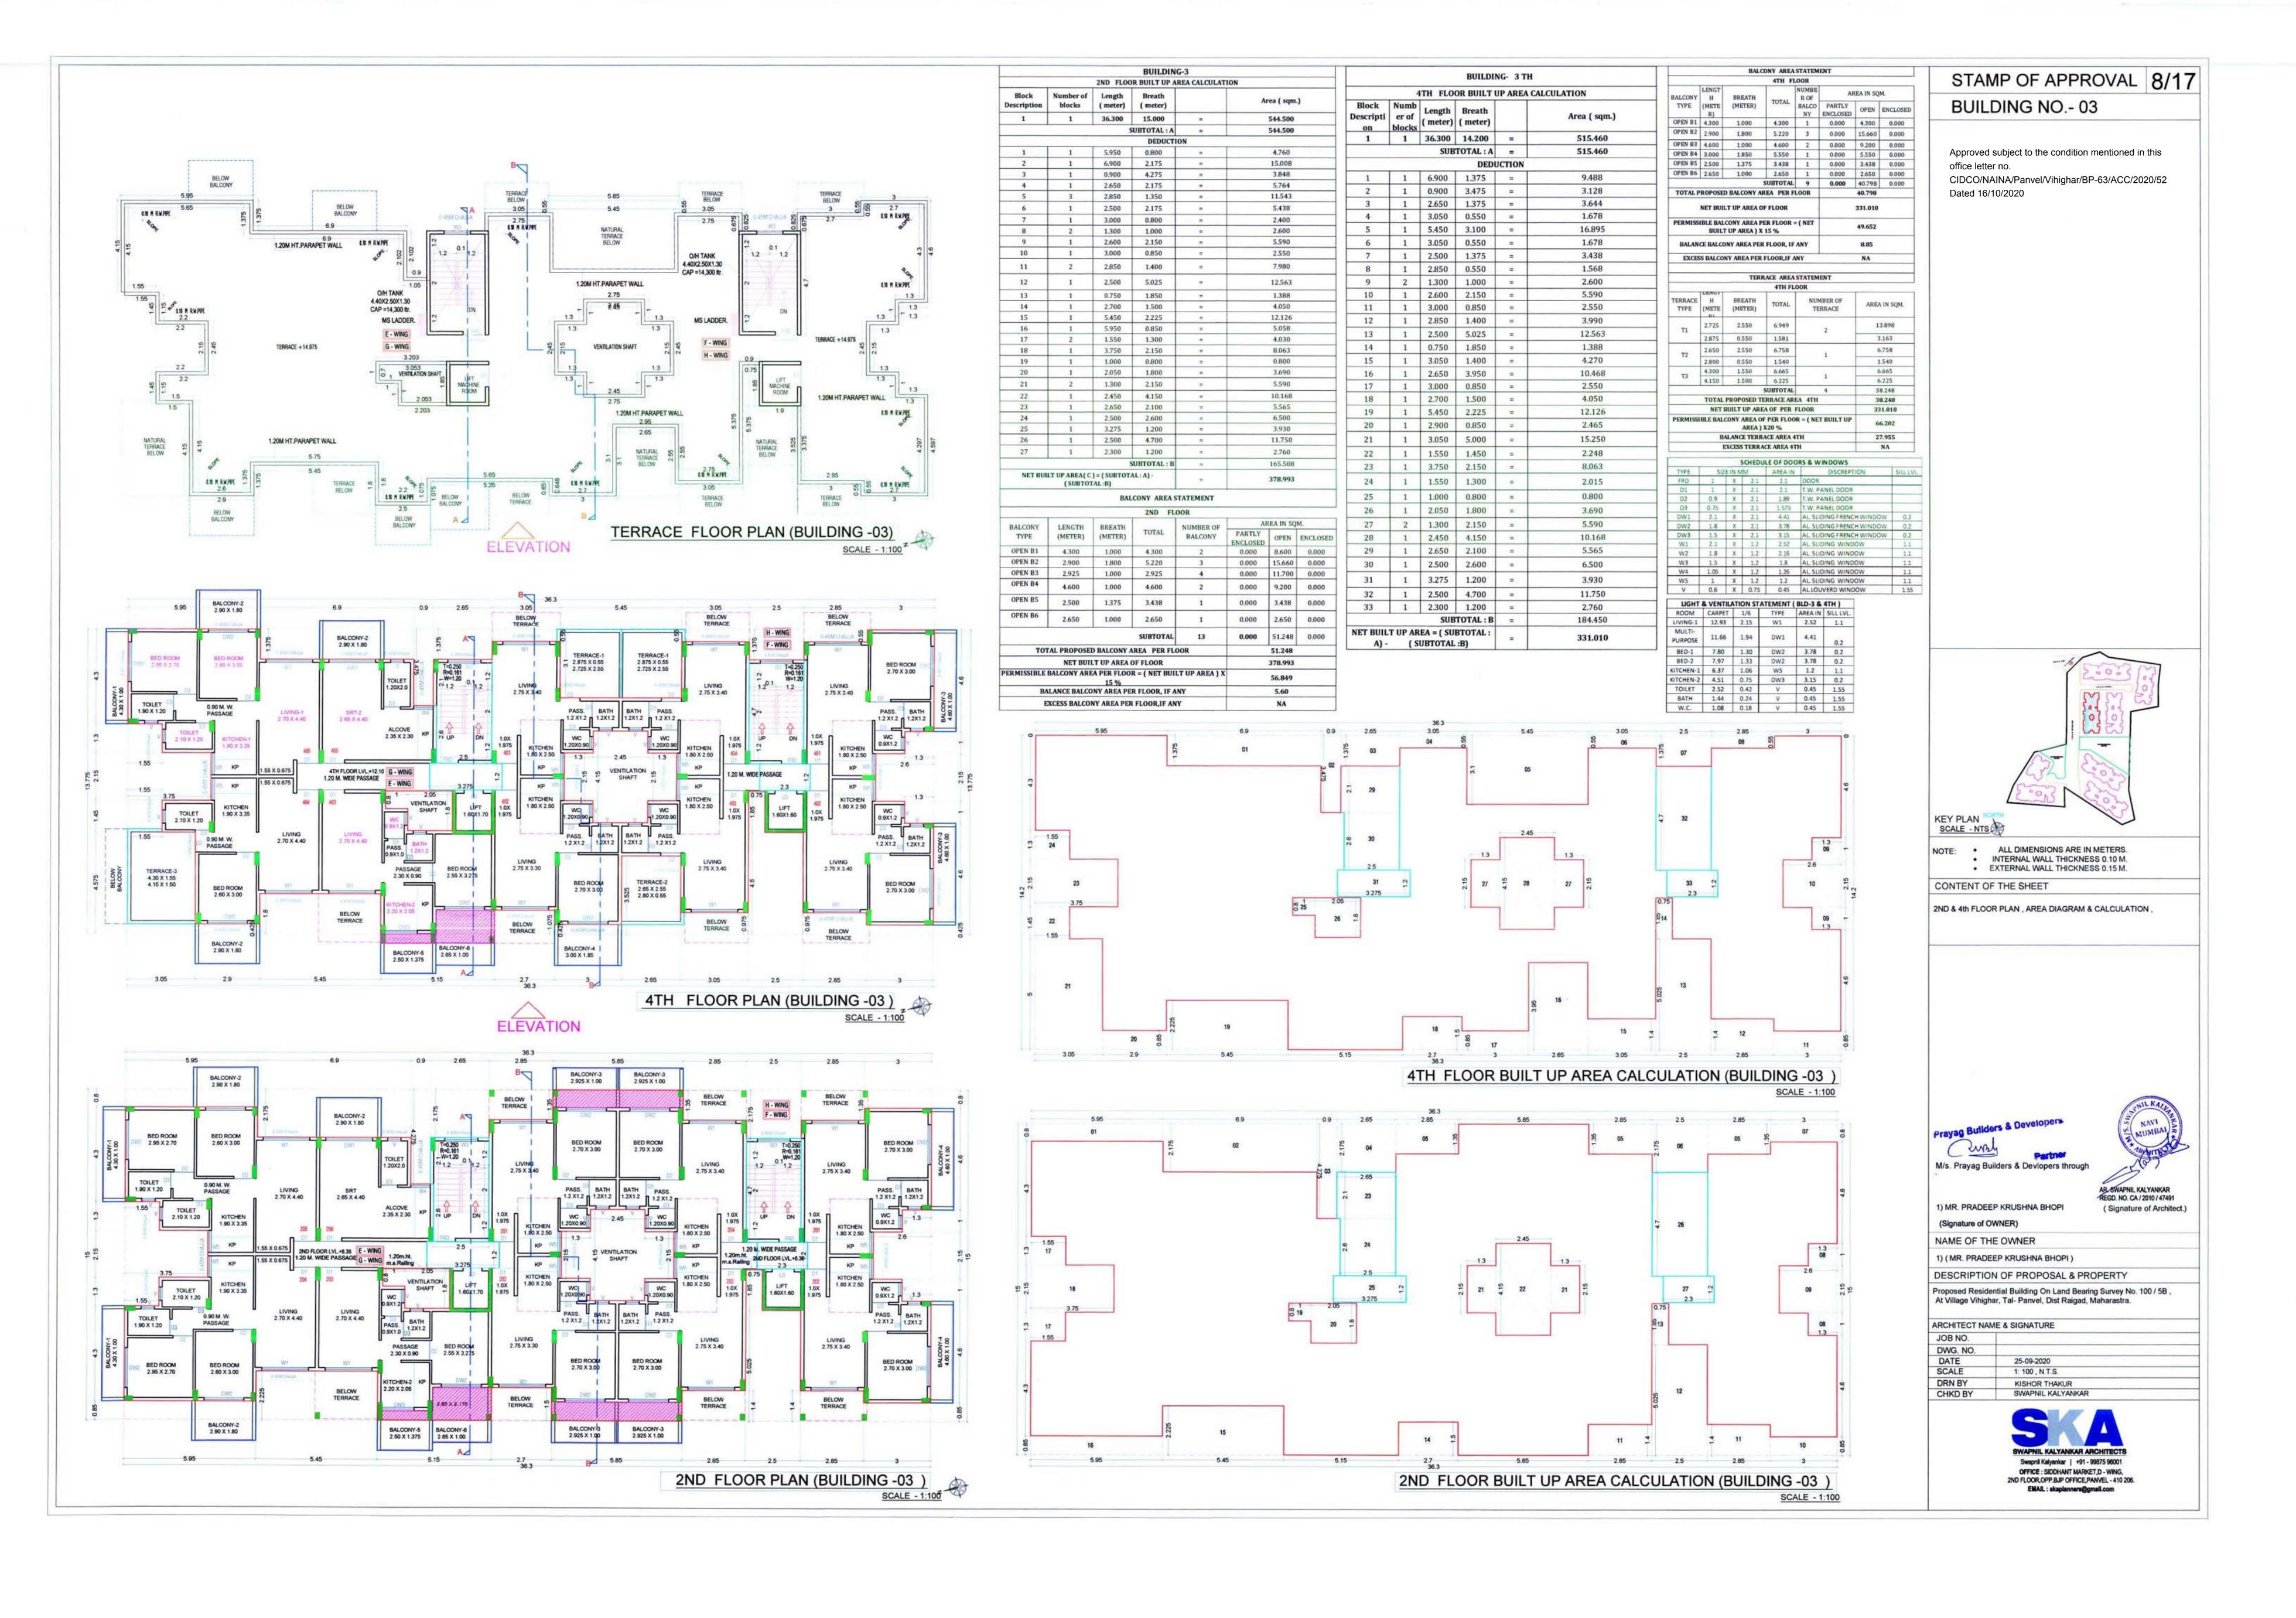

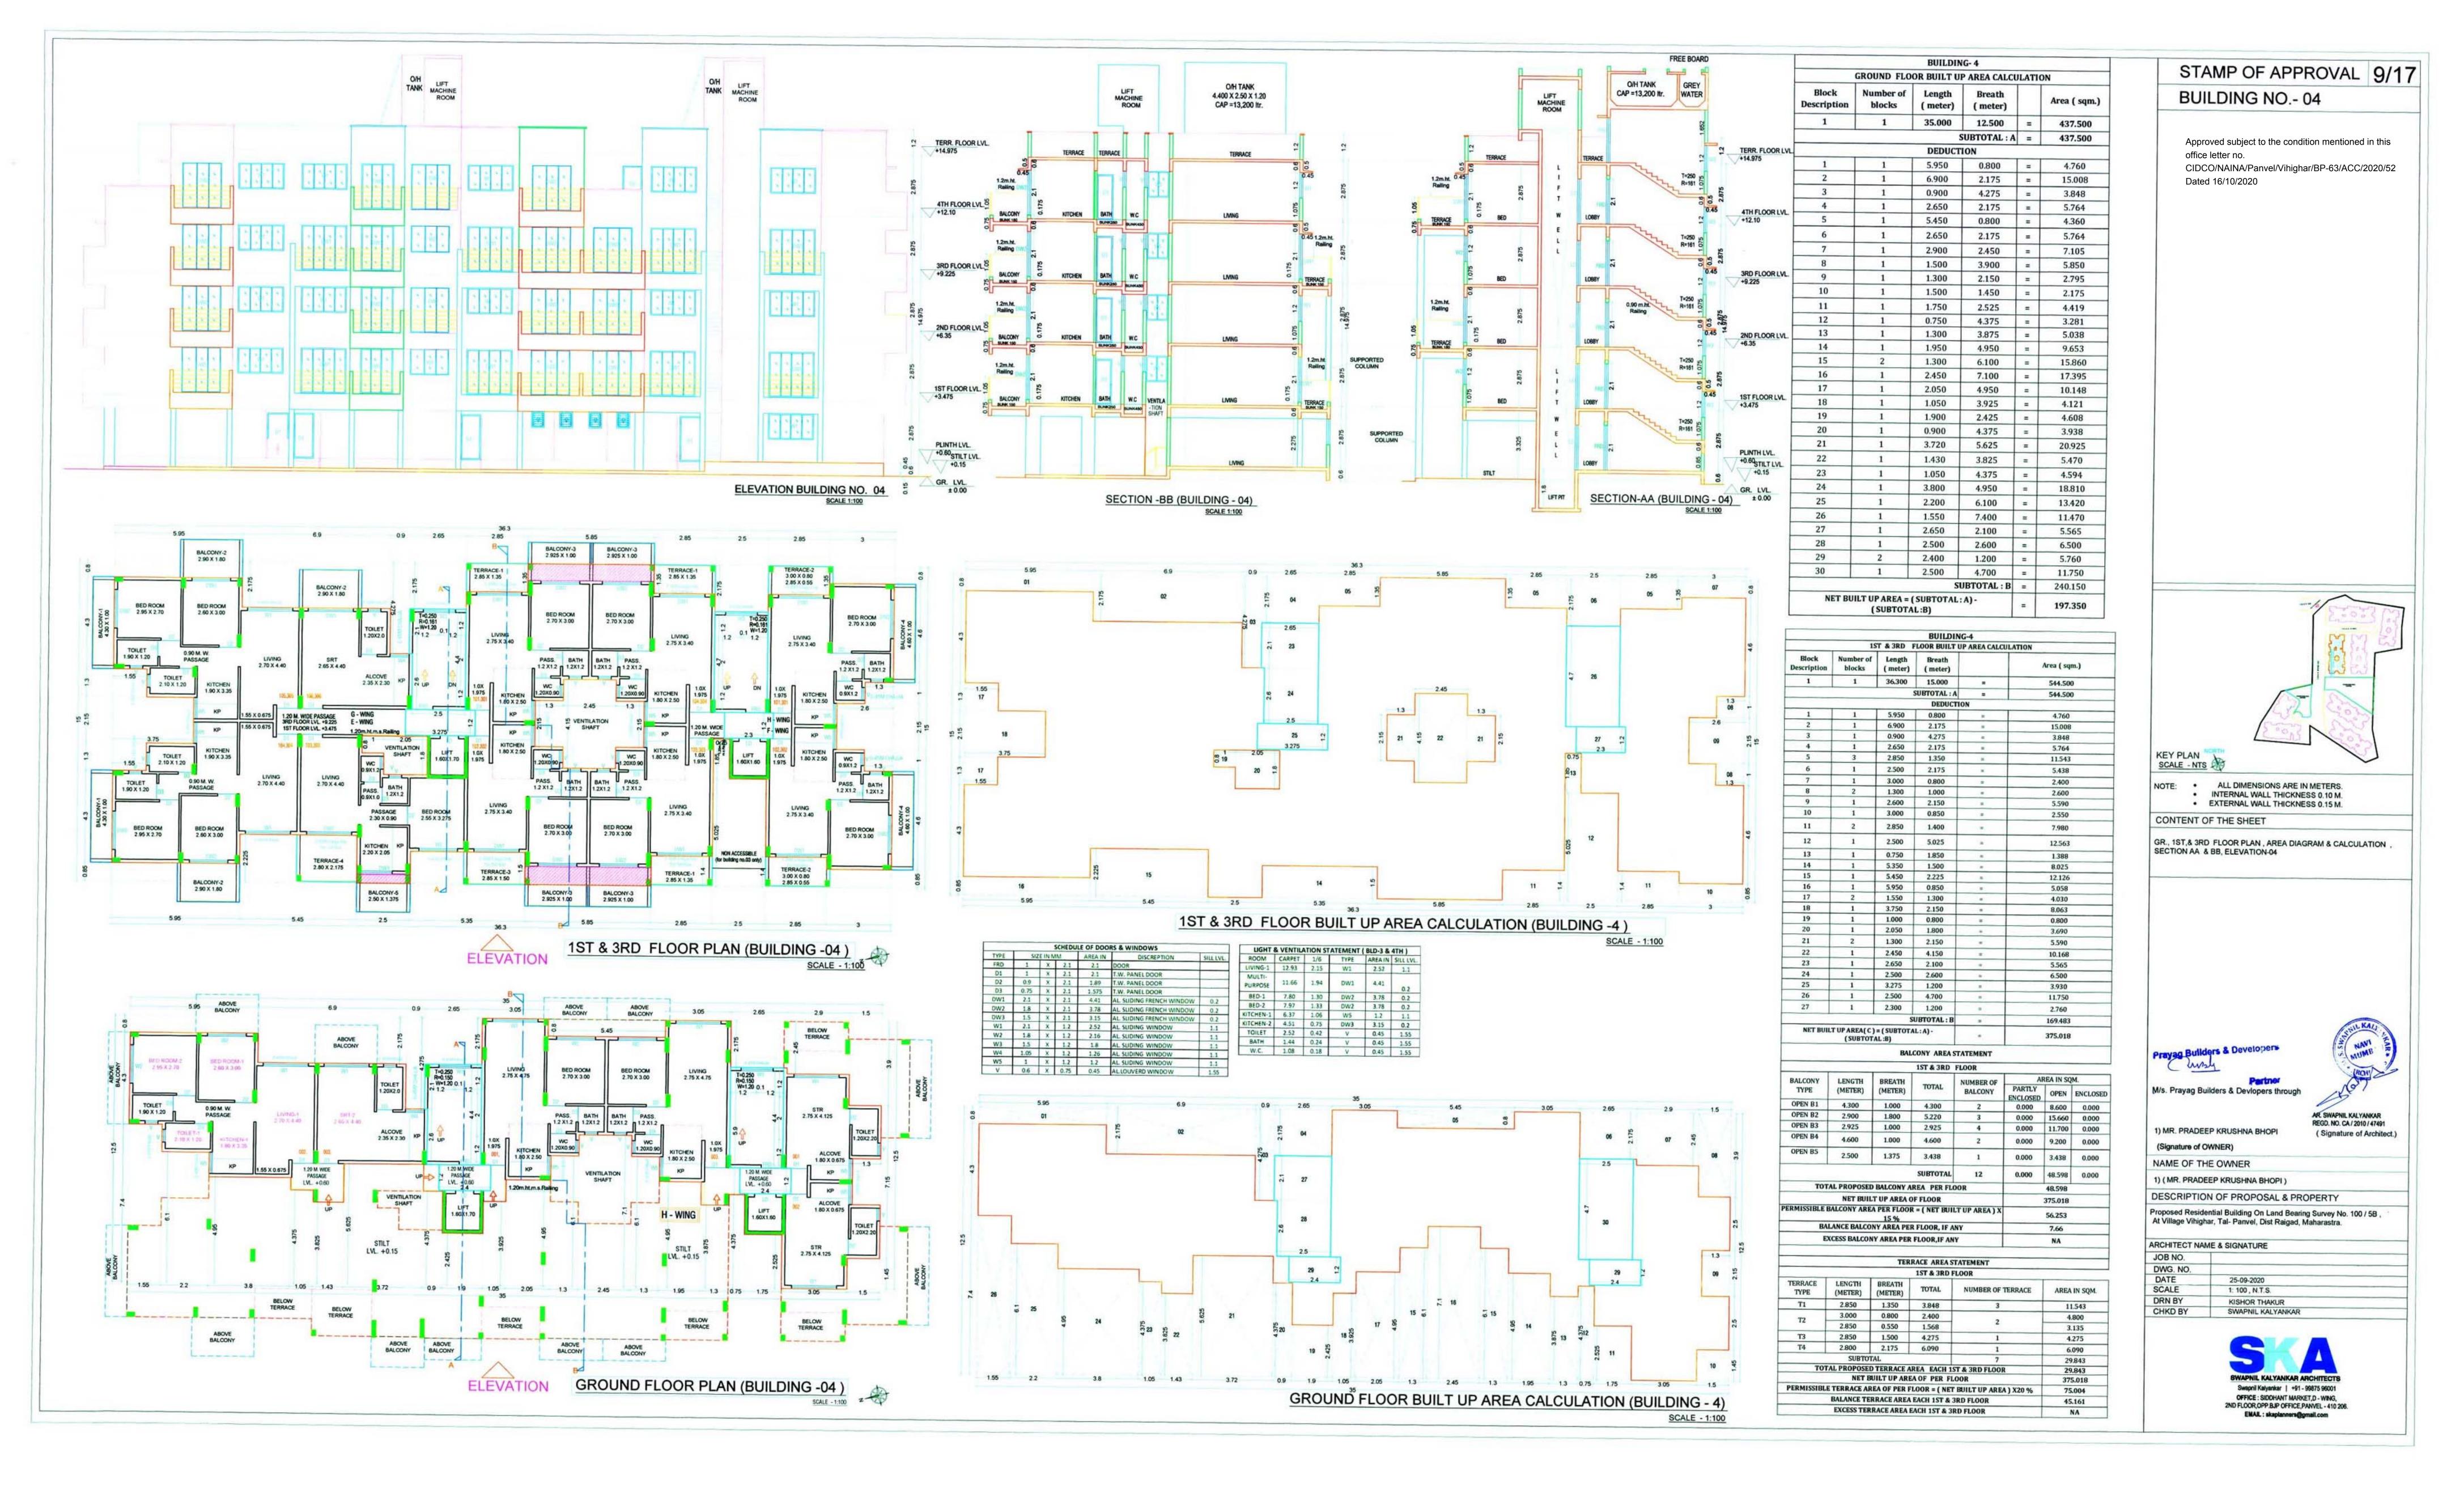

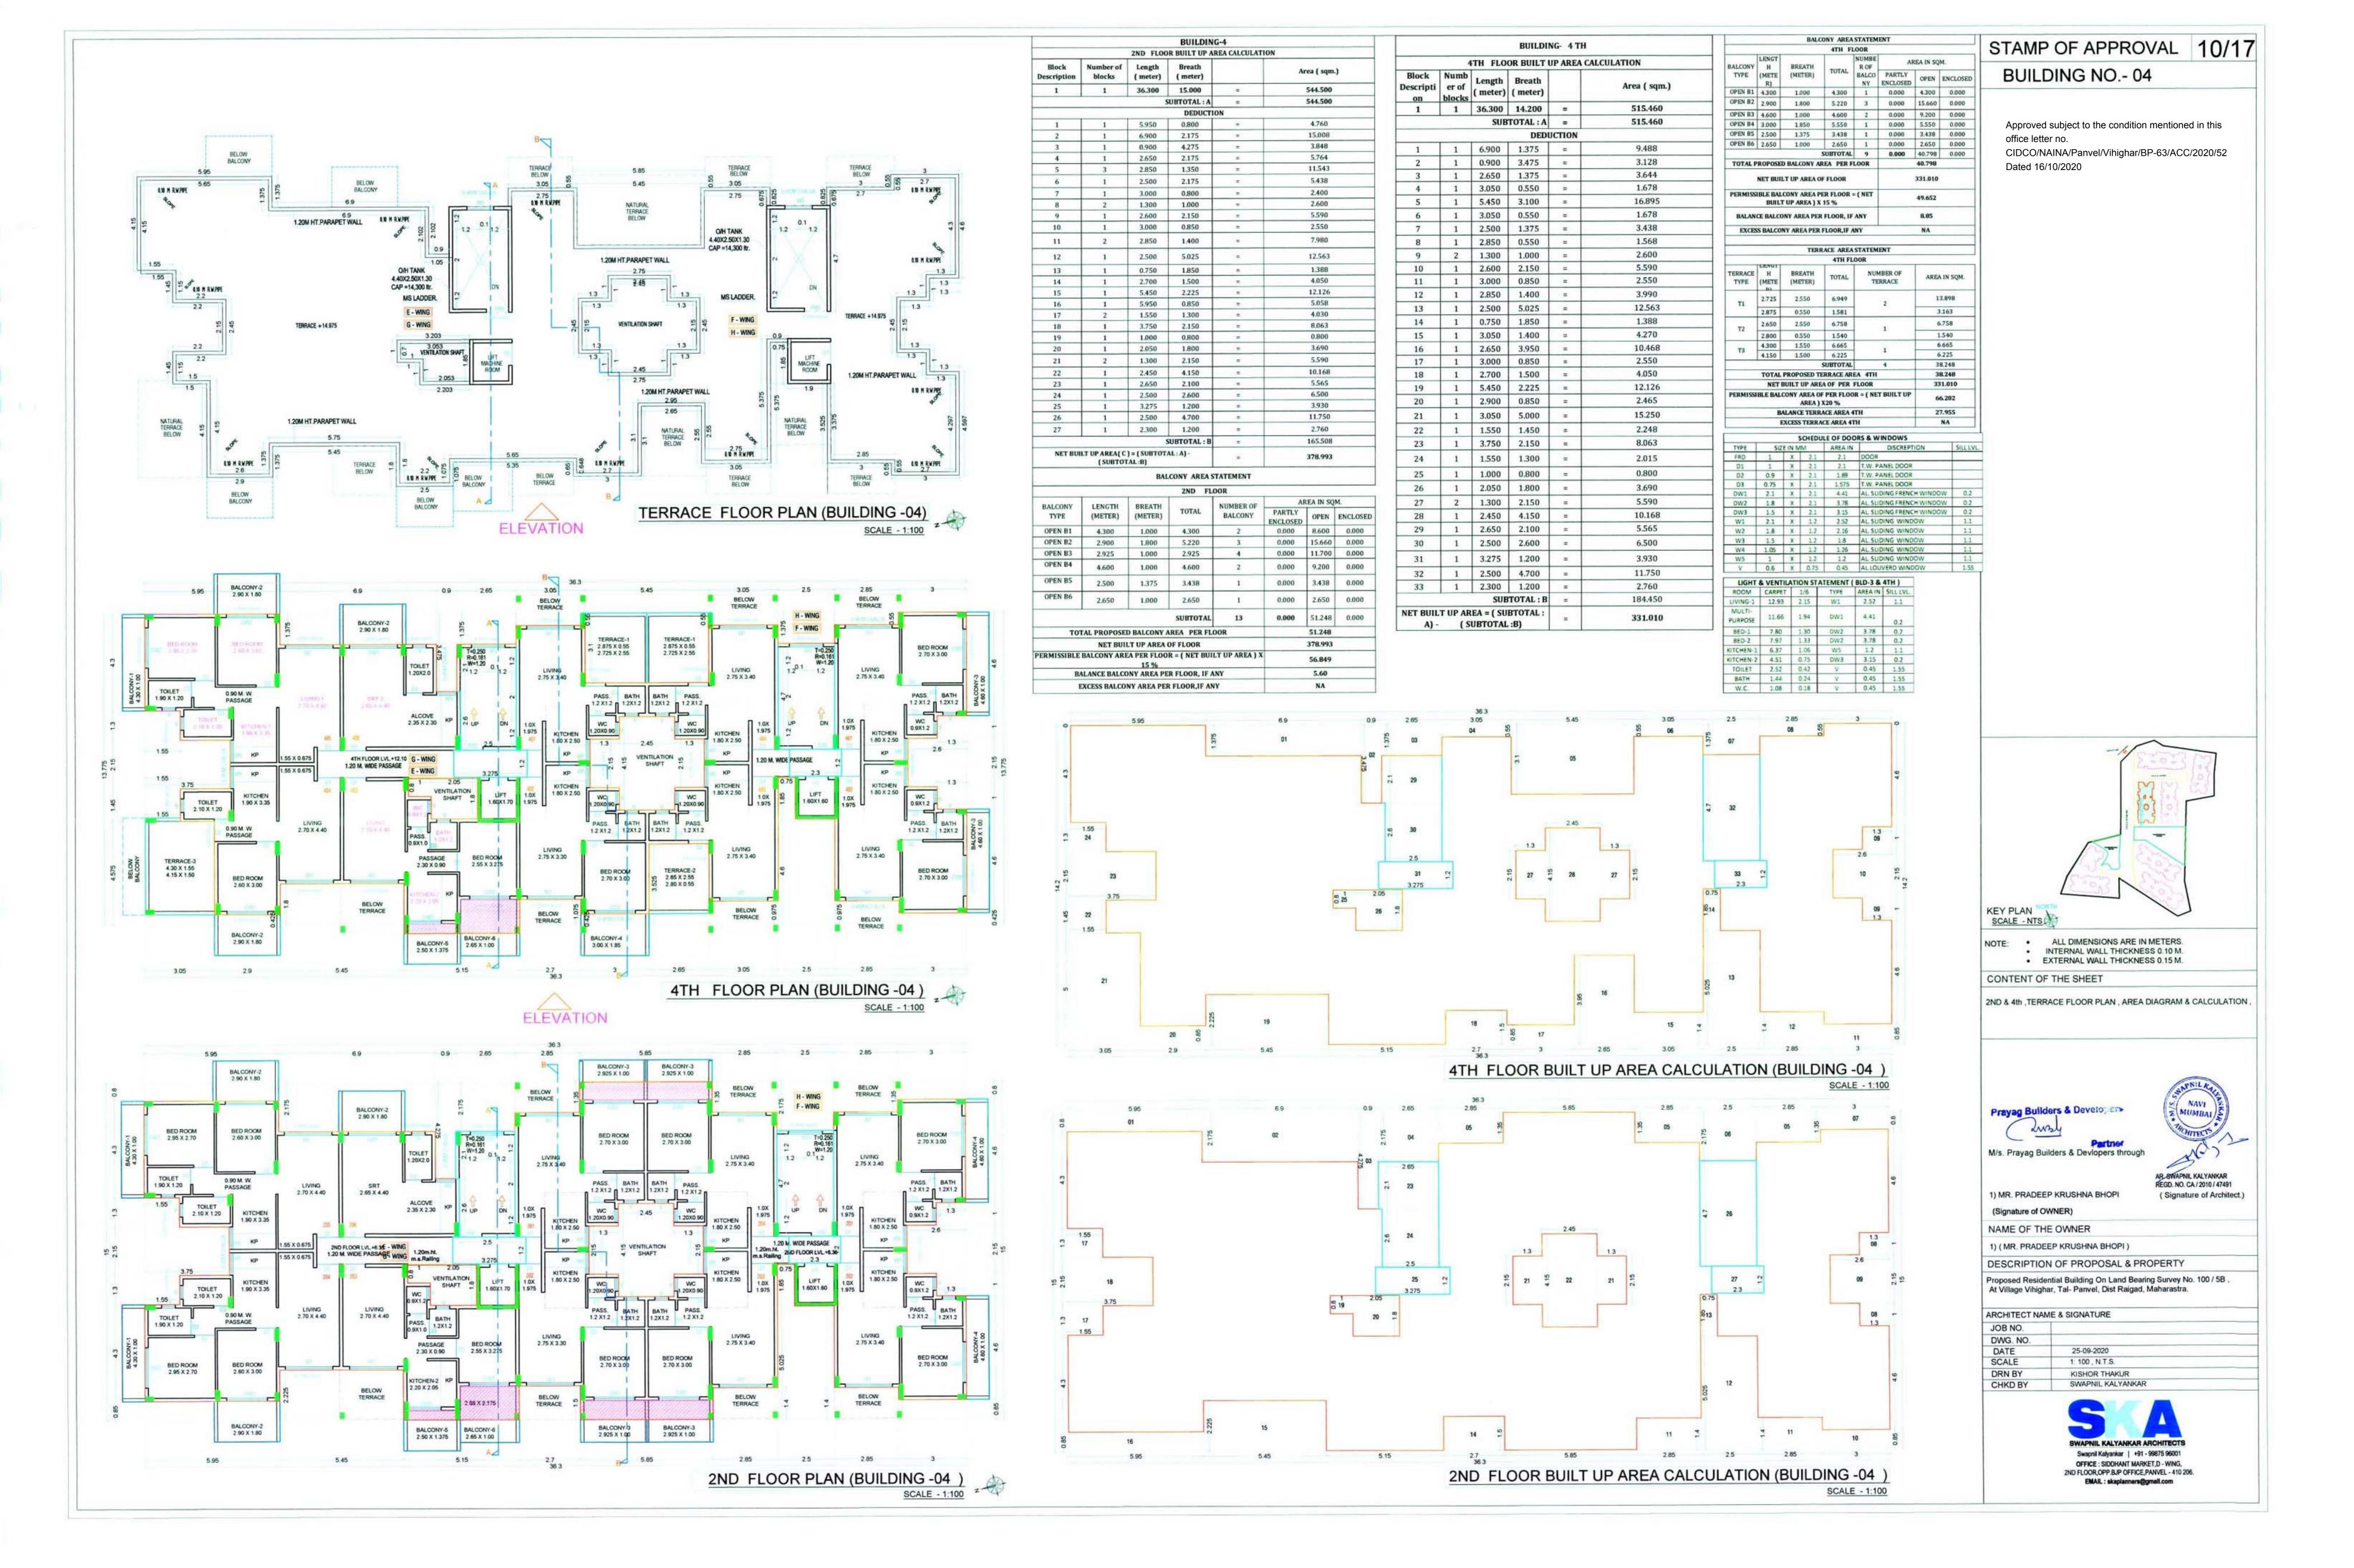

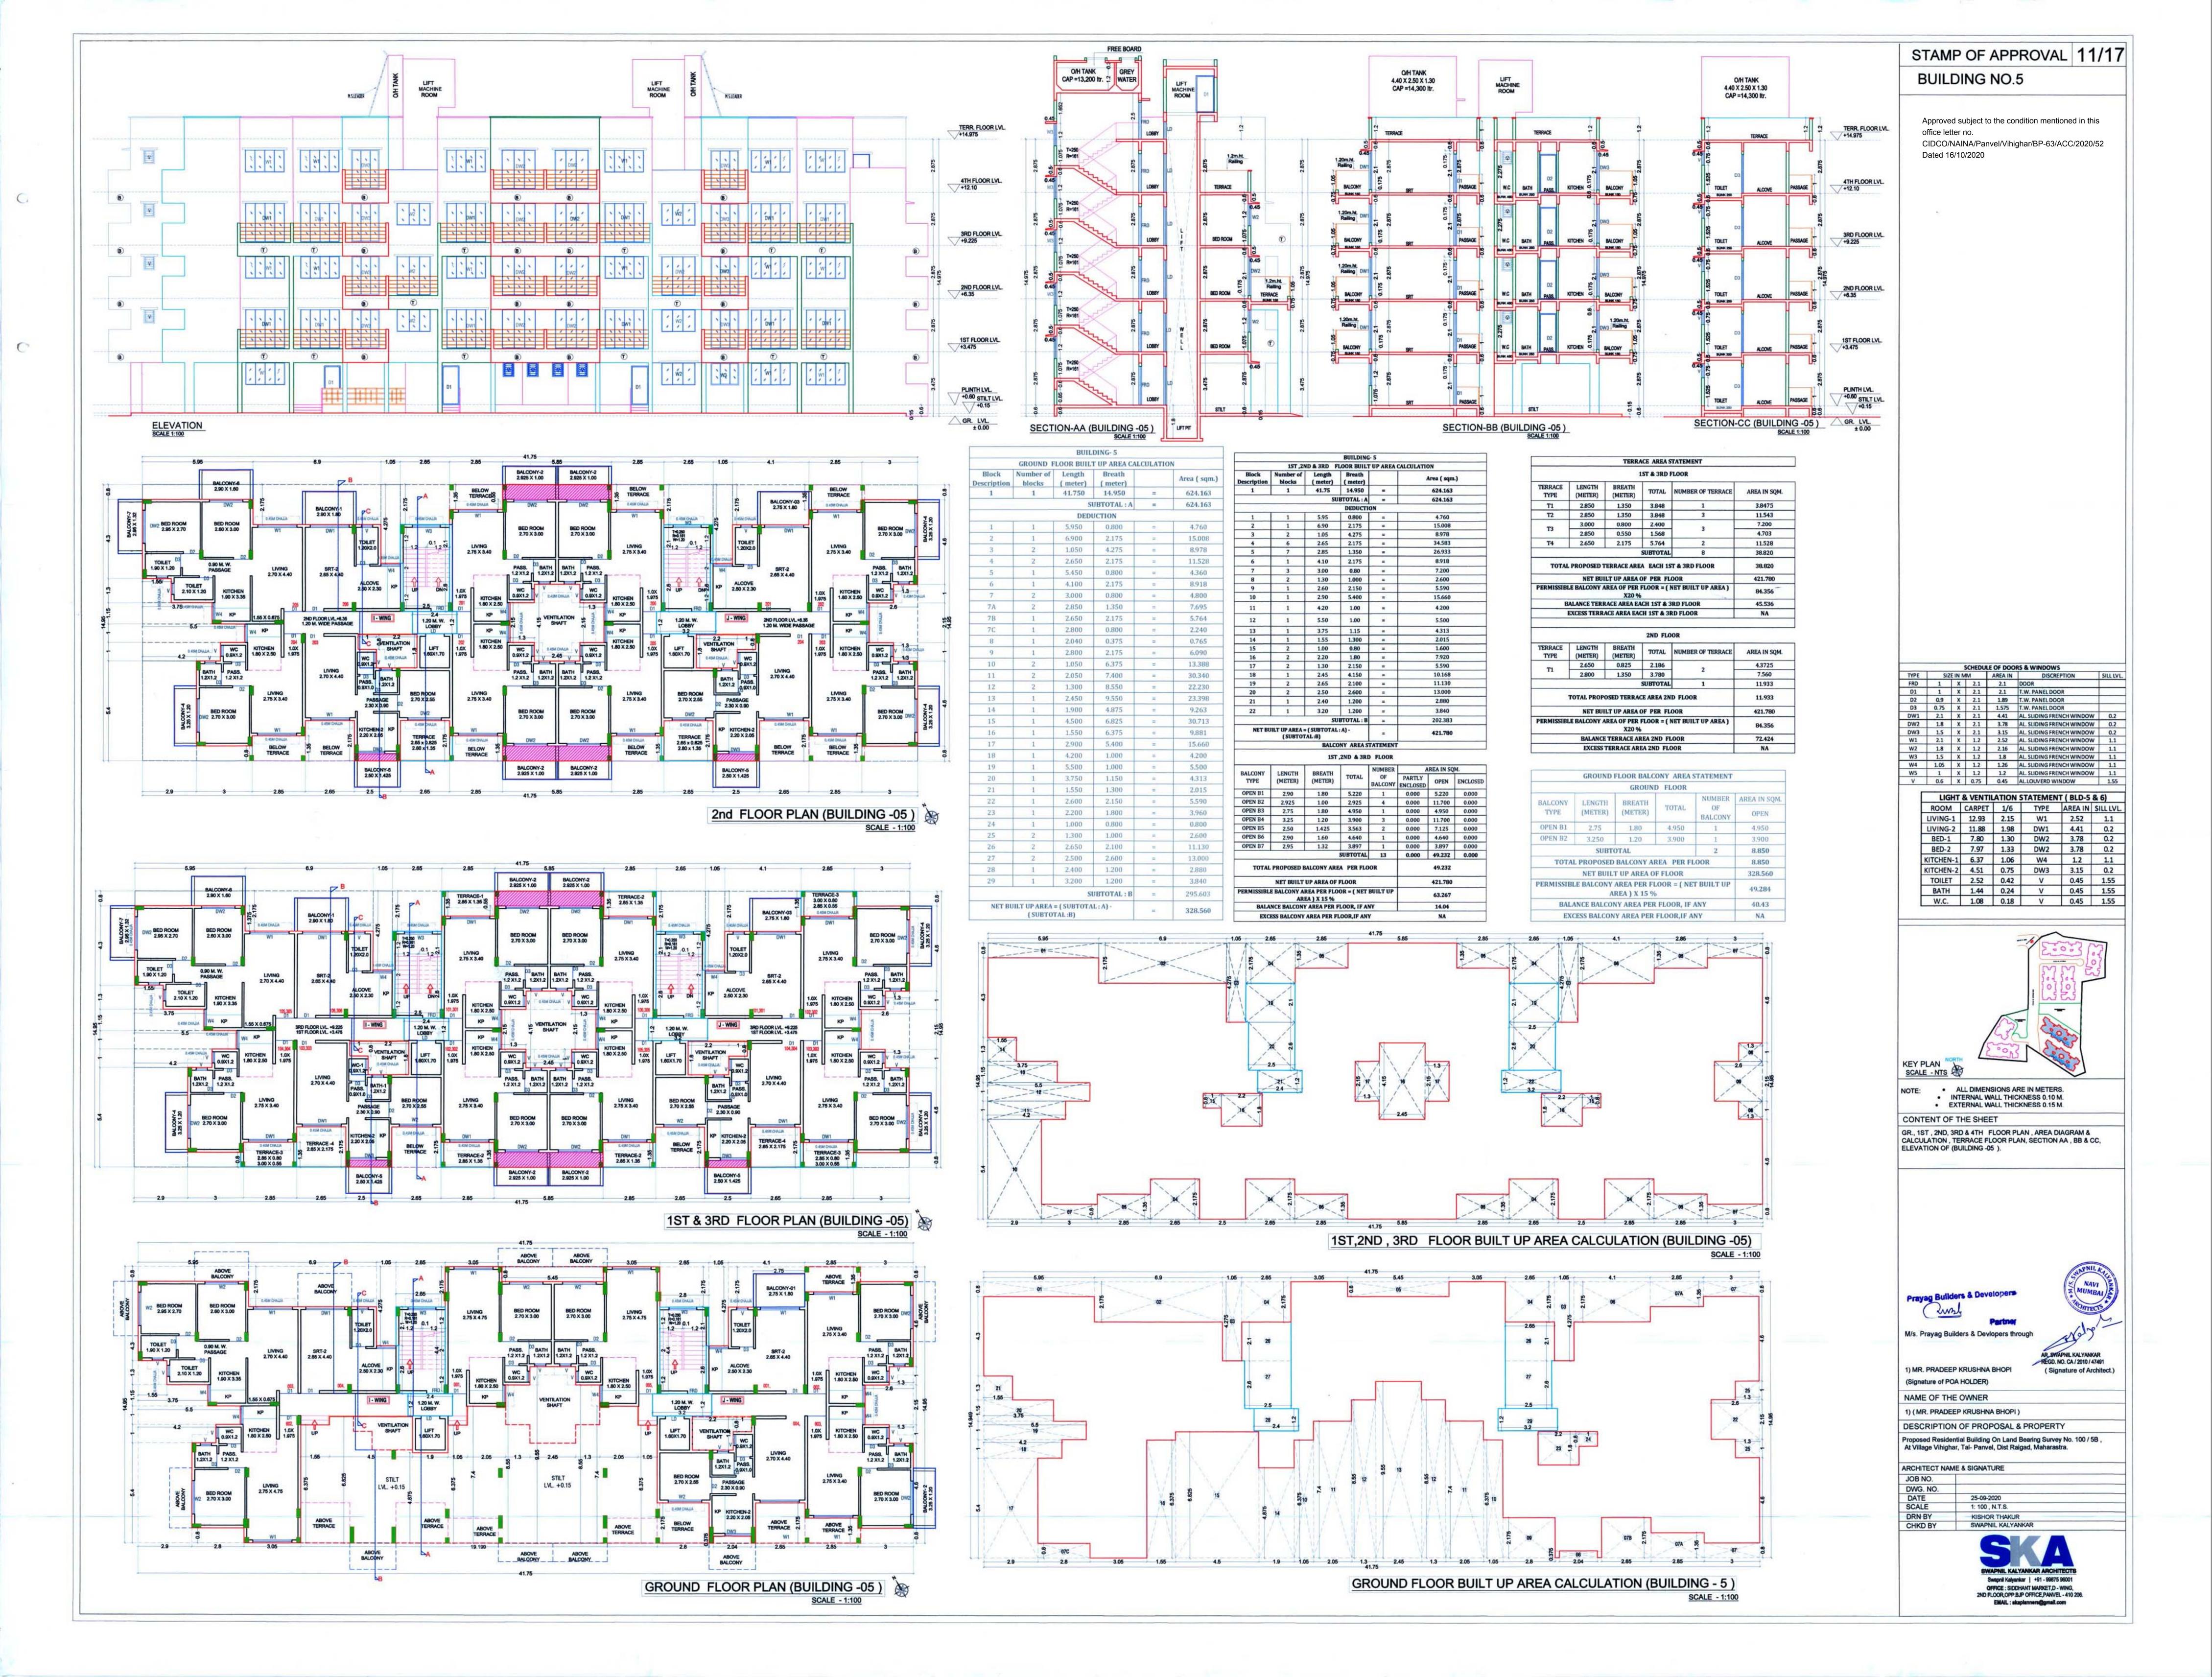

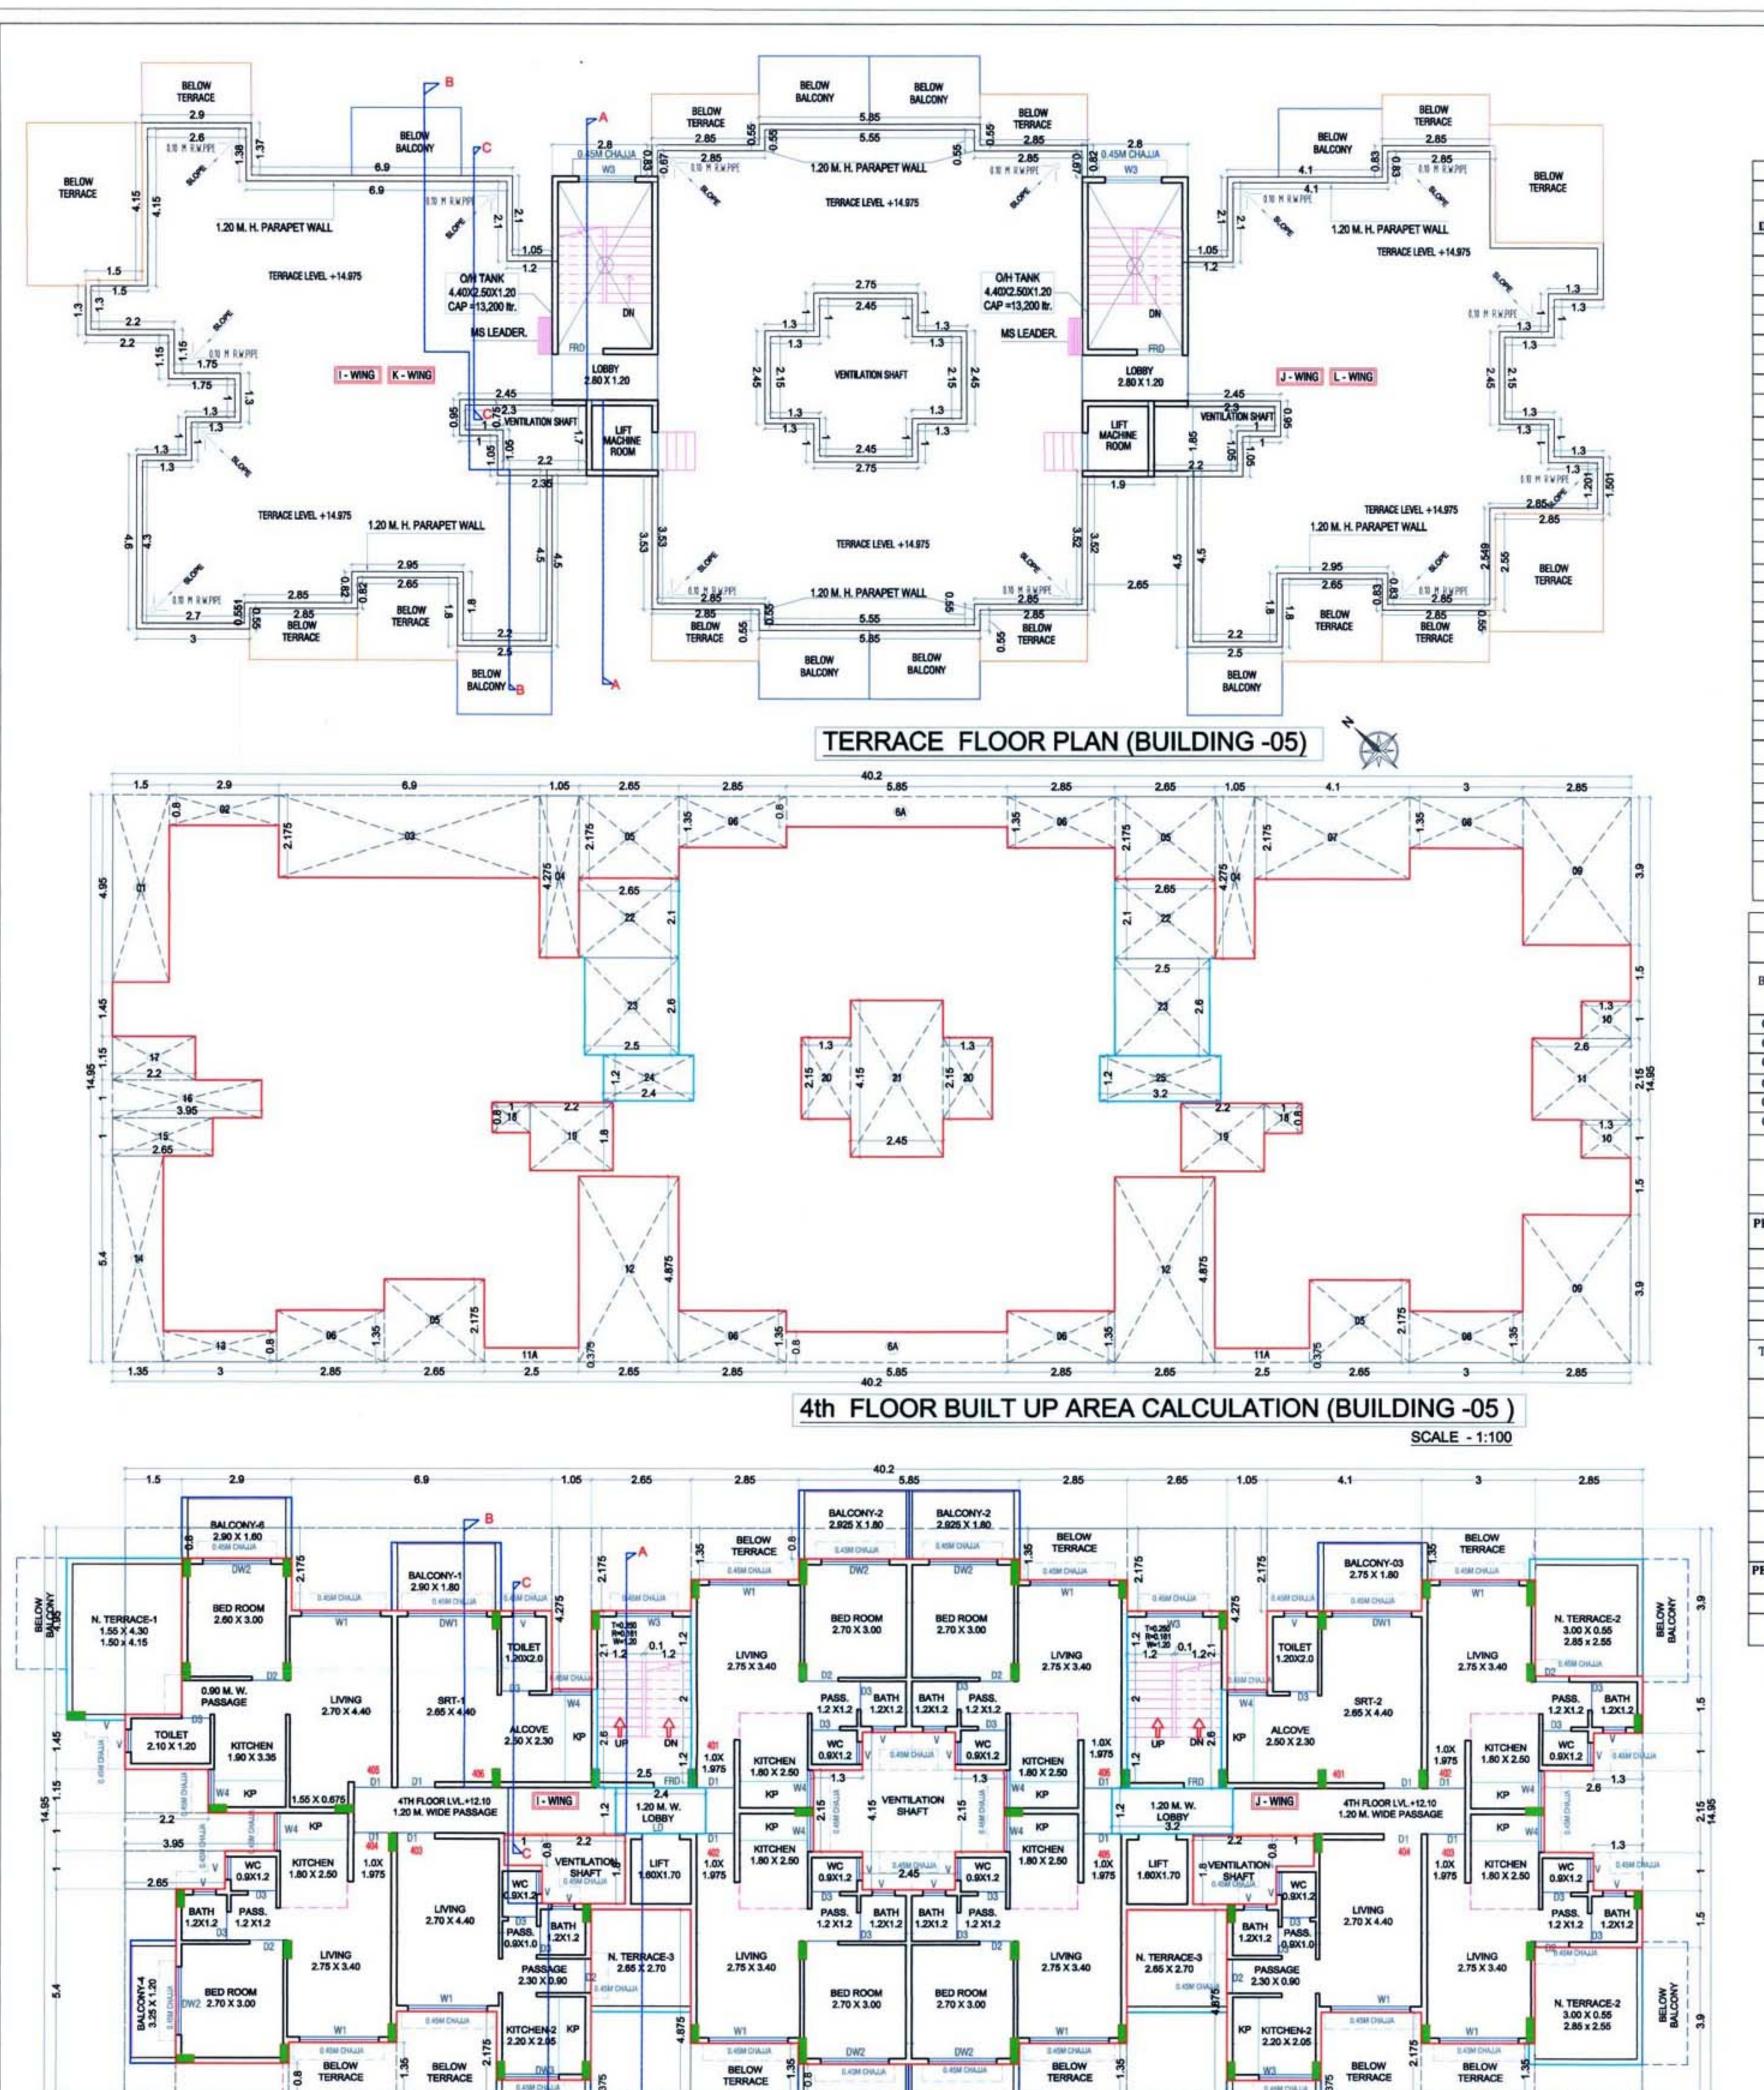

BALCONY-2 2.925 X 1.80

2.925 X 1.80

BALCONY-5 2.50 X 1.80 BALCONY-5 2.50 X 1.80

4TH FLOOR PLAN (BUILDING -05)

SCALE - 1:100

4TH FLOOR BUILT UP AREA CALCULATION Block Number of Length Breath Area (sqm.) Descriptio blocks (meter) (meter) 40.20 14.950 600.990 600.990 SUBTOTAL: A = DEDUCTION 1.50 4.950 = 7.425 15.008 2.175 8.978 2.65 2.175 23.055 9.360 5.85 0.800 8.918 4.10 2.175 22.230 2.60 2.150 1.875 0.375 25.838 2.400 7.290 2.650 2.530 17 2.20 1.150 2.20 1.800 5.590 2.45 4.150 10.168 13.000 3.20 1.200 3.840 SUBTOTAL : B 235.480 NET BUILT UP AREA = (SUBTOTAL: A) -365.510 (SUBTOTAL:B)

BUILDING-5

BALCONY AREA STATEMENT

4TH	FLO

				NUMBER		REA IN SQN	4
BALCONY TYPE	LENGTH (METER)	BREATH (METER)	TOTAL	OF BALCONY	PARTLY ENCLOSED	OPEN	ENCLOSED
OPEN B1	2.900	1.80	5.220	1	0.000	5.220	0.000
OPEN B2	2.925	1.80	5.265	4	0.000	21.060	0.000
OPEN B3	2.750	1.80	4.950	1	0.000	4.950	0.000
OPEN B4	3.250	1.20	3.900	1	0.000	3.900	0.000
OPEN B5	2.500	1.80	4.500	2	0.000	9.000	0.000
OPEN B6	2.900	1.60	4.640	1	0.000	4.640	0.000
			SUBTOTAL	10	0.000	48.770	0.000
TOTAL	PROPOSED	BALCONY A	REA PER F	LOOR		48.770	
	NET BUILT	T UP AREA O	F FLOOR		-	365.510	
PERMISSIB	LE BALCONY UP	AREA PER AREA) X 15		NET BUILT		54.827	
BALANCE BALCONY AREA PER FLOOR, IF ANY						6.06	
EXC	ESS BALCON	Y AREA PER		NA			

TERRACE AREA STATEMENT 4TH FLOOR


			4111	FLOOK		
TERRACE TYPE	LENGTH (METER)	BREATH (METER)	TOTAL	NUMBER OF TERRACE	AREA IN SQM.	
T1	4.300	1.550	6.665	2 2	6.665	
11	4.150	1.500	6.225	1	6.225	
T2	2.850	2.550	7.268	2	14.535	
1,4	3.000	0.550	1.650		3.300	
T3	2.65	2.70	7.155	2	14.310	
			SUBTOTAL	5	45.035	
7	OTAL PROP	OSED TERR	ACE AREA	4TH FLOOR	45.035	
	NET BU	ILT UP ARE	A OF PER	FLOOR	365.510	
PERMISSIB	73.102					
	BALANCE TERRACE AREA 4TH FLOOR					
	EXCES	S TERRACE A	AREA 4TH I	FLOOR	NA	

STAMP OF APPROVAL 12/17

BUILDING NO.5

Approved subject to the condition mentioned in this office letter no.

CIDCO/NAINA/Panvel/Vihighar/BP-63/ACC/2020/52 Dated 16/10/2020

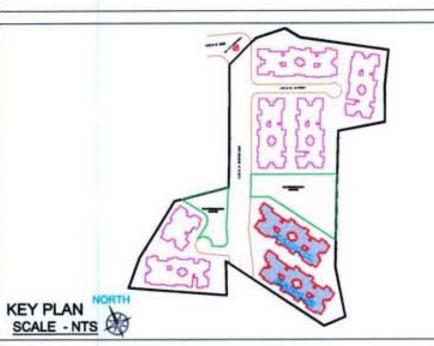

ALL DIMENSIONS ARE IN METERS.
 INTERNAL WALL THICKNESS 0.10 M.
 EXTERNAL WALL THICKNESS 0.15 M.

CONTENT OF THE SHEET

GR., 1ST, 2ND, 3RD & 4TH FLOOR PLAN, AREA DIAGRAM & CALCULATION, TERRACE FLOOR PLAN, SECTION AA, BB & CC, ELEVATION OF (BUILDING -05).

Prayag Builders & Developen



M/s. Prayag Builders & Devlopers through



(Signature of Architect.)

1) MR. PRADEEP KRUSHNA BHOPI (Signature of POA HOLDER)

NAME OF THE OWNER

1) (MR. PRADEEP KRUSHNA BHOPI)

DESCRIPTION OF PROPOSAL & PROPERTY

Proposed Residential Building On Land Bearing Survey No. 100 / 5B , At Village Vihighar, Tal- Panvel, Dist Raigad, Maharastra.

ARCHITECT NAME & SIGNATURE

JOB NO. DWG. NO. DATE

CHKD BY

DATE 25-09-2020

SCALE 1: 100 , N.T.S.

DRN BY KISHOR THAKUR

SWAPNIL KALYANKAR ARCHITECTS


Swapnil Kalyankar | +91 - 99875 96001


OFFICE: SIDDHANT MARKET,D - WING,


2ND FLOOR,OPP.BJP OFFICE,PANVEL - 410 206,

EMAIL: skaplanners@gmail.com

SWAPNIL KALYANKAR

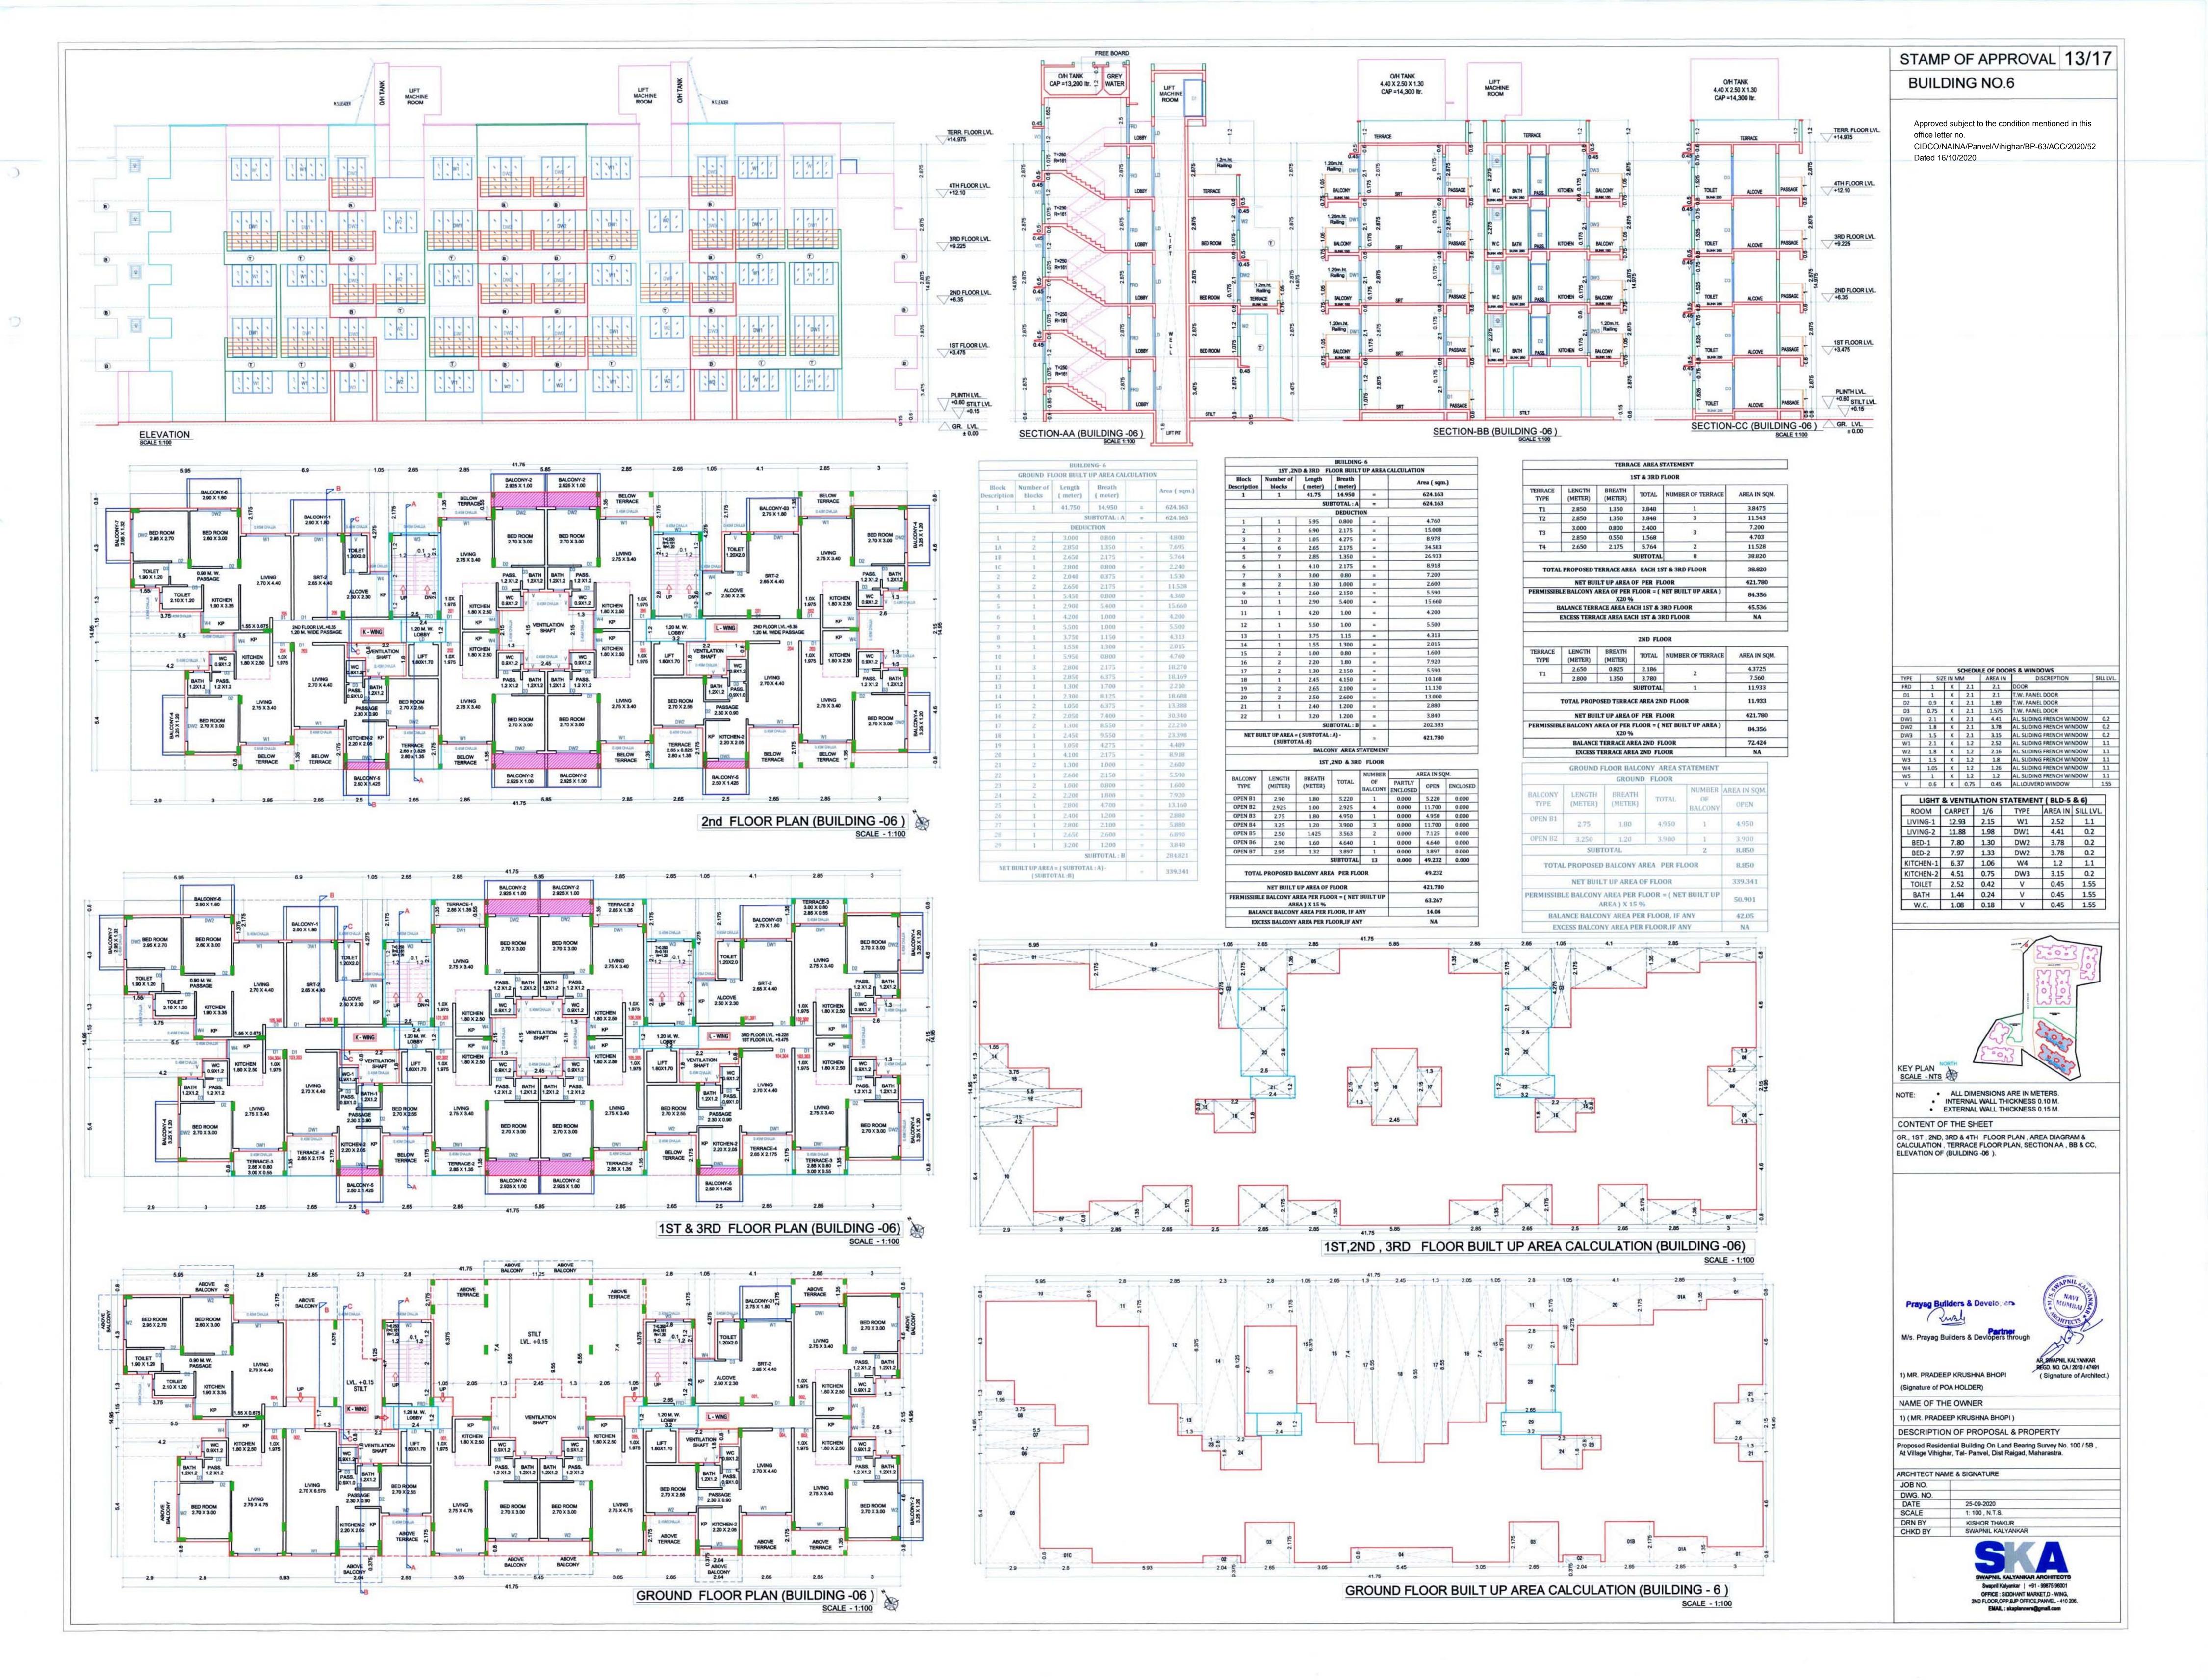

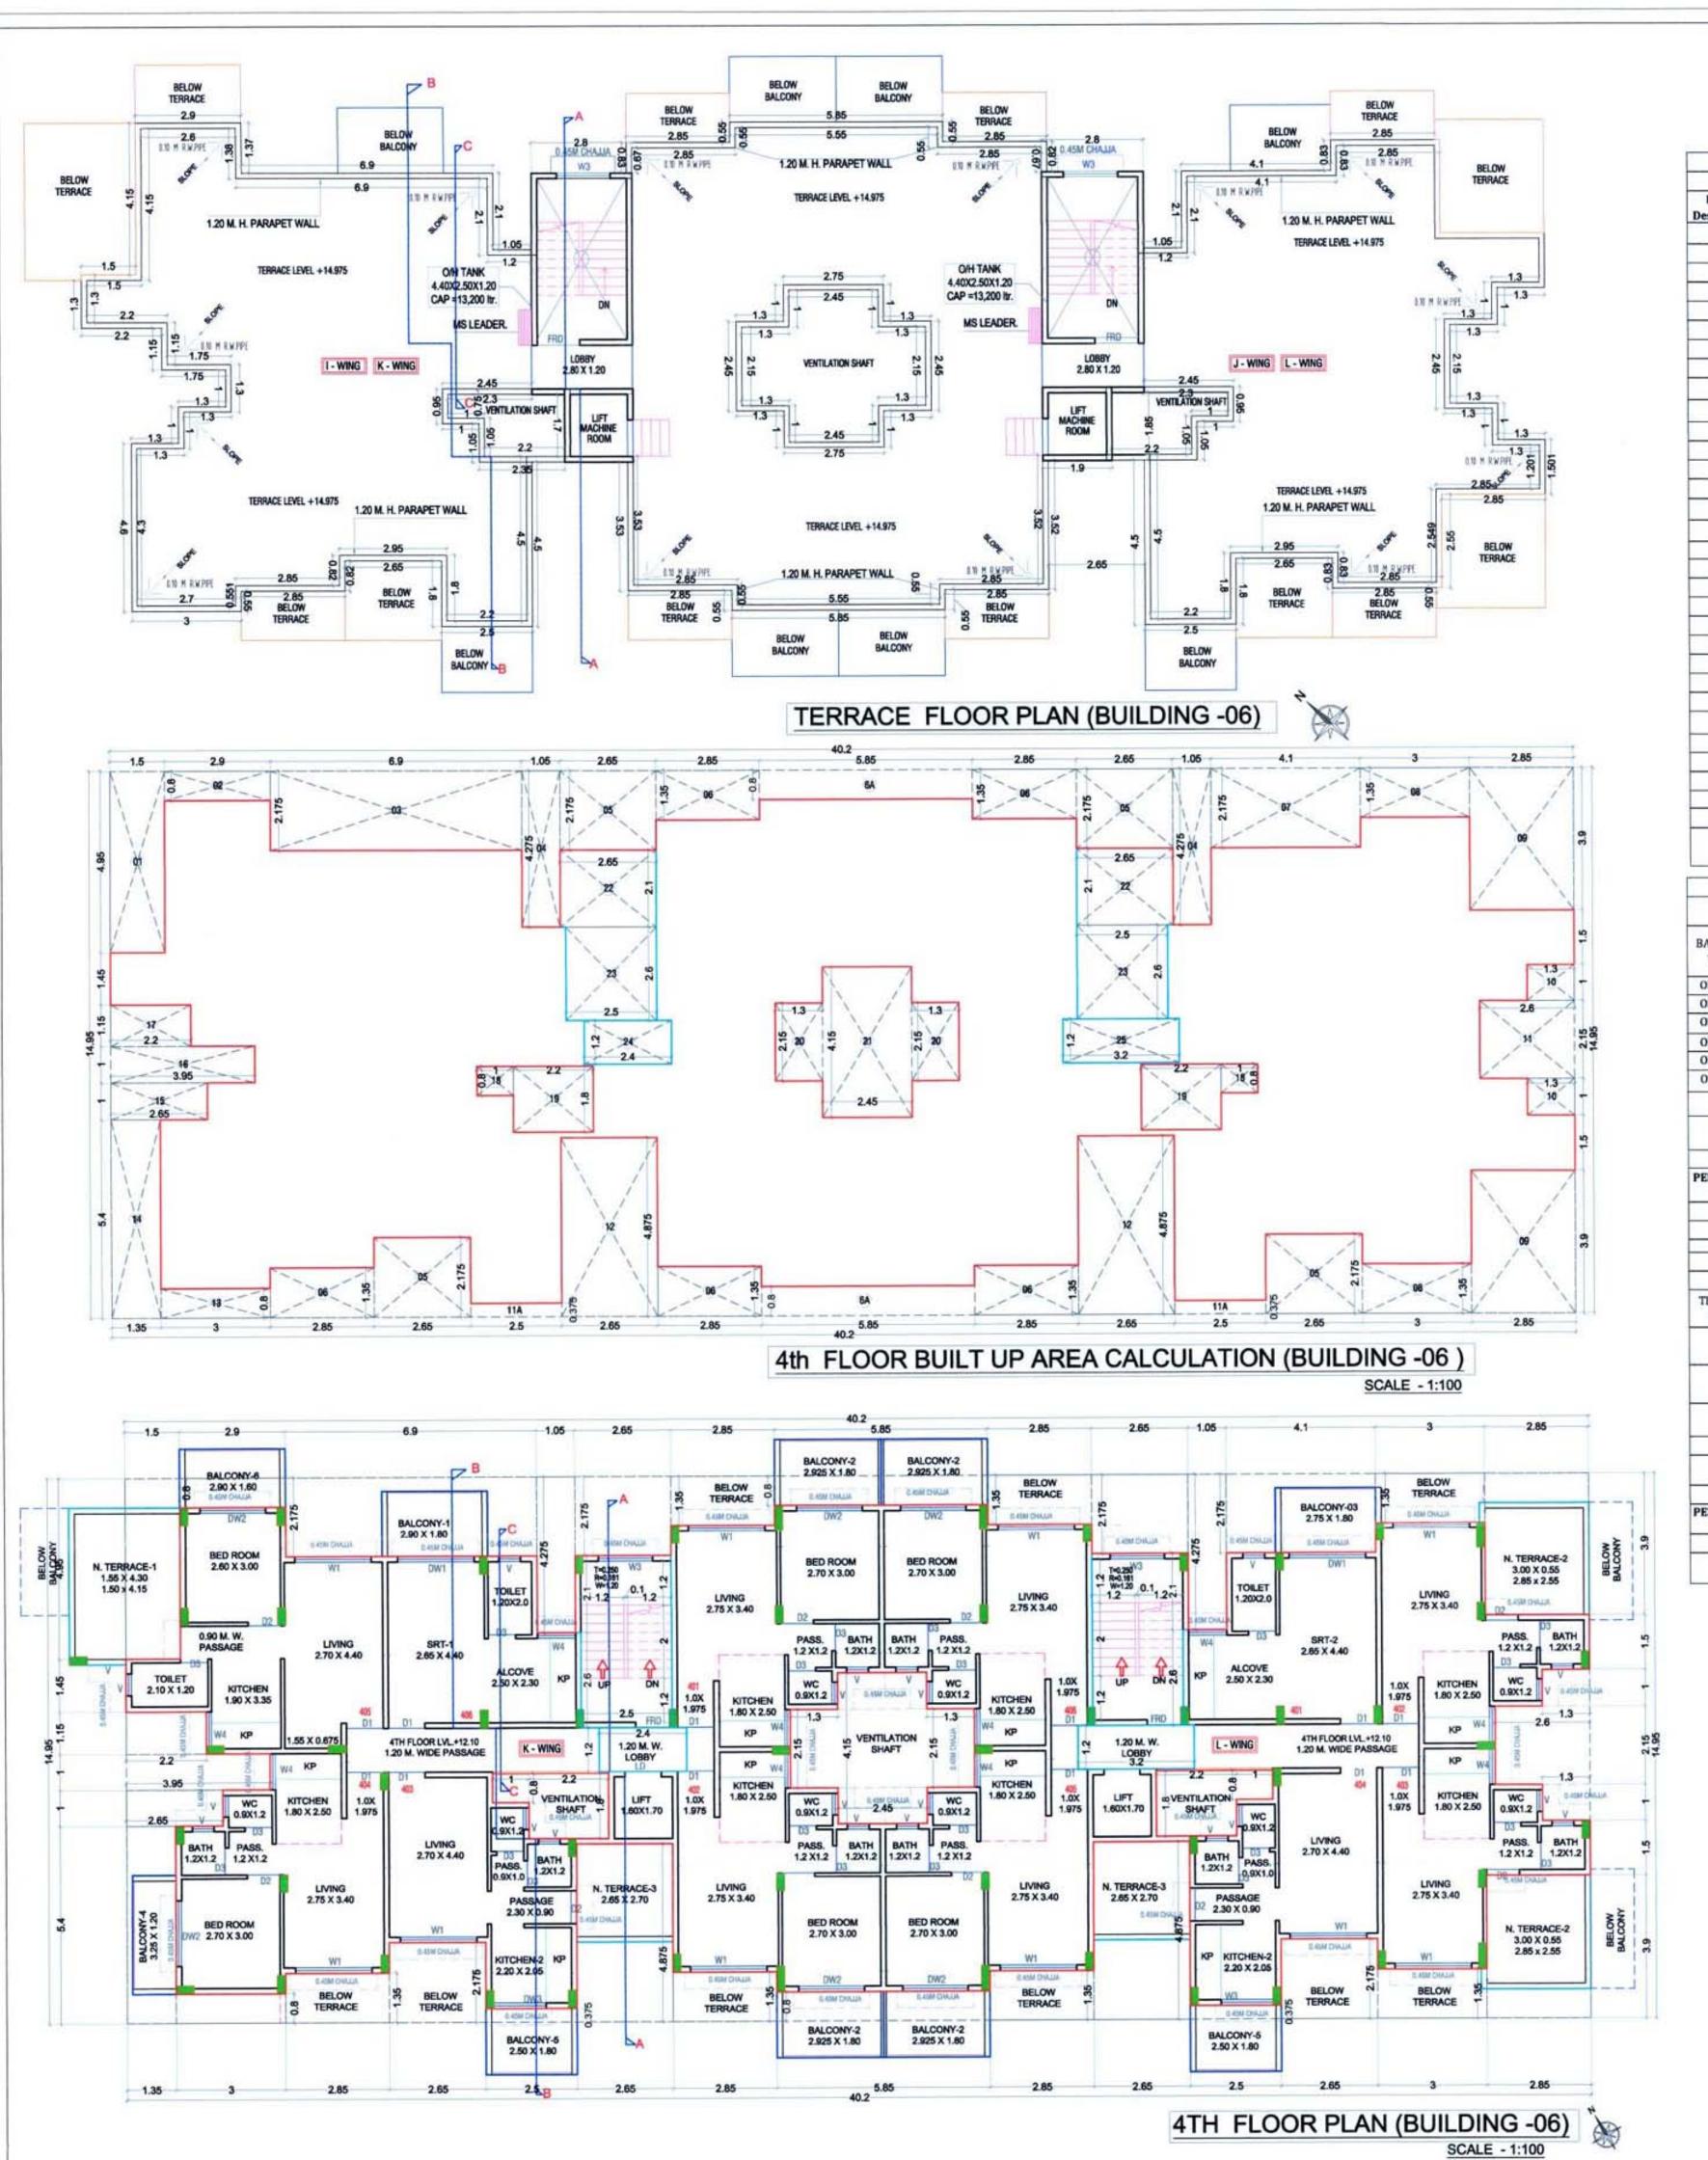

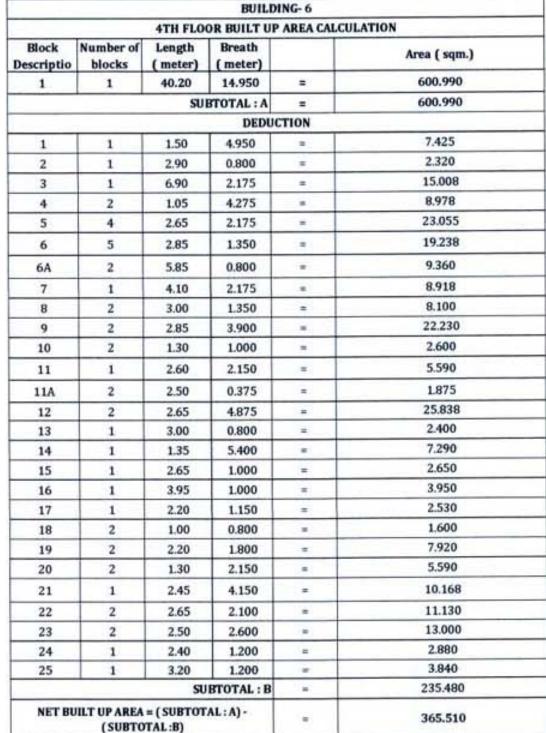

			4TH	FLOOR				
CONV	ONLY LENGTH PREATH			NUMBER	AREA IN SQM.			
CONY	(METER)	(METER)	TOTAL	OF BALCONY	PARTLY ENCLOSED	OPEN		
EN B1	2.900	1.80	5.220	1	0.000	5.220	I	
EN B2	2.925	1.80	5.265	4	0.000	21.060	I	
EN B3	2.750	1.80	4.950	1	0.000	4.950	I	

BALCONY AREA STATEMENT

 OPEN B1
 2.900
 1.80
 5.220
 1
 0.000
 5.220
 0.000

 OPEN B2
 2.925
 1.80
 5.265
 4
 0.000
 21.060
 0.000

 OPEN B3
 2.750
 1.80
 4.950
 1
 0.000
 4.950
 0.000

 OPEN B4
 3.250
 1.20
 3.900
 1
 0.000
 3.900
 0.000

 OPEN B5
 2.500
 1.80
 4.500
 2
 0.000
 9.000
 0.000

 OPEN B6
 2.900
 1.60
 4.640
 1
 0.000
 4.640
 0.000

 SUBTOTAL
 10
 0.000
 48.770
 0.000

 TOTAL PROPOSED BALCONY AREA PER FLOOR
 48.770
 48.770

 NET BUILT UP AREA OF FLOOR
 365.510

 PERMISSIBLE BALCONY AREA PER FLOOR = (NET BUILT)

6.06

NA

TERRACE AREA STATEMENT

UP AREA) X 15 %
BALANCE BALCONY AREA PER FLOOR, IF ANY

EXCESS BALCONY AREA PER FLOOR, IF ANY


			4TH	FLOOR	
TERRACE TYPE	LENGTH (METER)	BREATH (METER)	TOTAL	NUMBER OF TERRACE	AREA IN SQM.
	4.300	1.550	6.665		6.665
TI	4.150	1.500	6.225	1	6.225
mo.	2.850	2.550	7.268		14.535
T2	3.000	0.550	1.650	4	3.300
Т3	2.65	2.70	7.155	2	14.310
			SUBTOTAL	5	45.035
7	TOTAL PROF	OSED TERR	ACE AREA	4TH FLOOR	45.035
	NET BU	JILT UP ARE	A OF PER	FLOOR	365.510
ERMISSIB	LE TERRACI	AREA OF P		= (NET BUILT UP AREA	73.102
	BALANG	E TERRACE	AREA 4TH	FLOOR	28.067
	EXCES	S TERRACE	AREA 4TH	FLOOR	NA

STAMP OF APPROVAL 14/17

BUILDING NO.6

Approved subject to the condition mentioned in this office letter no.

CIDCO/NAINA/Panvel/Vihighar/BP-63/ACC/2020/52 Dated 16/10/2020

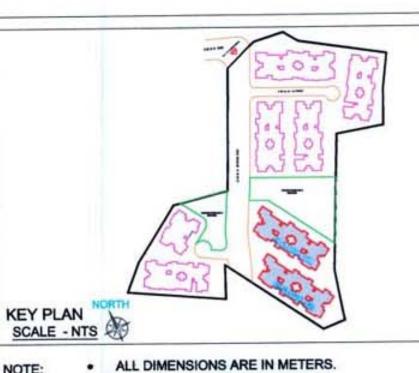

EXTERNAL WALL THICKNESS 0.15 M.

CONTENT OF THE SHEET

GR., 1ST, 2ND, 3RD & 4TH FLOOR PLAN, AREA DIAGRAM & CALCULATION, TERRACE FLOOR PLAN, SECTION AA, BB & CC, ELEVATION OF (BUILDING -05).

NAVI

INTERNAL WALL THICKNESS 0.10 M.



M/s. Prayag Builders & Devlopers through

AR SWAPNIL KALYANKAR
REGD. NO. CA / 2010 / 47491

1) MR. PRADEEP KRUSHNA BHOPI (Signature of Architect.)

NAME OF THE OWNER

SCALE

CHKD BY

(Signature of POA HOLDER)

1) (MR. PRADEEP KRUSHNA BHOPI)

DESCRIPTION OF PROPOSAL & PROPERTY

Proposed Residential Building On Land Bearing Survey No. 100 / 5B , At Village Vihighar, Tal- Panvel, Dist Raigad, Maharastra.

ARCHITECT NAME & SIGNATURE

JOB NO.

DWG. NO.


DATE 25-09-2020


1: 100 , N.T.S.


KISHOR THAKUR

SWAPNIL KALYANKAR



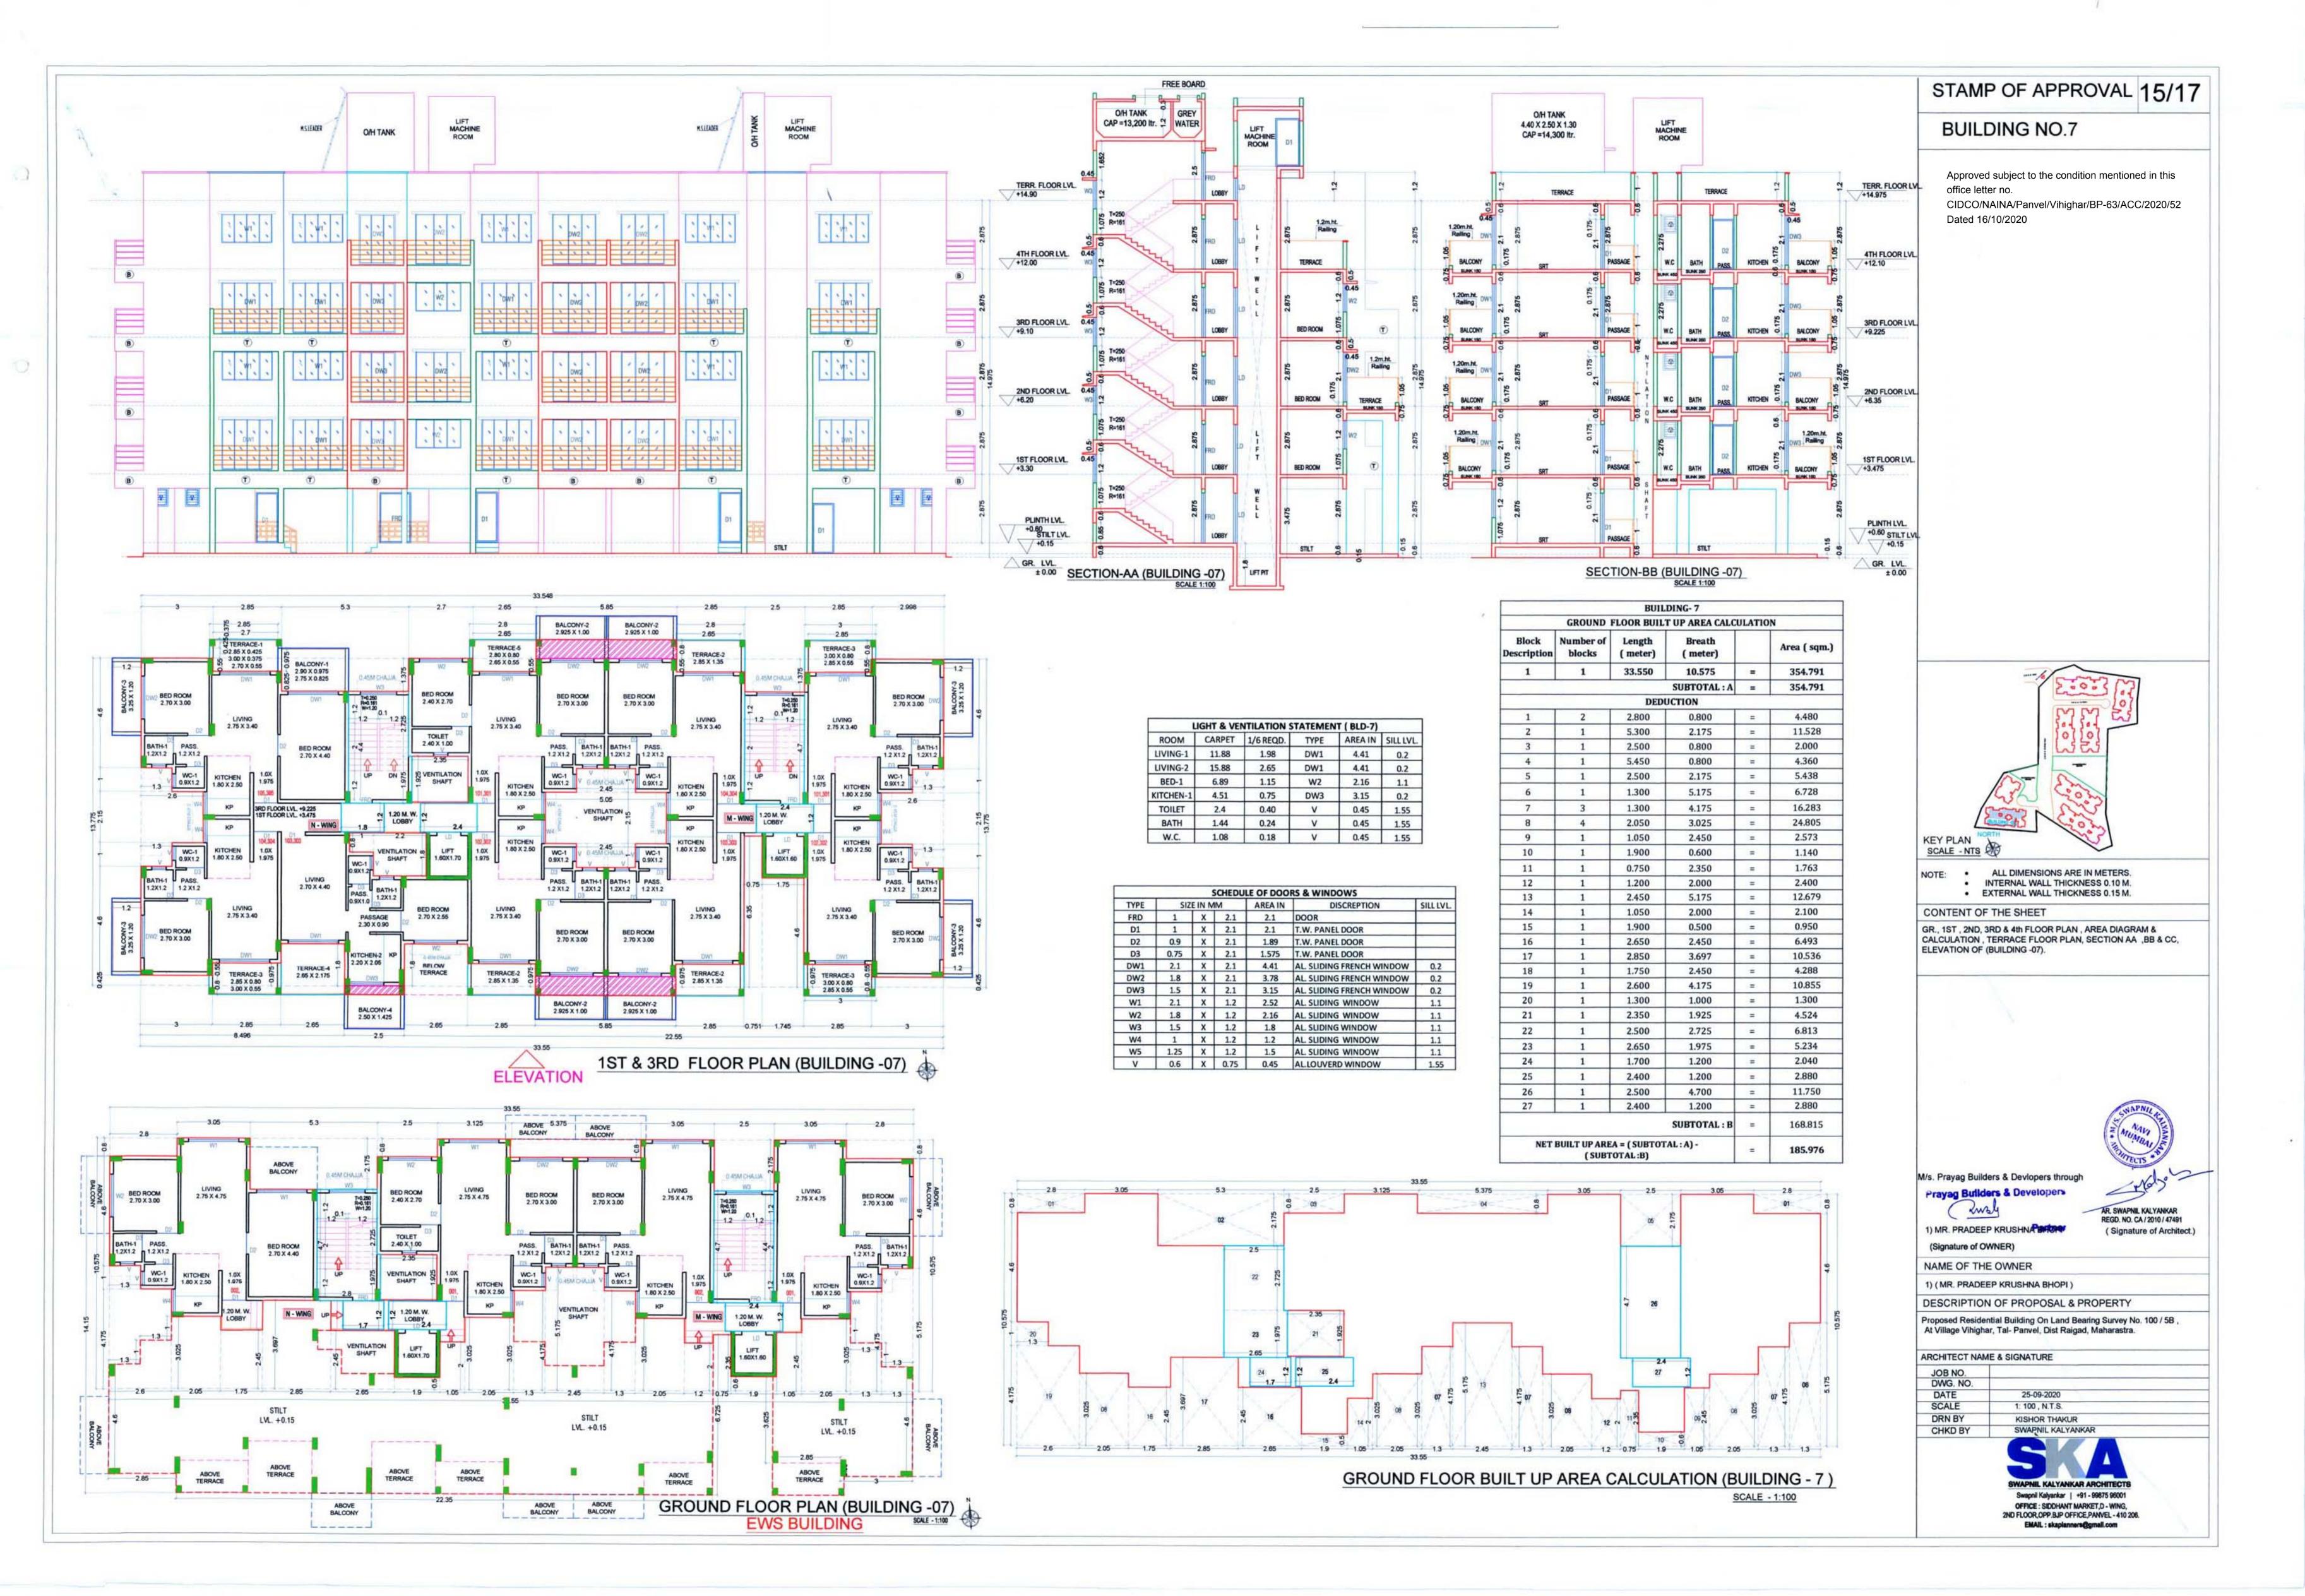

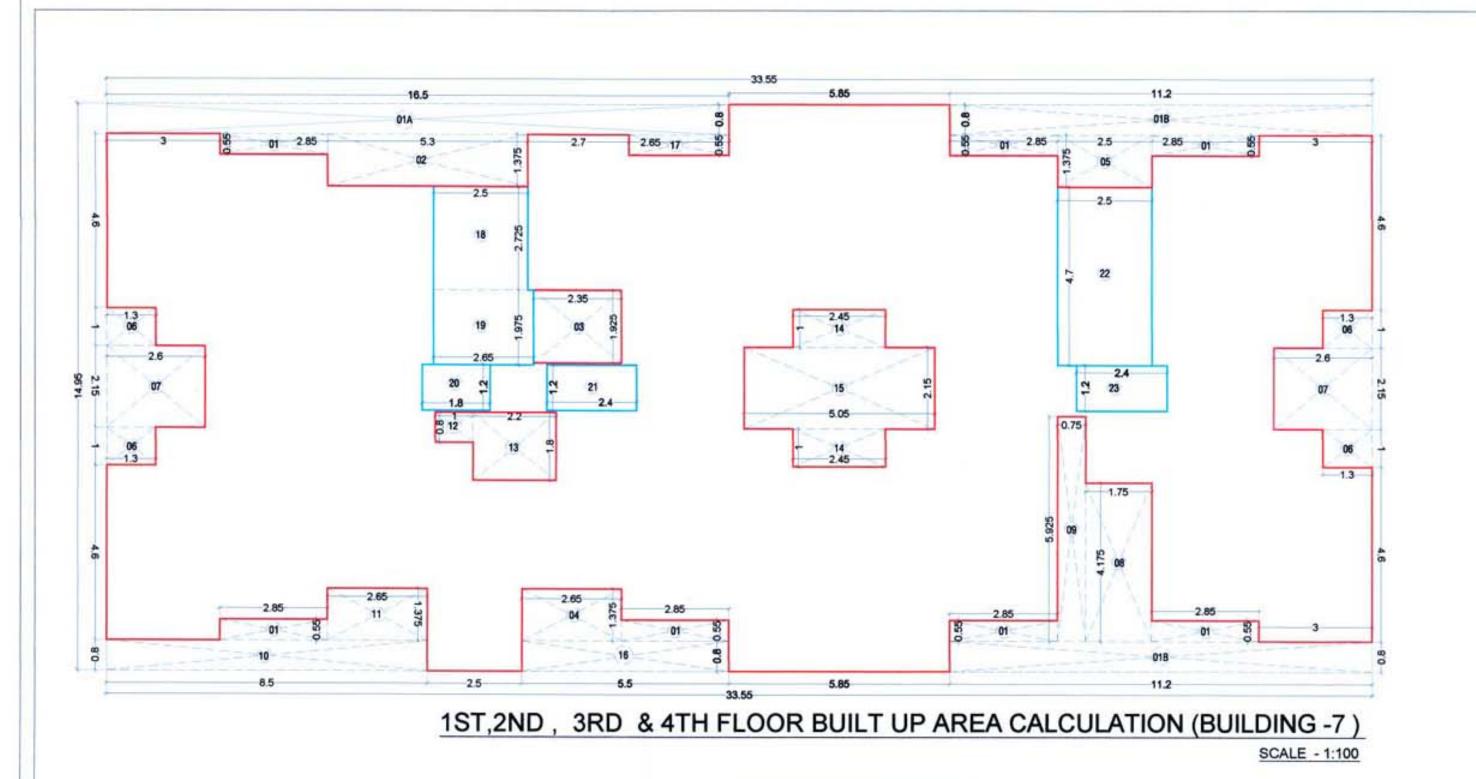

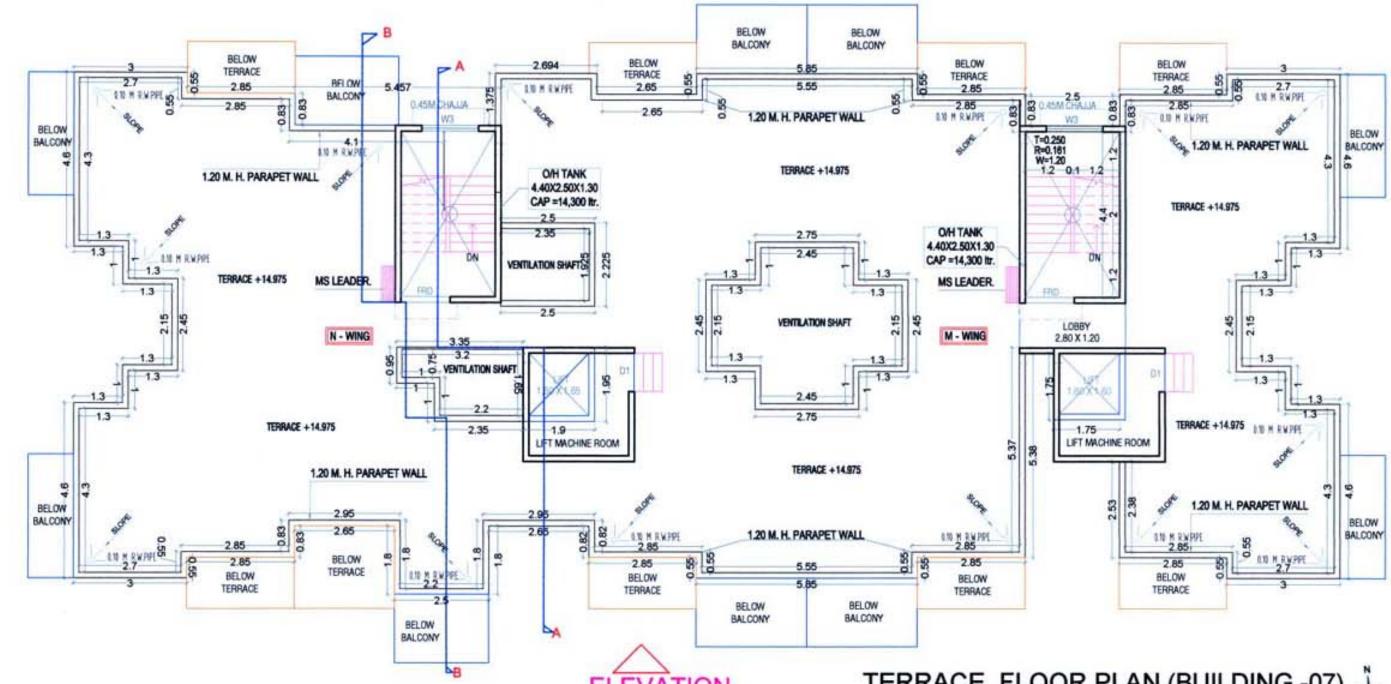



EWS BUILDING SCALE - 1:100

	1ST,2ND,	3RD & 4T	H FLOOR B	UILT UP AR	EA CALCULATION
Block Descriptio	Number of blocks	Length (meter)	Breath (meter)		Area (sqm.)
1	1	33.55	14.950	=	501.573
		SUB	TOTAL : A	=	501.573
			DEDUC	TION	
1	7	2.85	0.550	=	10.973
1A	1	16.50	0.800	=	13.200
1B	2	11.20	0.800	=	17.920
2	1	5.30	1.375	=	7.288
3	1	2.35	1.930	=	4.536
4	1	2.65	1.375	=	3.644
5	1	2.50	1.375	=	3.438
6	4	1.30	1.000	=	5.200
7	2	2.60	2.150	=	11.180
8	1	1.75	4.175	=	7.306
9	1	0.75	5.925	=	4.444
10	1	8.50	0.800	=	6.800
11	1	2.65	1.375	= 1	3.644
12	1	1.00	0.80	=	0.800
13	1	2.20	1.80	=	3.960
14	2	2.45	1.00	=	4.900
15	1	5.05	2.150	=	10.858
16	1	5.50	0.800	=	4.400
17	1	2.65	0.550	= :	1.458
18	1	2.50	2.725	=	6.813
19	1	2.65	1.975	=	5.234
20	1	1.80	1.200	=	2.160
21	1	2.40	1.200	=	2.880
22	1	2.50	4.700	=	11.750
23	1	2.40	1.200	=	2.880
		SUB	TOTAL : B	=	157.662
NET BUILT	UP AREA =		TAL : A) -	=	343.911

BALCONY AREA STATEMENT

		DALC	ONI ARE	ASIAIEM	EN I		
		1ST,	2ND,3RD	& 4TH FL	OOR		
DAT CONT	ALCONY LENGTH BREATH (METER) TOTAL OF BALCONY			NUMBER	AREA IN SQM.		
		PARTLY ENCLOSED	OPEN	ENCLOSED			
OPEN DA	2.95	0.98	2.876	1	0.000	2.876	0.000
OPEN B1	2.80	0.83	2.310		0.000	2.310	0.000
OPEN B2	2.925	1.00	2.925	4	0.000	11.700	0.000
OPEN B3	3.25	1.20	3.900	4	0.000	15.600	0.000
OPEN B4	2.50	1.43	3.563	1	0.000	3.563	0.000
		SI	UBTOTAL	10	0.000	36.049	0.000
TOTAL P	ROPOSED E	BALCONY A		36.049			
	NET BUILT	UP AREA O	343.911				
PERMISSI	BLE BALCO BUILT U	NY AREA P	51.587				
BALANG	E BALCON	Y AREA PE		15.54			

TERRACE AREA STATEMENT

NA

EXCESS BALCONY AREA PER FLOOR, IF ANY

			1ST & 3F	RD FLOOR	
TERRACE TYPE	LENGTH (METER)	BREATH (METER)	TOTAL	NUMBER OF TERRACE	AREA IN SQM
	3.000	0.375	1.125		1.125
T1	2.850	0.425	1.211	1 1	1.211
	2.700	0.550	1.485		1.485
T2	2.850	1.350	3.848	3	11.543
TO	3.000	0.800	2.400	3	7.200
Т3	2.850	0.550	1.568	3	4.703
T4	2.650	2.175	5.764	1	5.764
Т5	2.800	0.800	2.240	1	2.240
	2.650	0.550	1.458		1.458
	36.728				
TOTA	L PROPOSI	ED TERRAC	E AREA 1	ST & 3RD FLOOR	36.728
	343.911				
PERMISSI	68.782				
AREA) X20 % BALANCE TERRACE AREA EACH 1ST & 3RD FLOOR					32.055
EX	EXCESS TERRACE AREA EACH 1ST & 3RD FLOOR				


			2ND & 4T	H FLOOR	
TERRACE TYPE	LENGTH (METER)	BREATH (METER)	TOTAL	NUMBER OF TERRACE	AREA IN SQM
T1	2.650	0.825	2.186	1	2.18625
	2.800	1.350	3.780		3.780
	5.966				
TOTA	L PROPOSE	D TERRAC	E AREA 2N	D &4TH FLOOR	5.966
	343.911				
PERMISSI	68.782				

STAMP OF APPROVAL 16/17

BUILDING NO.7

Approved subject to the condition mentioned in this office letter no.

CIDCO/NAINA/Panvel/Vihighar/BP-63/ACC/2020/52 Dated 16/10/2020

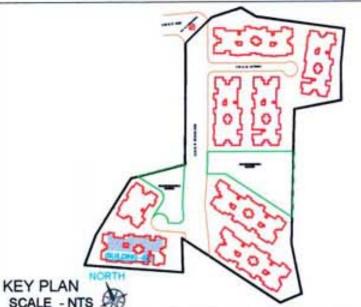

SCALE - NTS

ALL DIMENSIONS ARE IN METERS.
 INTERNAL WALL THICKNESS 0.10 M.
 EXTERNAL WALL THICKNESS 0.15 M.

CONTENT OF THE SHEET

GR., 1ST, 2ND, 3RD & 4th FLOOR PLAN, AREA DIAGRAM & CALCULATION, TERRACE FLOOR PLAN, SECTION AA, BB & CC, ELEVATION OF (BUILDING -07).

Prayag Builders & Developers

Rush

M/s. Prayag Builders & Devlopers through

AR SWAPNIL KALYANKAR
REGD. NO. CA / 2010 / 47491
(Signature of Architect.)

1) MR. PRADEEP KRUSHNA BHOPI (Signature of OWNER)

NAME OF THE OWNER

1) (MR. PRADEEP KRUSHNA BHOPI)


CHKD BY

DESCRIPTION OF PROPOSAL & PROPERTY

Proposed Residential Building On Land Bearing Survey No. 100 / 5B , At Village Vihighar, Tal- Panvel, Dist Raigad, Maharastra.

ARCHITECT NAME	& SIGNATURE	
JOB NO.		
DWG. NO.		
DATE	25-09-2020	
SCALE	1: 100 , N.T.S.	
DRN BY	KISHOR THAKUR	



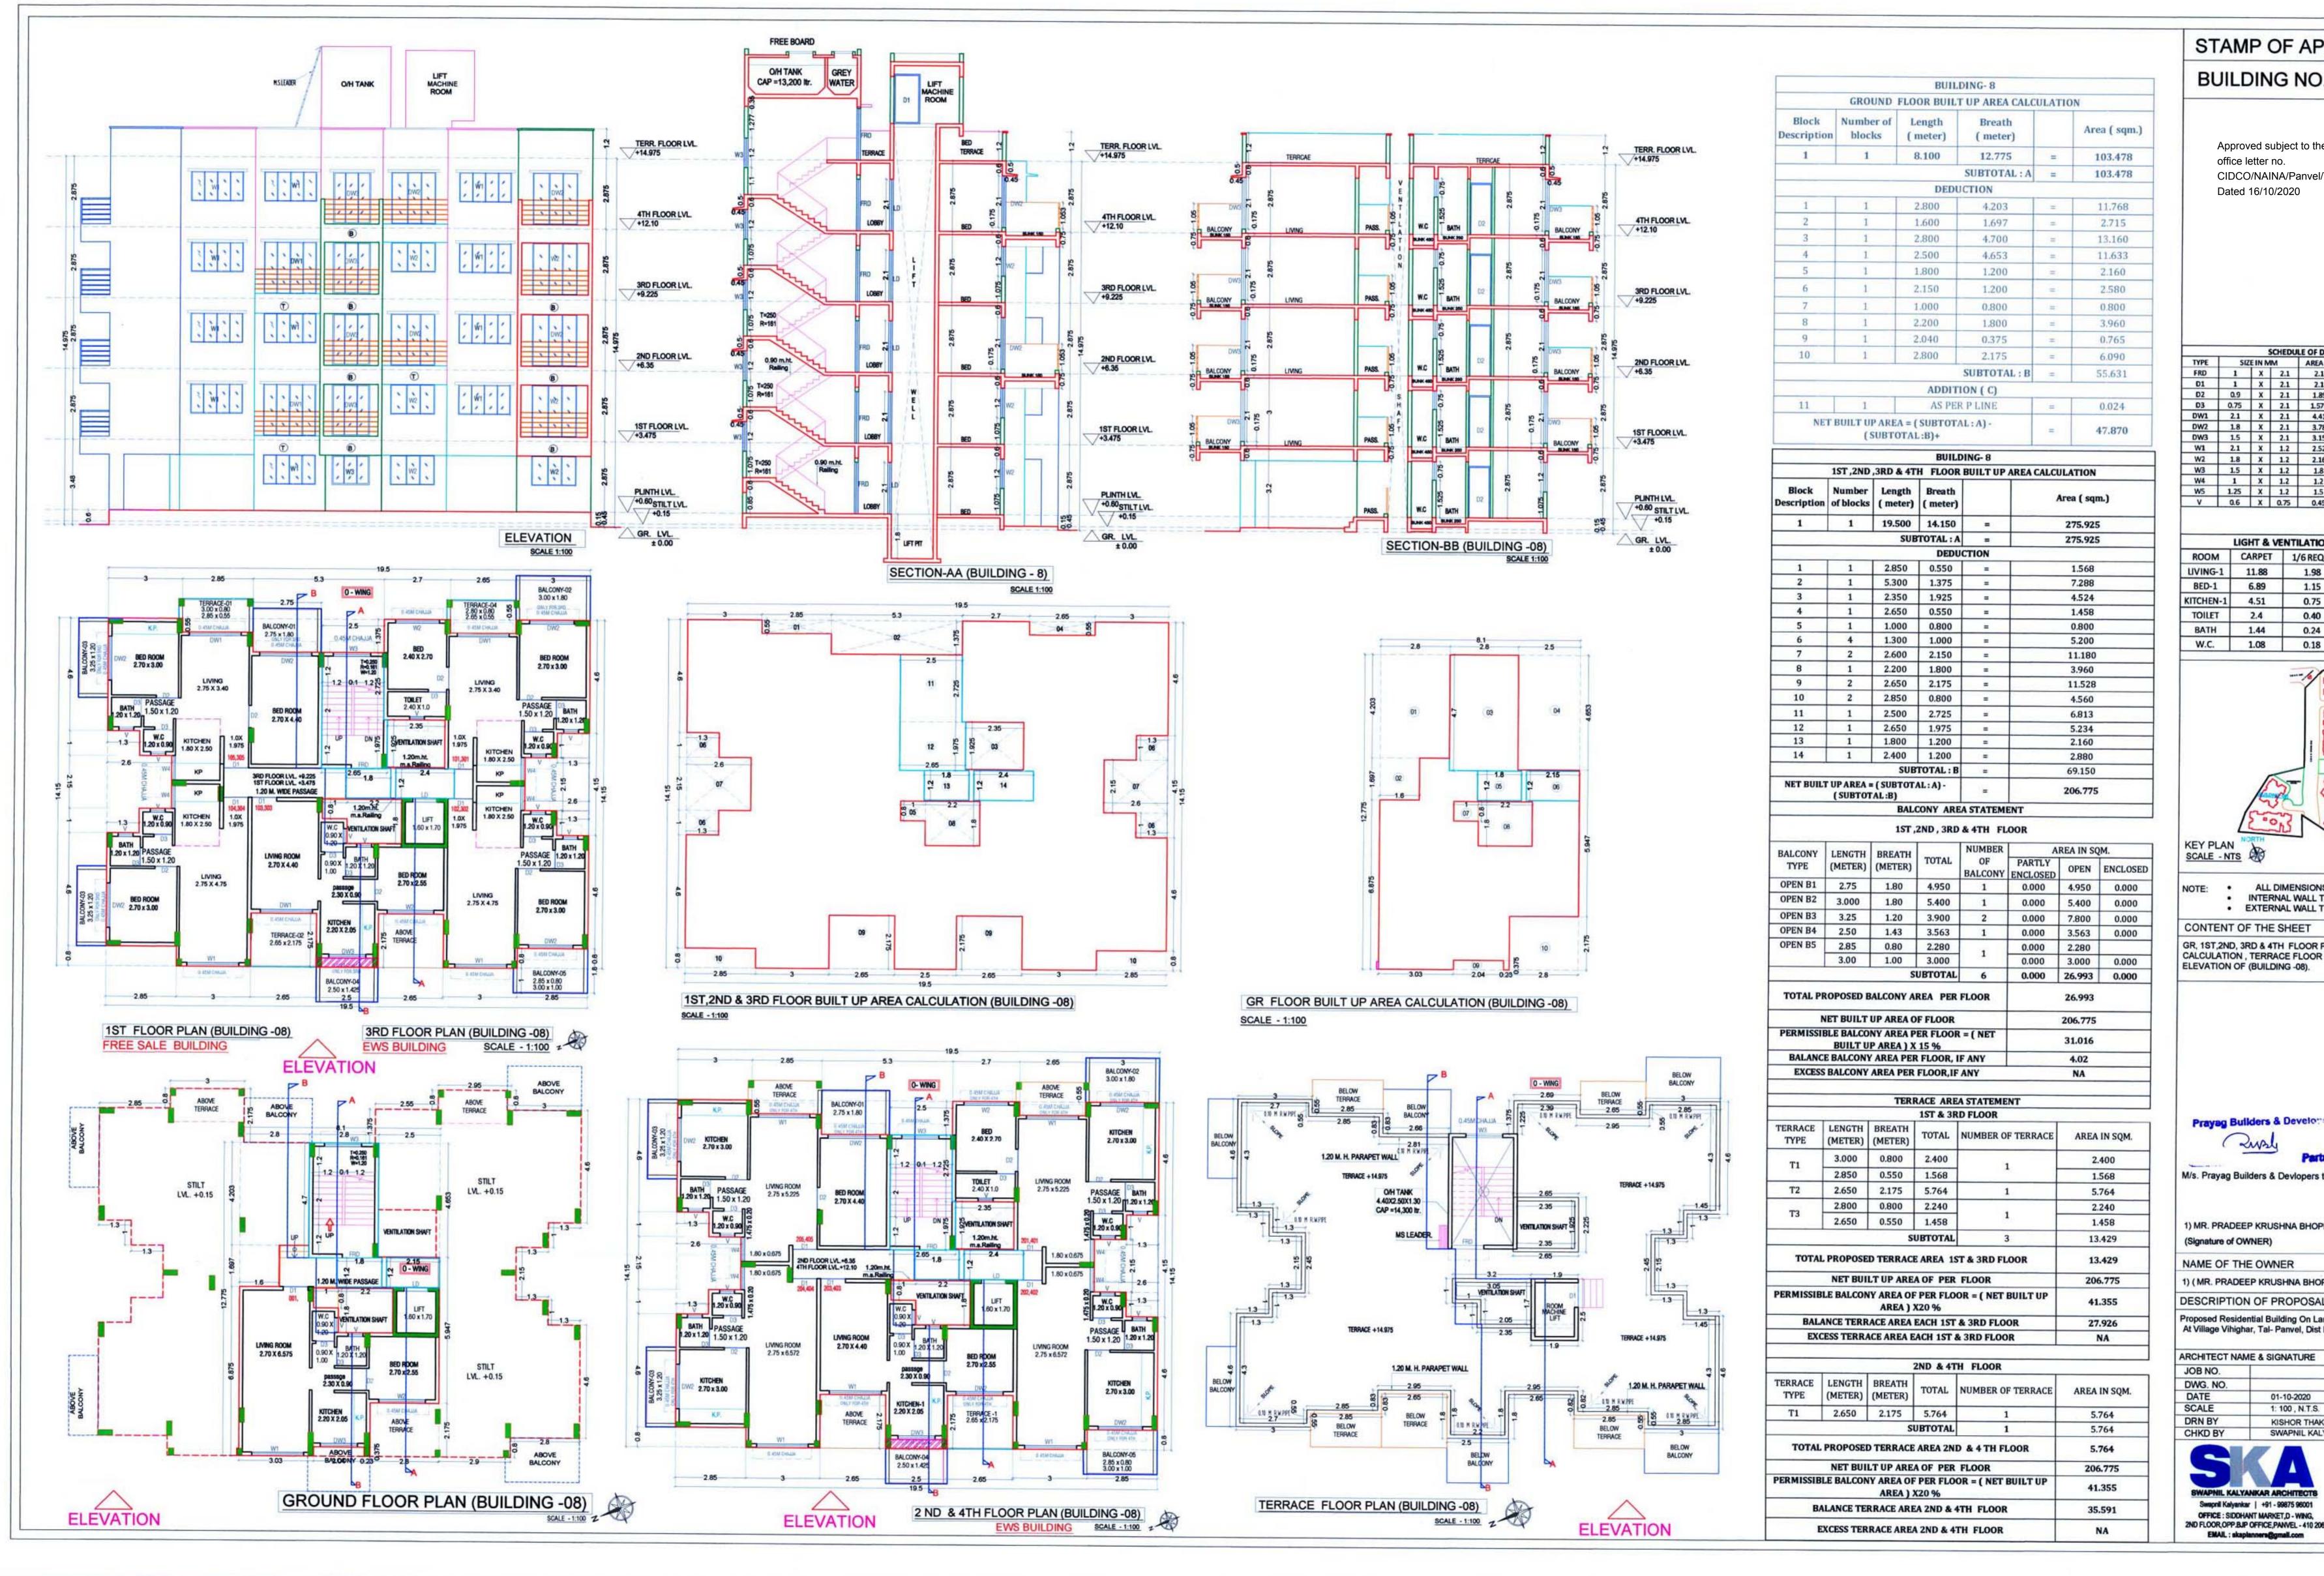

STAMP OF APPROVAL 17/17


BUILDING NO.8

Approved subject to the condition mentioned in this office letter no.

CIDCO/NAINA/Panvel/Vihighar/BP-63/ACC/2020/52 Dated 16/10/2020

		- 3	SCHEDU	LE OF DOO	RS & WINDOWS	
TYPE SIZE IN MM			MM	AREA IN	DISCREPTION	SILL LVL.
FRD	1	X	2.1	2.1	DOOR	
D1	1	X	2.1	2.1	T.W. PANEL DOOR	
D2	0.9	X	2.1	1.89	T.W. PANEL DOOR	
D3	0.75	X	2.1	1.575	T.W. PANEL DOOR	
DW1	2.1	X	2.1	4.41	AL SLIDING FRENCH WINDOW	0.2
DW2	1.8	X	2.1	3.78	AL. SLIDING FRENCH WINDOW	0.2
DW3	1.5	X	2.1	3.15	AL. SLIDING FRENCH WINDOW	0.2
W1	2.1	X	1.2	2.52	AL SUDING WINDOW	1.1
W2	1.8	X	1.2	2.16	AL SLIDING WINDOW	
W3	1.5	X	1.2	1.8	AL SLIDING WINDOW	1.1
W4	1	X	1.2	1.2	AL SLIDING WINDOW	1.1
W5	1.25	X	1.2	1.5	AL SLIDING WINDOW	1.1
٧	0.6	X	0.75	0.45	ALLOUVERD WINDOW	1.55

ROOM	CARPET	1/6 REQD.	TYPE	AREA IN	SILL LVL
LIVING-1	11.88	1.98	DW1	4.41	0.2
BED-1	6.89	1.15	DW2	3.78	0.2
KITCHEN-1	4.51	0.75	DW3	3.15	0.2
TOILET	2.4	0.40	٧	0.45	1.55
BATH	1.44	0.24	٧	0.45	1.55
W.C.	1.08	0.18	٧	0.45	1.55

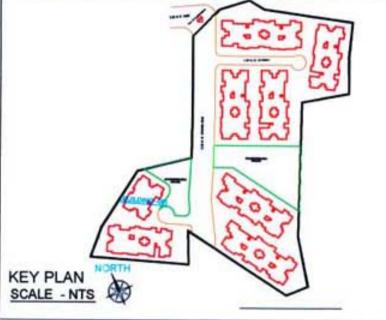

ALL DIMENSIONS ARE IN METERS.

CONTENT OF THE SHEET

R, 1ST,2ND, 3RD & 4TH FLOOR PLAN , AREA DIAGRAM & CALCULATION, TERRACE FLOOR PLAN, SECTION AA & BB, ELEVATION OF (BUILDING -08).



M/s. Prayag Builders & Devlopers through

R. SWAPNIL KALYANKAR

REGD. NO. CA / 2010 / 47491

(Signature of Architect.)

1) MR. PRADEEP KRUSHNA BHOPI (Signature of OWNER)

NAME OF THE OWNER

1) (MR. PRADEEP KRUSHNA BHOPI)

DESCRIPTION OF PROPOSAL & PROPERTY

Proposed Residential Building On Land Bearing Survey No. 100 / 5B , At Village Vihighar, Tal- Panvel, Dist Raigad, Maharastra.

ARCHITECT NAME & SIGNATURE

01-10-2020 1: 100 , N.T.S. KISHOR THAKUR

SWAPNIL KALYANKAR OFFICE: SIDDHANT MARKET,D - WING,