

Approved subject to the condition mentioned in this office letter no. CIDCO/NAINA/Panvel/Kevala/BP-005177CC /2021/0080 Dated: 16 Apr 2021

Sl. No.	Barrenness	TOTAL AREA STATEMENT											
		1	2	3	4	5	6	7	8	9	10	11	12
1	Barrenness	FRUITABLE BALCONY AREA (sq.ft.)	ENCLOSURE TOTAL (sq.ft.)	TOTAL (sq.ft.)	TOTAL (sq.ft.)	TOTAL (sq.ft.)	TOTAL (sq.ft.)	TOTAL (sq.ft.)	TOTAL (sq.ft.)	TOTAL (sq.ft.)	TOTAL (sq.ft.)	TOTAL (sq.ft.)	TOTAL (sq.ft.)
4	TOTAL	1555.68	228.80	228.80	1555.68	1555.68	1555.68	1555.68	1555.68	1555.68	1555.68	1555.68	1555.68
5	TOTAL EXCESS TERRACE	0.00	0.00	0.00	0.00	0.00	0.00	0.00	0.00	0.00	0.00	0.00	0.00
6	TOTAL BALCONY AREA	1555.68	228.80	228.80	1555.68	1555.68	1555.68	1555.68	1555.68	1555.68	1555.68	1555.68	1555.68


***Parking Area Statement									
Sr. No.	Occupancy	One Parking Space for Every	Number of sets	Standard Car	Scooter	Parking type	(1)	(2)	(3)
1	4 Two-wheeled having carpet area upto 35 sq.ft. each.	0.25	44	11	11				
Subtotal Parking required							2	18.25	18.25
Total parking provided							2	18.25	18.25
Total parking provided							21	14	14

Balcony Area Statement*									
Building Number	Floor	Built-up Area (sq.m)	Permissible balcony Area (sq.m)	Enclosed	Open	Total	Excess	(1)	(2)
1	Ground Floor	22.88	3.45	0.00	0.00	0.00	0.00	0.00	0.00
	1st Floor	410.33	61.55	3.75	3.75	7.50	0.00	0.00	0.00
	2nd Floor	410.33	61.55	3.75	3.75	7.50	0.00	0.00	0.00
	3rd Floor	271.59	40.74	23.55	3.75	33.30	0.00	0.00	0.00
	4th Floor	1525.56	228.83	188.40	15.00	203.40	0.00	0.00	0.00
Total									

Terrace Area Statement*									
Building Number	Floor	Built-up Area (sq.m)	Permissible Terrace Area (sq.m)	Total	Excess	(1)	(2)	(3)	(4)
1	Ground Floor	22.88	0.00	0.00	0.00	0.00	0.00	0.00	0.00
	1st Floor	410.33	82.07	41.50	0.00	0.00	0.00	0.00	0.00
	2nd Floor	410.33	82.07	41.50	0.00	0.00	0.00	0.00	0.00
	3rd Floor	271.59	40.74	23.55	0.00	0.00	0.00	0.00	0.00
	4th Floor	1525.56	228.83	188.40	0.00	0.00	0.00	0.00	0.00
Total									

BUILT-UP AREA SUMMARY									
Building No.	Floor	Built-up Area (sq.m)	Permissible Terrace Area (sq.m)	Total	Excess	(1)	(2)	(3)	(4)
1	Ground Floor	22.88	0.00	0.00	0.00	0.00	0.00	0.00	0.00
	1st Floor	410.33	82.07	41.50	0.00	0.00	0.00	0.00	0.00
	2nd Floor	410.33	82.07	41.50	0.00	0.00	0.00	0.00	0.00
	3rd Floor	271.59	40.74	23.55	0.00	0.00	0.00	0.00	0.00
	4th Floor	1525.56	228.83	188.40	0.00	0.00	0.00	0.00	0.00
Total									


PROPOSED ROAD WIDENING AREA CALCULATION									
Sr. No.	Triangle Number	Base (m)	Height (m)	Area (sq.m)	(1)	(2)	(3)	(4)	(5)
1	1	1.72	3.074	2.607	2.607	2.607	2.607	2.607	2.607
2	2	1.72	3.074	2.607	2.607	2.607	2.607	2.607	2.607
3	3	1.72	3.074	2.607	2.607	2.607	2.607	2.607	2.607
TOTAL									

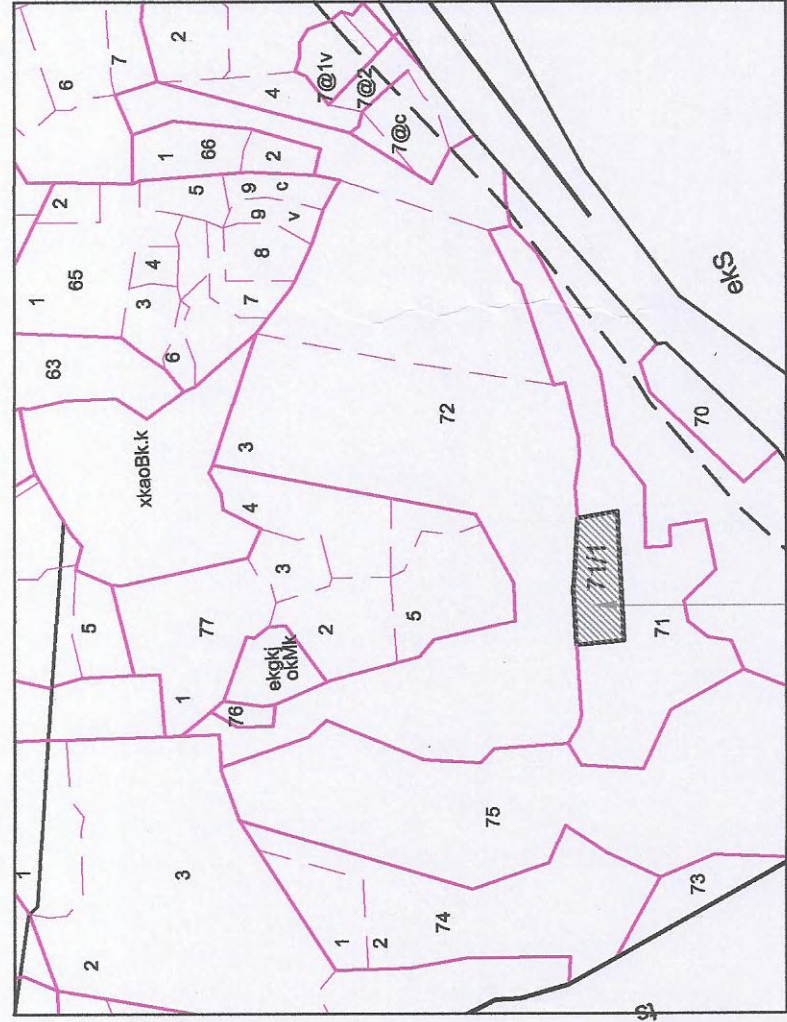


LOCATION PLAN UNDER REFERENCE



SANCTIONED IDP MAP

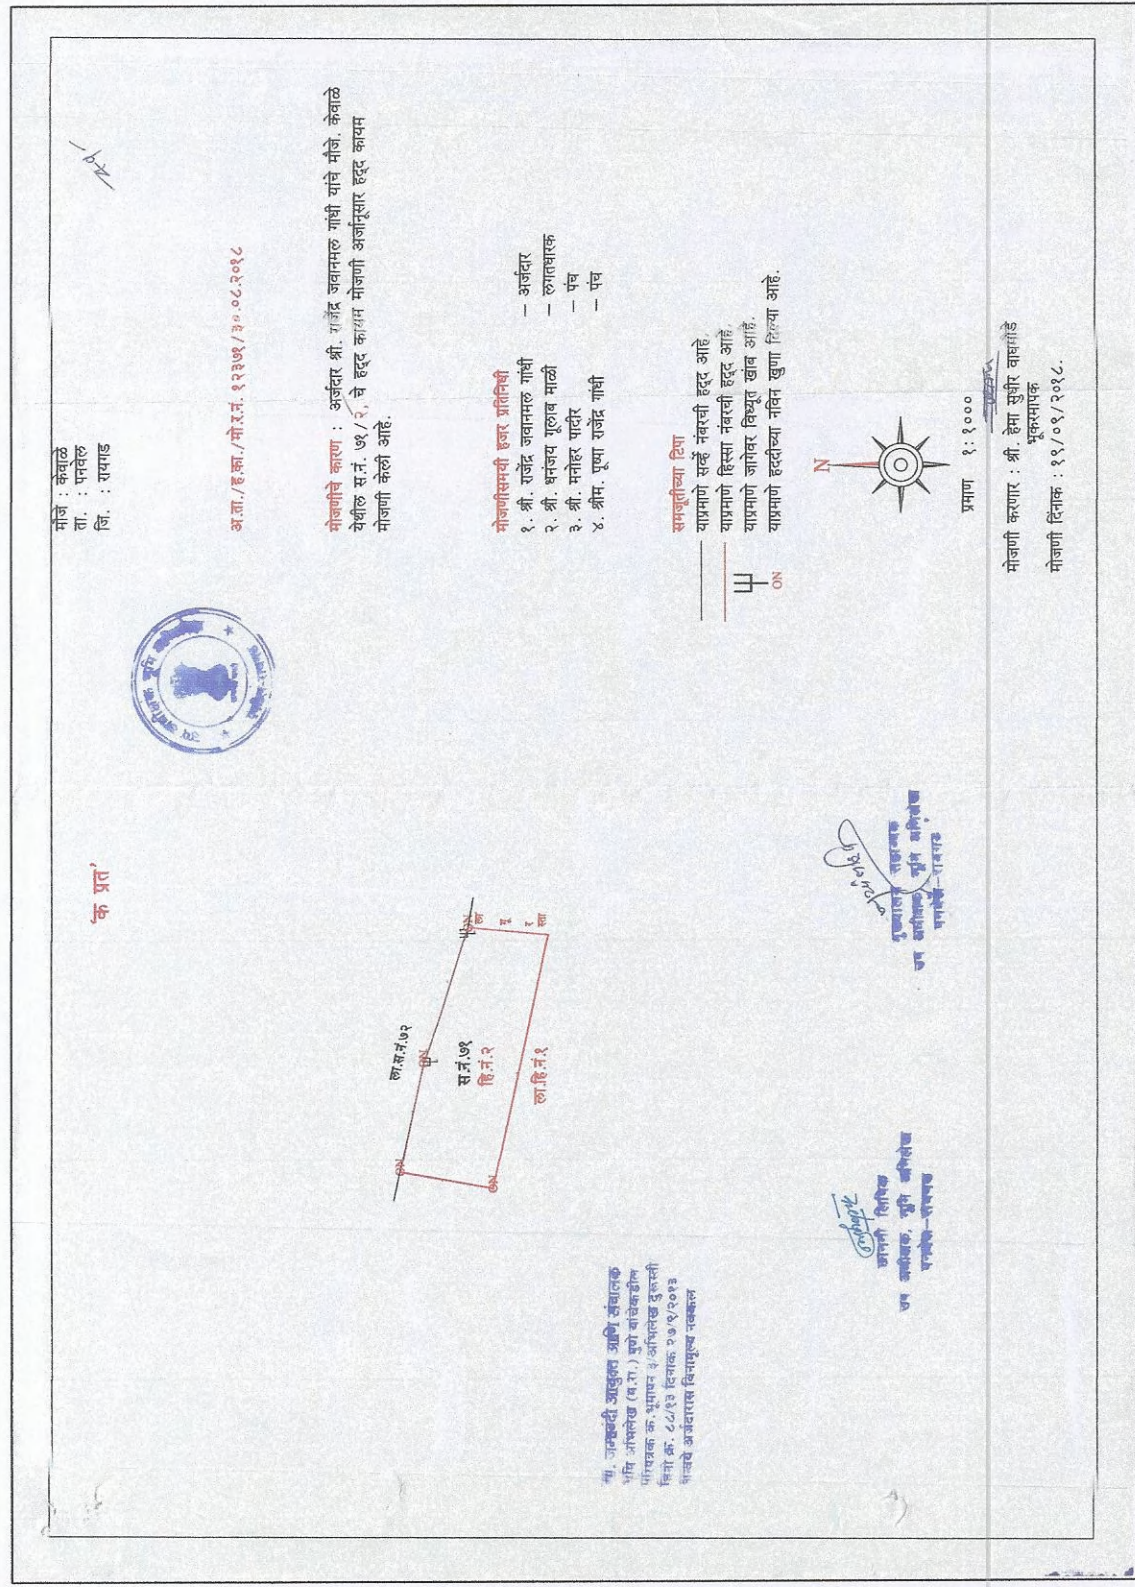

DIGITALIZED SCAN TILR

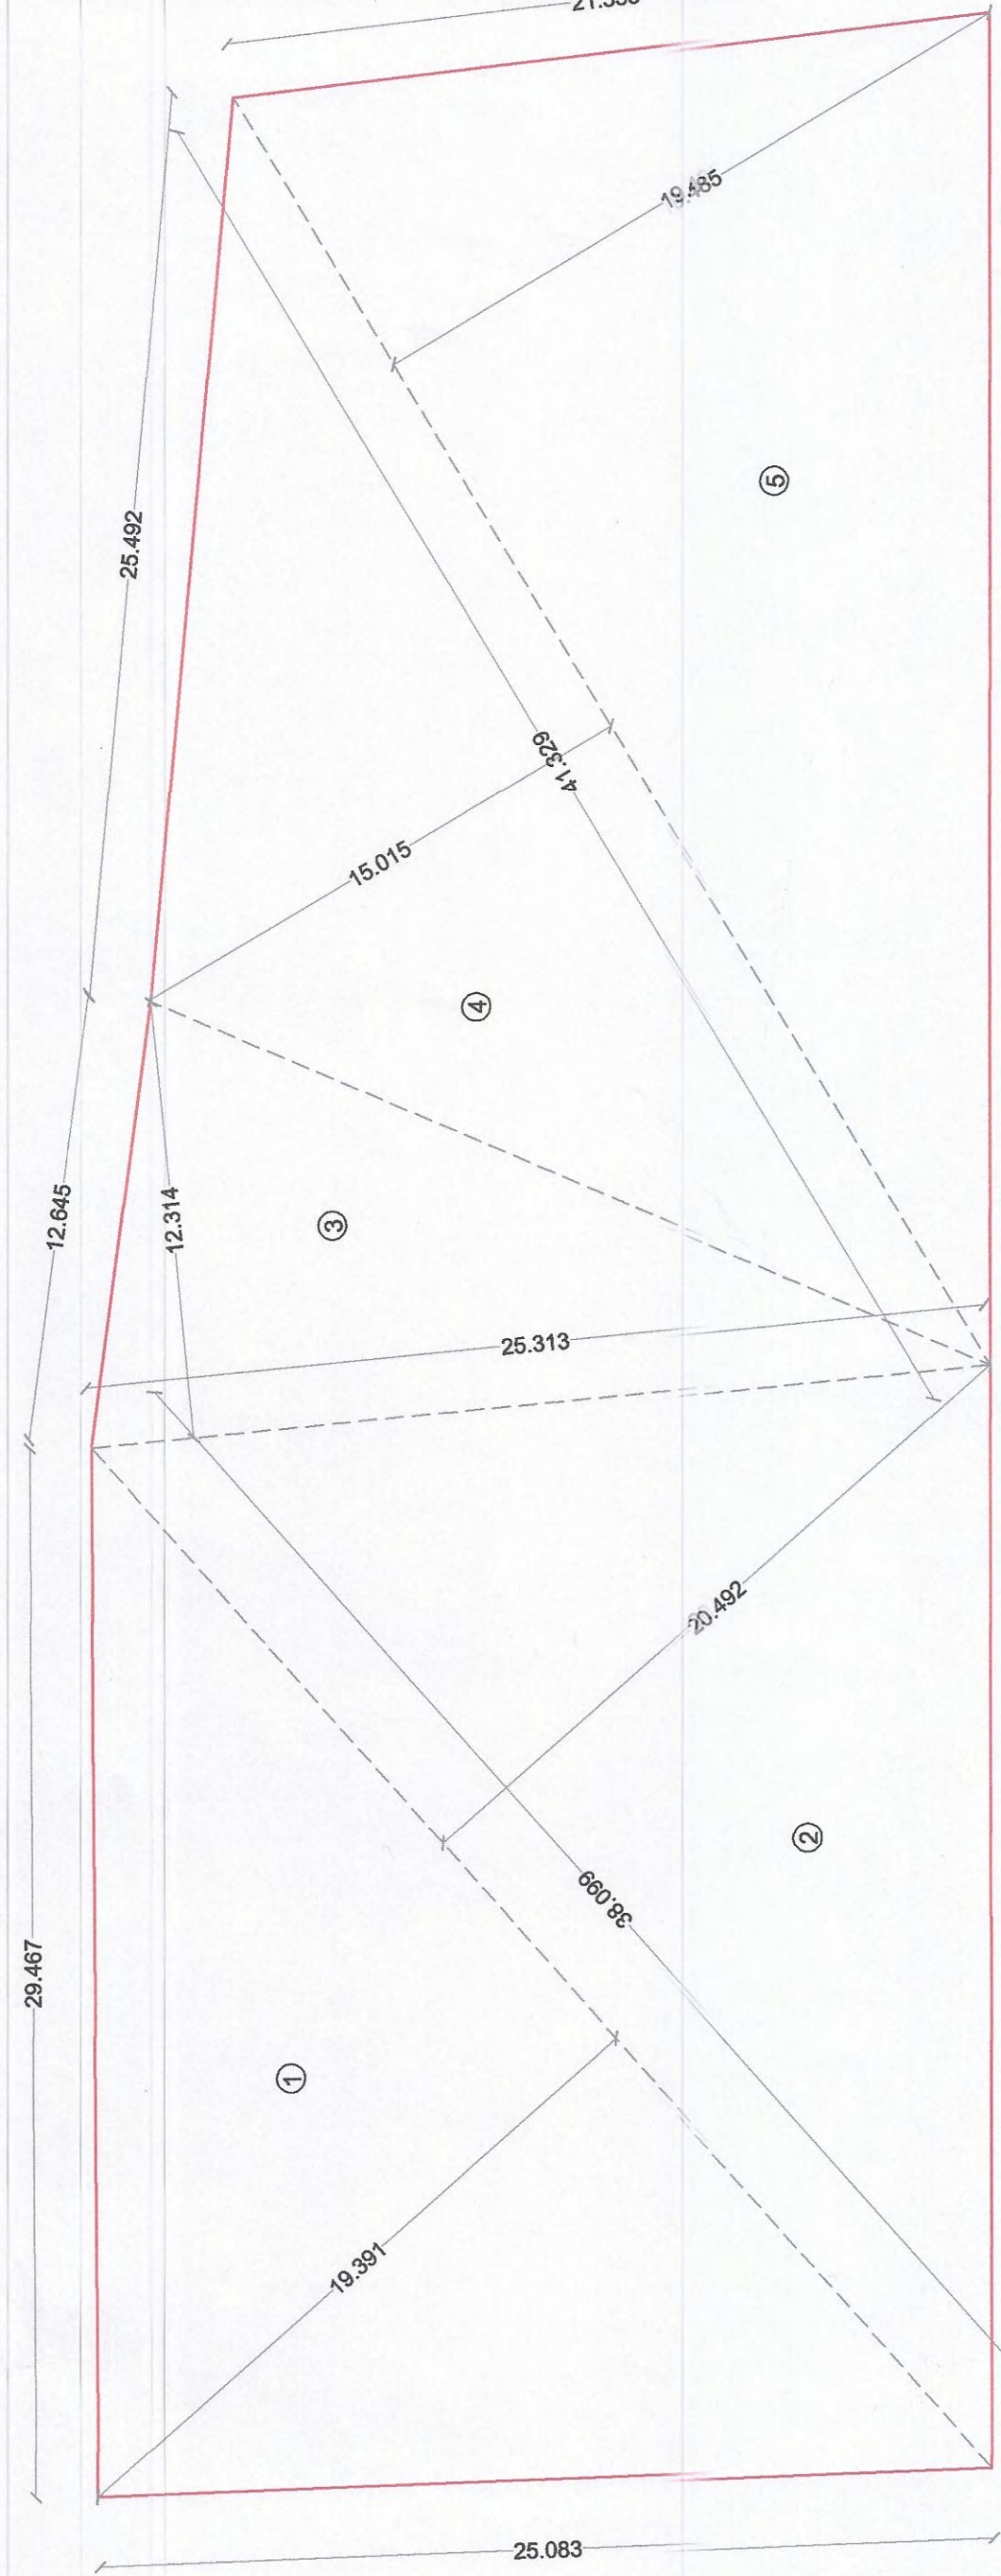

AS PER TILR PLOT AREA CALCULATION DIAGRAM

LEGENDS			
Sr. No.	Item	Site Plan on White Print	Building Plan On White Print
1	PLOT LINE	---	---
2	EXISTING STREET	---	---
3	PERMISSIBLE BUILDING LINES	---	---
4	BUILT UP AREA LINES	---	---
5	MARGINAL C/S SPACES	---	---
6	WATER SUPPLY WORK	---	---
7	R/W/LINE	---	---
8	S.W. DRAIN	---	---
9	BLK CAR PARKING	---	---
10	SMALL CAR PARKING	---	---
11	EXISTING OTHER TREES TO BE RETAINED	---	---
12	EXISTING MANGROVE TREES TO BE RETAINED	---	---

PLOT AREA CALCULATION (TILR BOUNDARY)			
Sr. No.	Triangle Number	Base (m)	Height (m)
1	1	1.72	3.074
2	2	1.72	3.074
3	3	1.72	3.074
4	4	1.72	3.074
5	5	1.72	3.074
TOTAL PLOT AREA AS PER TILR			

PROPOSED ROAD WIDENING AREA DIAGRAM FOR CALCULATION (SCALE 1:100)

R.G. AREA CALCULATION DIAGRAM (SCALE 1:100)

R.G. AREA CALCULATION			
Sr. No.	Triangle Number	Base (m)	Height (m)
1	1	1.72	3.074
2	2	1.72	3.074
3	3	1.72	3.074
4	4	1.72	3.074
5	5	1.72	3.074
TOTAL R.G. AREA			

FORM OF CERTIFICATE  
I have examined the above plan and the same has been approved by the applicant as the Architect. I have examined the boundaries and the area of the plot and I do hereby certify that I have personally verified and checked all the statements made by the applicant who is the owner/lessee in possession of the plot as in the above form and found them to be correct. Date: 08/10/2019

Signature of Architect  
ANARCH  
ARCHITECT & PLANNERS  
REG NO: CA200843603

CERTIFICATE OF AREA  
Reference was surveyed by me on 19/09/2018 and the dimensions of site etc. of plot stated on plan are as measured on site and the area so worked out tallies with the area stated in document of ownership T.P. Scheme Records/ Land Records Department City survey record.

NAME OF THE OWNER & SIGNATURE  
Rajendra J Gandhi  
ANARCH  
ARCHITECT & PLANNERS  
REG NO: CA200843603

NAME OF THE OWNER & SIGNATURE

NAME OF THE OWNER & SIGNATURE  
Rajendra J Gandhi  
ANARCH  
ARCHITECT & PLANNERS  
REG NO: CA200843603

SHEET CONTENT :-  
LOCATION PLAN LAYOUT PLAN  
PLOT AREA & R.G. DAIGRAM,  
BUILT UP AREA STATEMENT,  
TENEMENT AREA STATEMENT,  
PARKING AREA STATEMENT,  
BALCONY AREA STATEMENT,  
TERRACE AREA STATEMENT.

DESCRIPTION OF PROPOSAL & PROPERTY  
PROPOSED RESIDENTIAL BUILDING ON LAND BEARING SURVEY No. 71/2 AT VILLAGE - KEVALA, TAL - PANVEL, DIST - RAIGAD.


ARCHITECT NAME & SIGN  
ANARCH  
ARCHITECT & PLANNERS  
REG NO: CA200843603

DATE  
26-02-2020

CHKD. BY  
SCALE  
NORTH

ANARCH  
ARCHITECT & PLANNERS  
Office no. 204/1, Rajajyoti Arcade, Sec-11, 2nd floor, G.D. Road, Sector-11, Noida-201301  
Sect-11, 2nd floor, G.D. Road, Sector-11, Noida-201301  
Sect-11, 2nd floor, G.D. Road, Sector-11, Noida-201301

ADJ. SURVEY No. 72

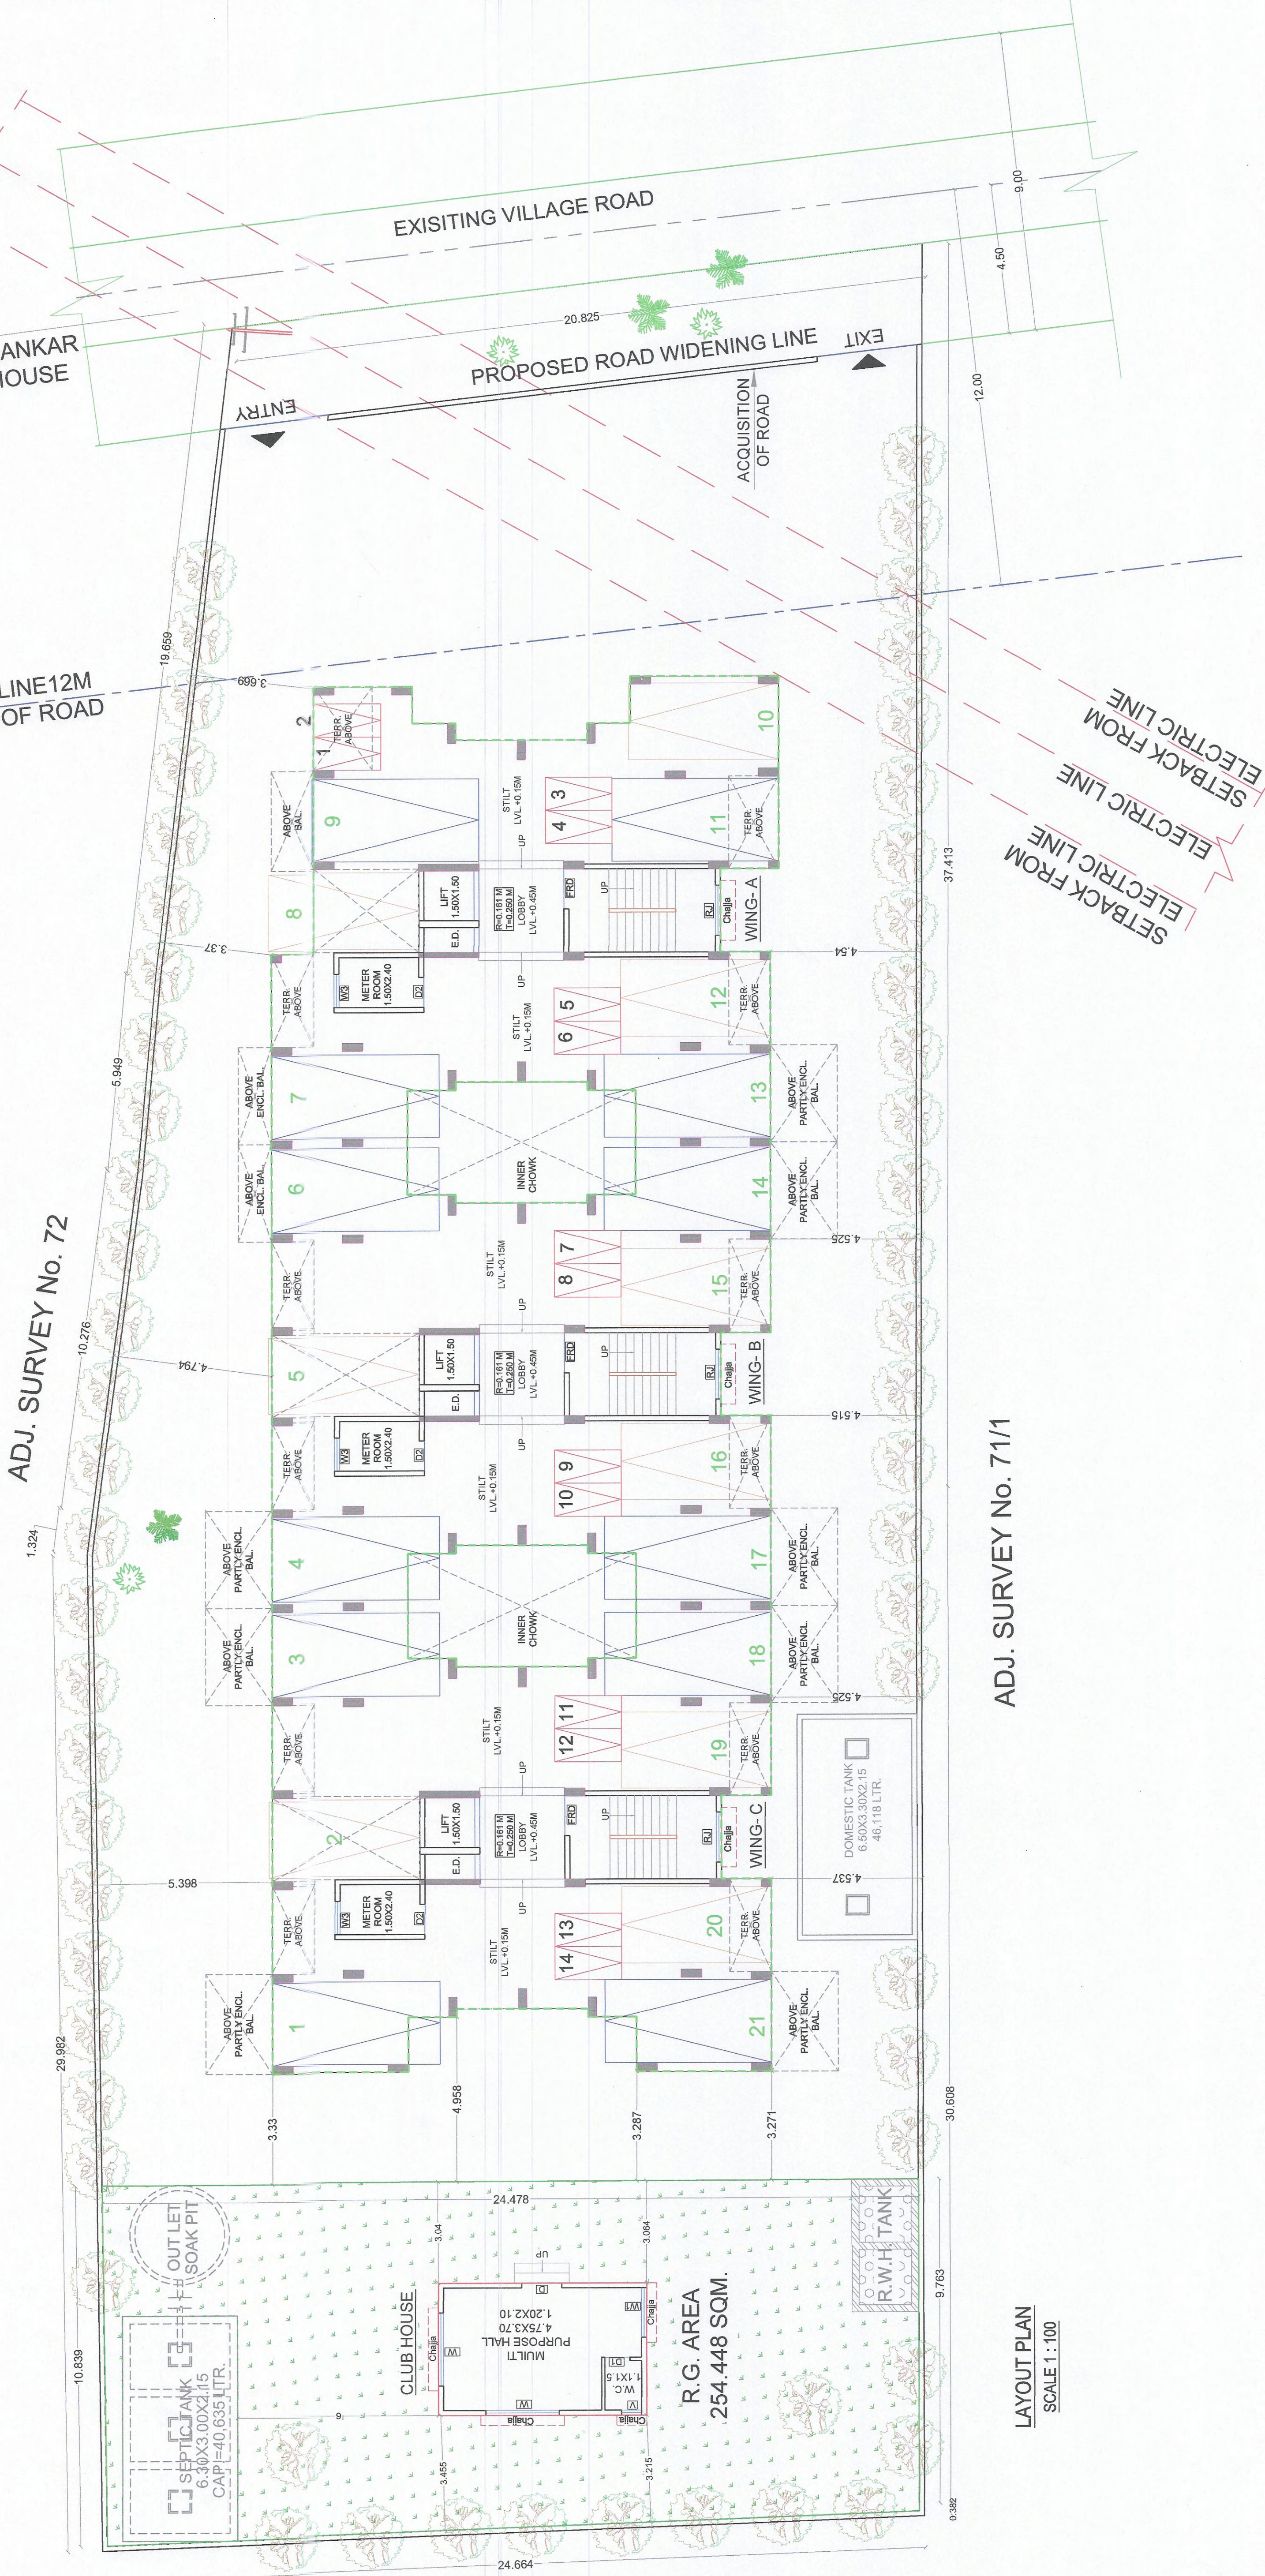

ADJ. SURVEY No. 71/1

LAYOUT PLAN SCALE 1:100



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NAME OF THE OWNER & SIGNATURE

Rajendra J. Ganesh

(SIGNATURE OF OWNER)

SHEET CONTENT :-

SERVICES LAYOUT PLAN, SEPTIC TANK REQUIREMENT, WATER STORAGE CAP. CALCULATION, DETAILS OF U.G. TANK, DETAILS OF SEPTIC TANK, ENTRANCE GATE ELEVATION, TYP. SECTION OF S.W. DRAIN LINE/COMPOUND WALL, DETAILS OF RECHARGE PIT, TYP. ECENTRIC FOOTING SECTION.

DESCRIPTION OF PROPOSAL & PROPERTY

PROPOSED RESIDENTIAL BUILDING ON LAND BEARING SURVEY No. 71/2 AT VILLAGE - KEVALE, TAL - PANVEL, DIST - RAIGAD.

ARCHITECT NAME & SIGN

AN.ARCH  
ARCHITECT & PLANNERS

NEHA JAIN  
REG NO : CA/2008/43603

DATE	DRAWN BY	CHKD. BY	SCALE	NORTH
26-02-2020	Rajeshree	Gharat	AS SHOWN	N

Office no.20&21, -Raheja Arcade, Sec-11, Plot no.61, CBD Belapur-400614, catel no.022-27563410, mail id-anarchitect@gmail.com

ADJ. SURVEY No. 72








ADJ. SURVEY No. 71/1

SERVICE PLAN  
SCALE 1 : 100

SEPTIC TANK CALCULATION																
BUILDING No.	NUMBER OF TENEMENT	POPULATION PER UNIT	TOTAL POPULATION (APPROX)	COLD WATER REQUIREMENT				GROSS WATER REQUIREMENT		% FLOW TO SEWER		TOTAL FLOW	TOTAL FLOW TO SEPTIC TANK	TOTAL PROVIDED SEPTIC TANK SIZE	TOTAL PROVIDED SEPTIC TANK CAPACITY	
				FLUSHING		DOMESTIC		(A+B)		FLUSHING 100%	DOMESTIC 85%					
				(A)	(B)											
				LPCD	LPD	LPCD	LPD	LPD	LPD	LPD	LPD	KLD	KLD	IN M.	KLD	
1	FLATS (44)	5	220	54	11880	135	29700	41580	11880	25245		37125	37.13	TANK-2 = 6.30X3.00X2.15	40.635	
TOTAL REQUIRED CAPACITY OF SEPTIC TANK												37125.00	37.13			40.635
TOTAL PROVIDED SEPTIC TANK																40635 LTRS





WATER STORAGE CAPACITY CALCULATION									
BLDG. NO.	TOTAL NO. OF FLATS	ADD. TOILET 180 LITER	POPULATION	WATER REQUIREMENTS (IN LITER)			UGT PROVIDED		
				ADD. TOILET	POPULATION	TOTAL	TANK NUMBER	SIZE/ DIMENSION	CAPACITY (LTR.)
[1]	[2]	[3]	[4]=[2]X[5]	[5]=[3]X180	[6]=[4]X189	[7]=[5]+[6]	[8]	[9]	[10]
1	44	0	220	0	41580	41580	TANK NO. 1	6.50X3.30X2.15	46,118
TOTAL									

NOTE:  
1) FOR RESIDENTIAL UNIT 5 PERSONS PER TENEMENT.  
2) WATER REQUIREMENT PER CAPITA = 135(DOMESTIC)+54(FLUSHING)=189 LTRS. PER CAPITA.  
3) WATER REQUIREMENT FOR ADD. TOILET = 180 LTRS. PER TENEMENT.  
4) SIZE OF WATER TANK IS EXCLUDING THE FREE BOARD.

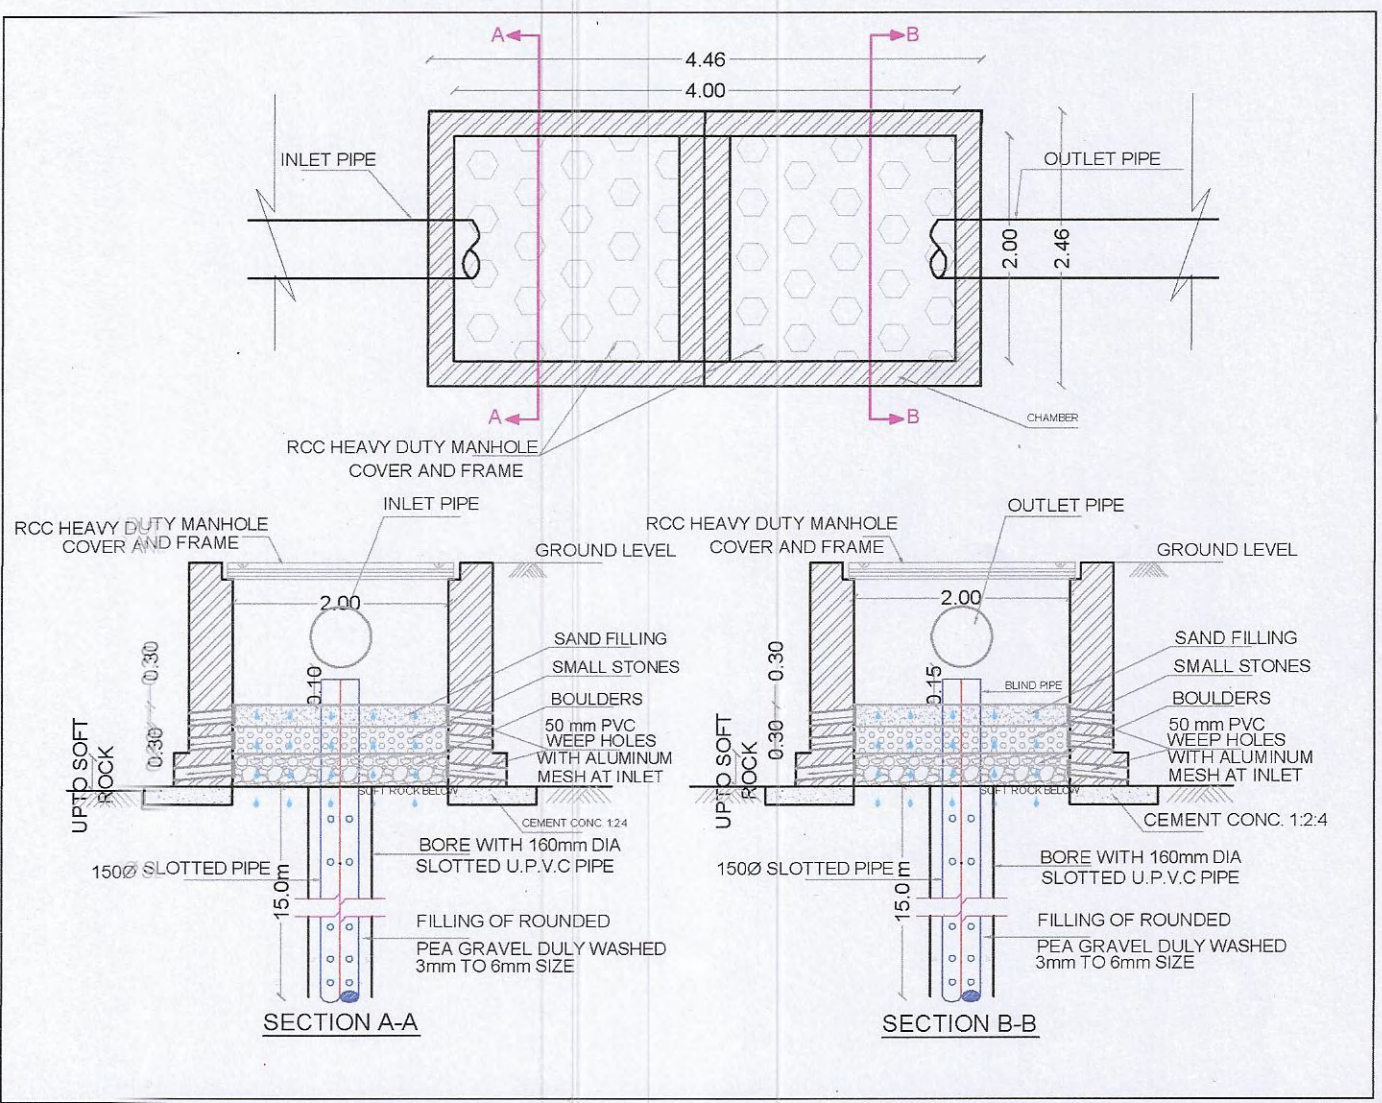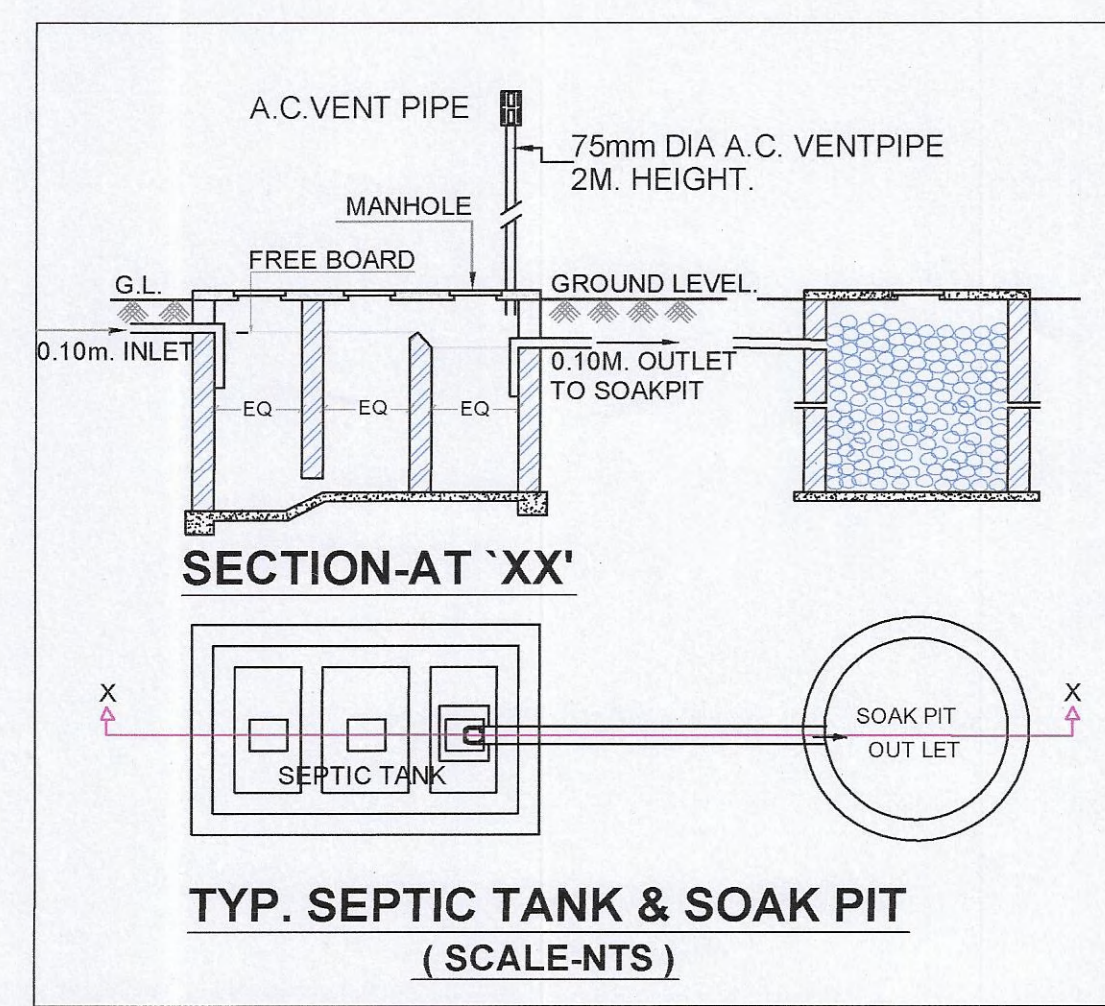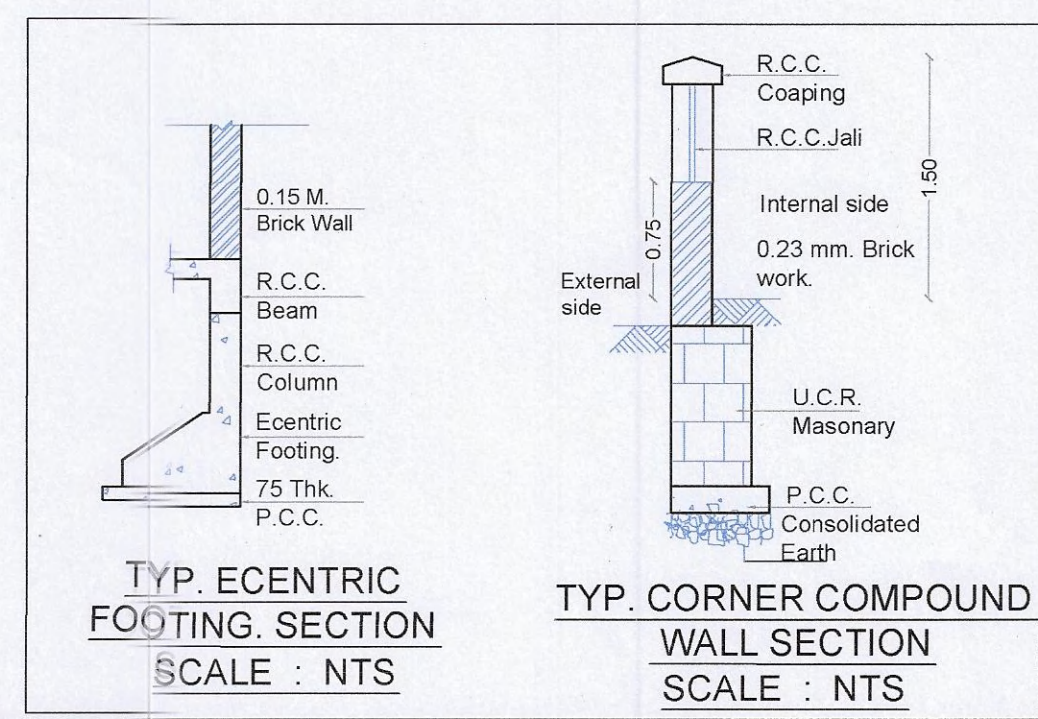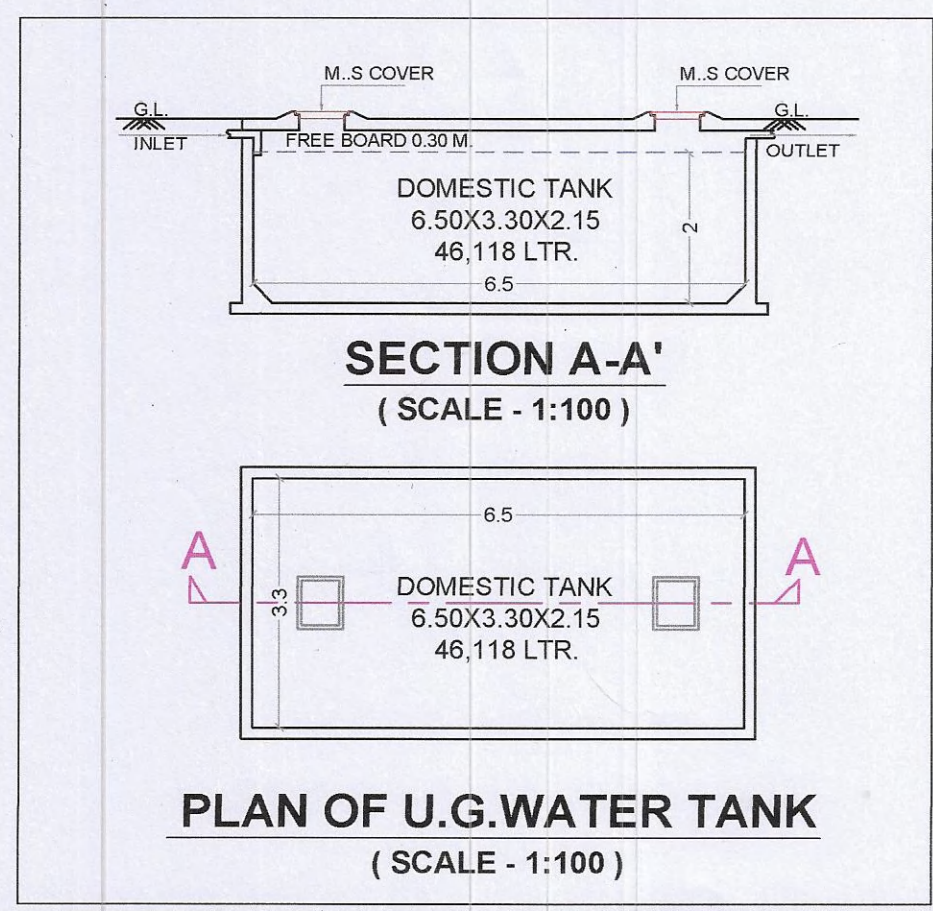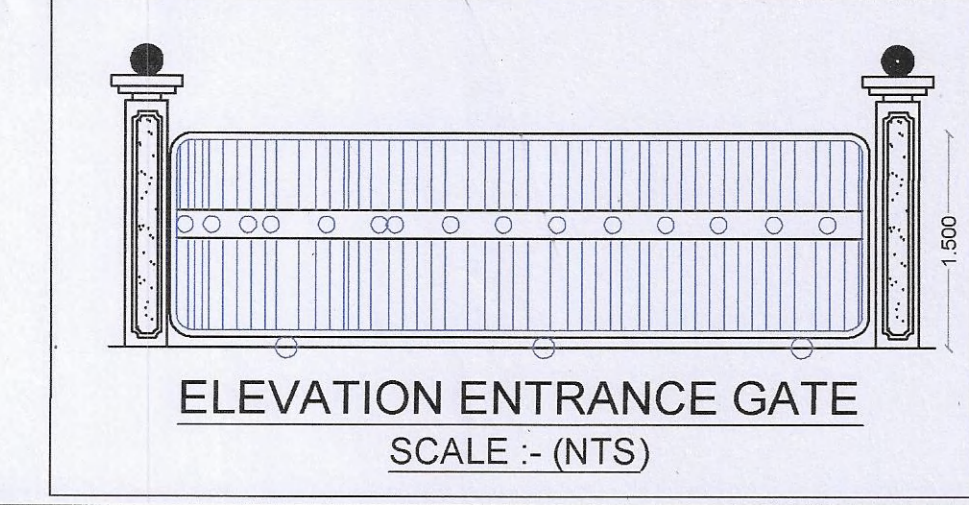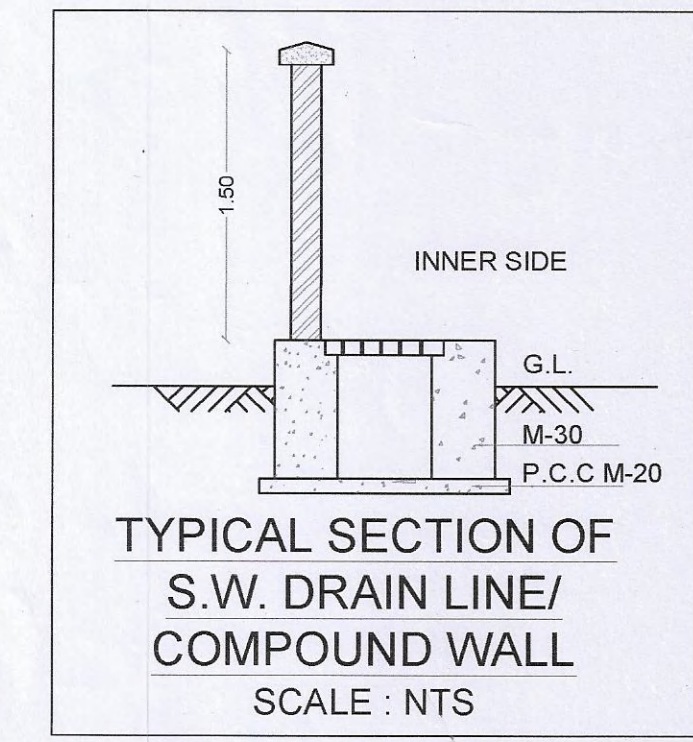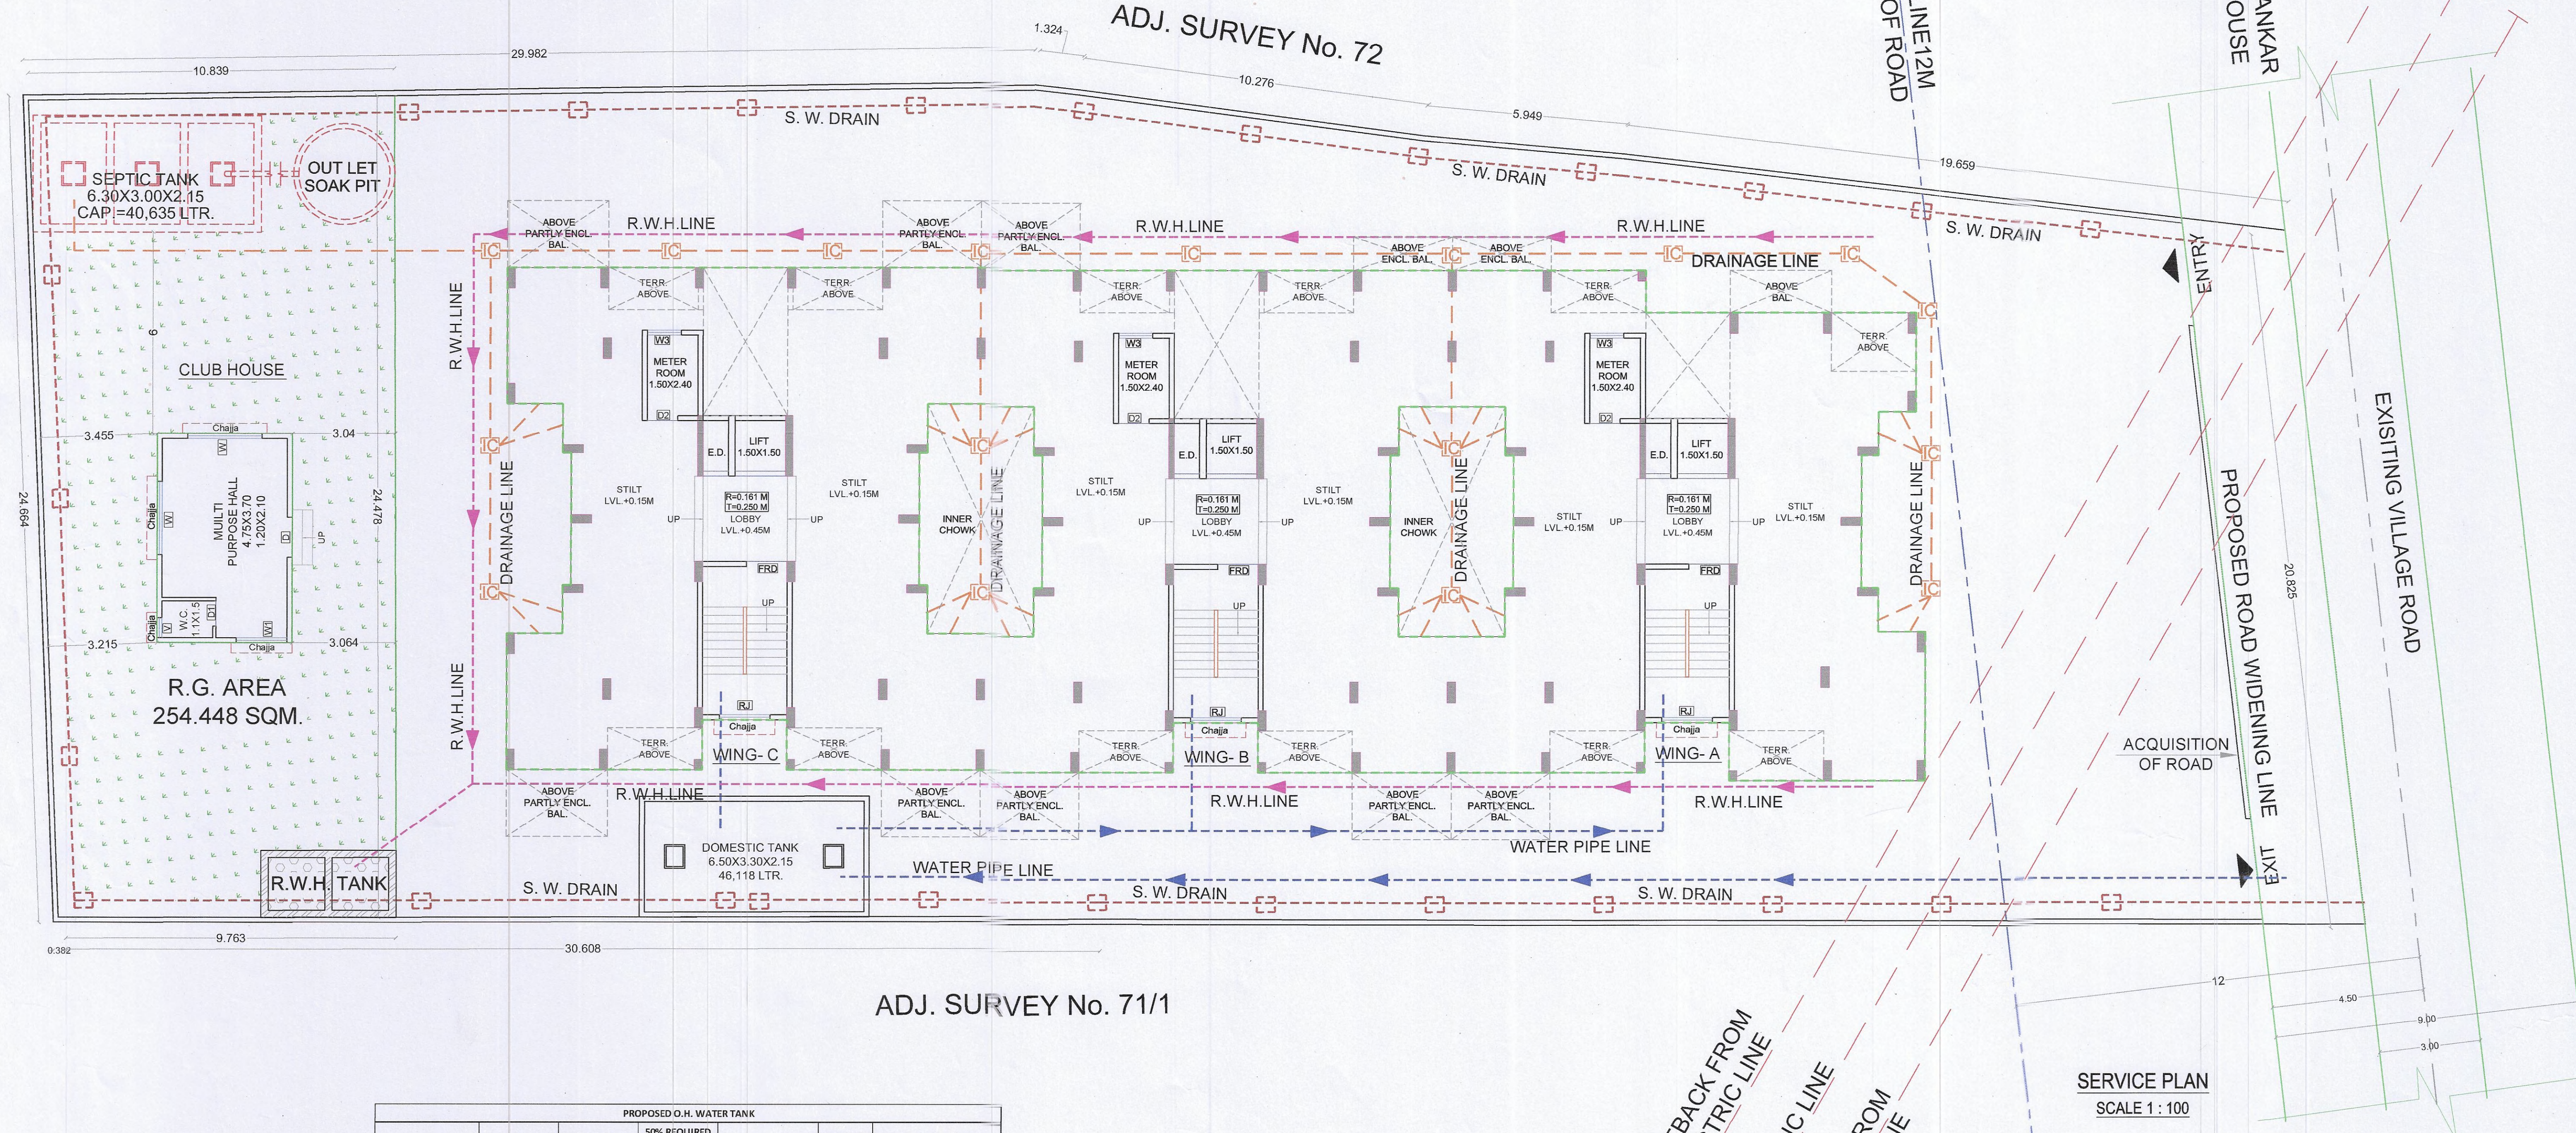




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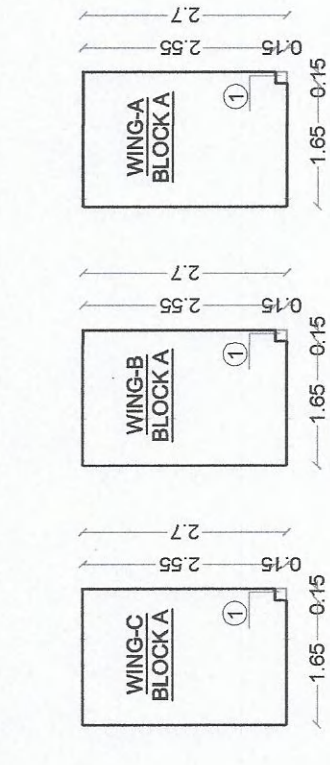
A SIDE ELEVATION  
SCALE = 1:1002ND FLOOR PLAN  
(SCALE 1:100)1ST & 3RD FLOOR PLAN  
(SCALE 1:100)GROUND FLOOR PLAN  
(SCALE 1:100)GROUND FLOOR AREA DIAGRAM & CALCULATION  
(SCALE 1:100)

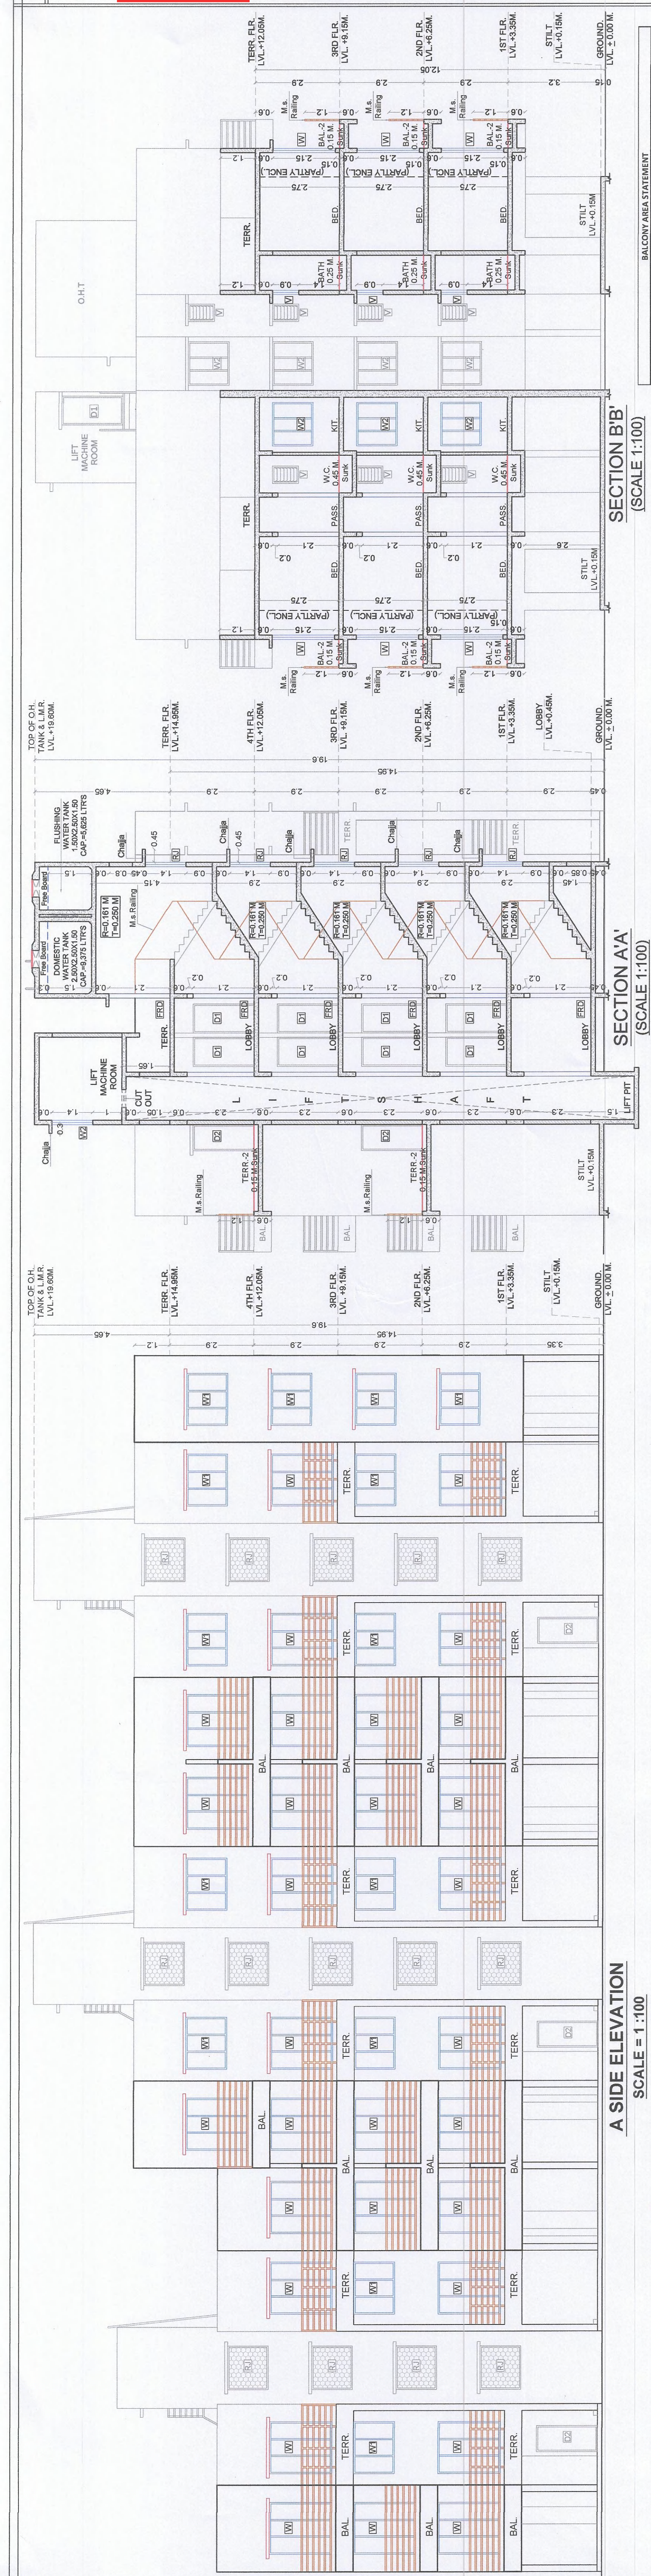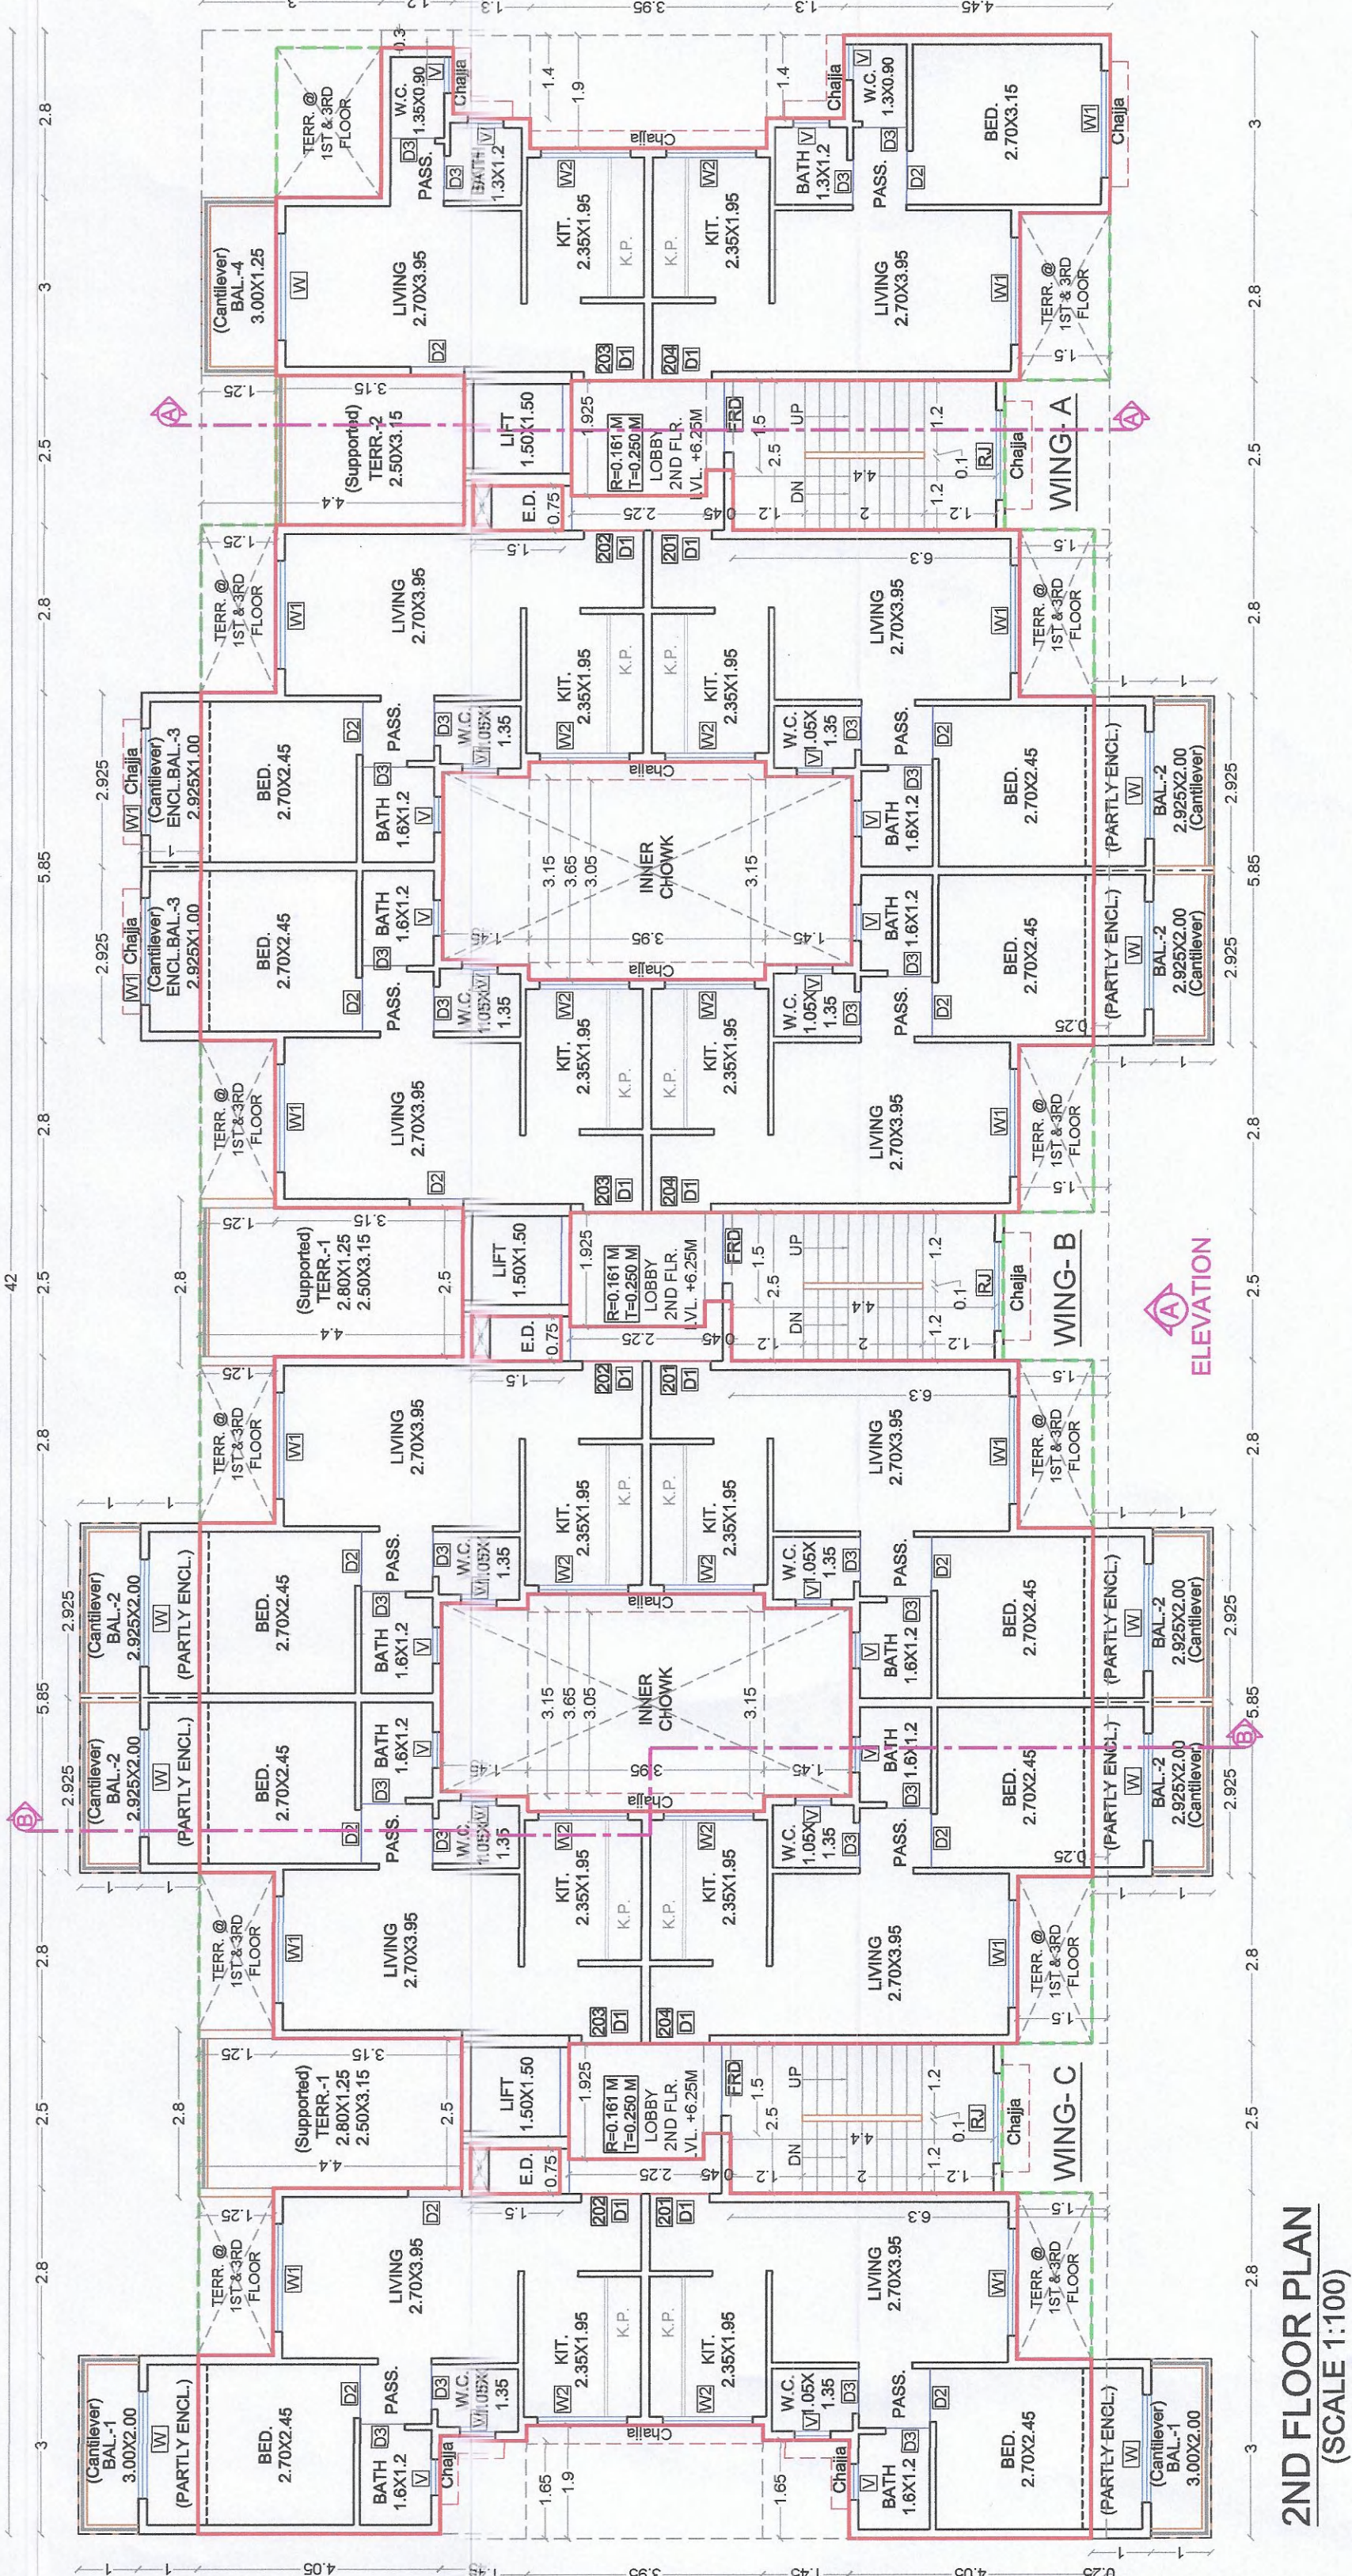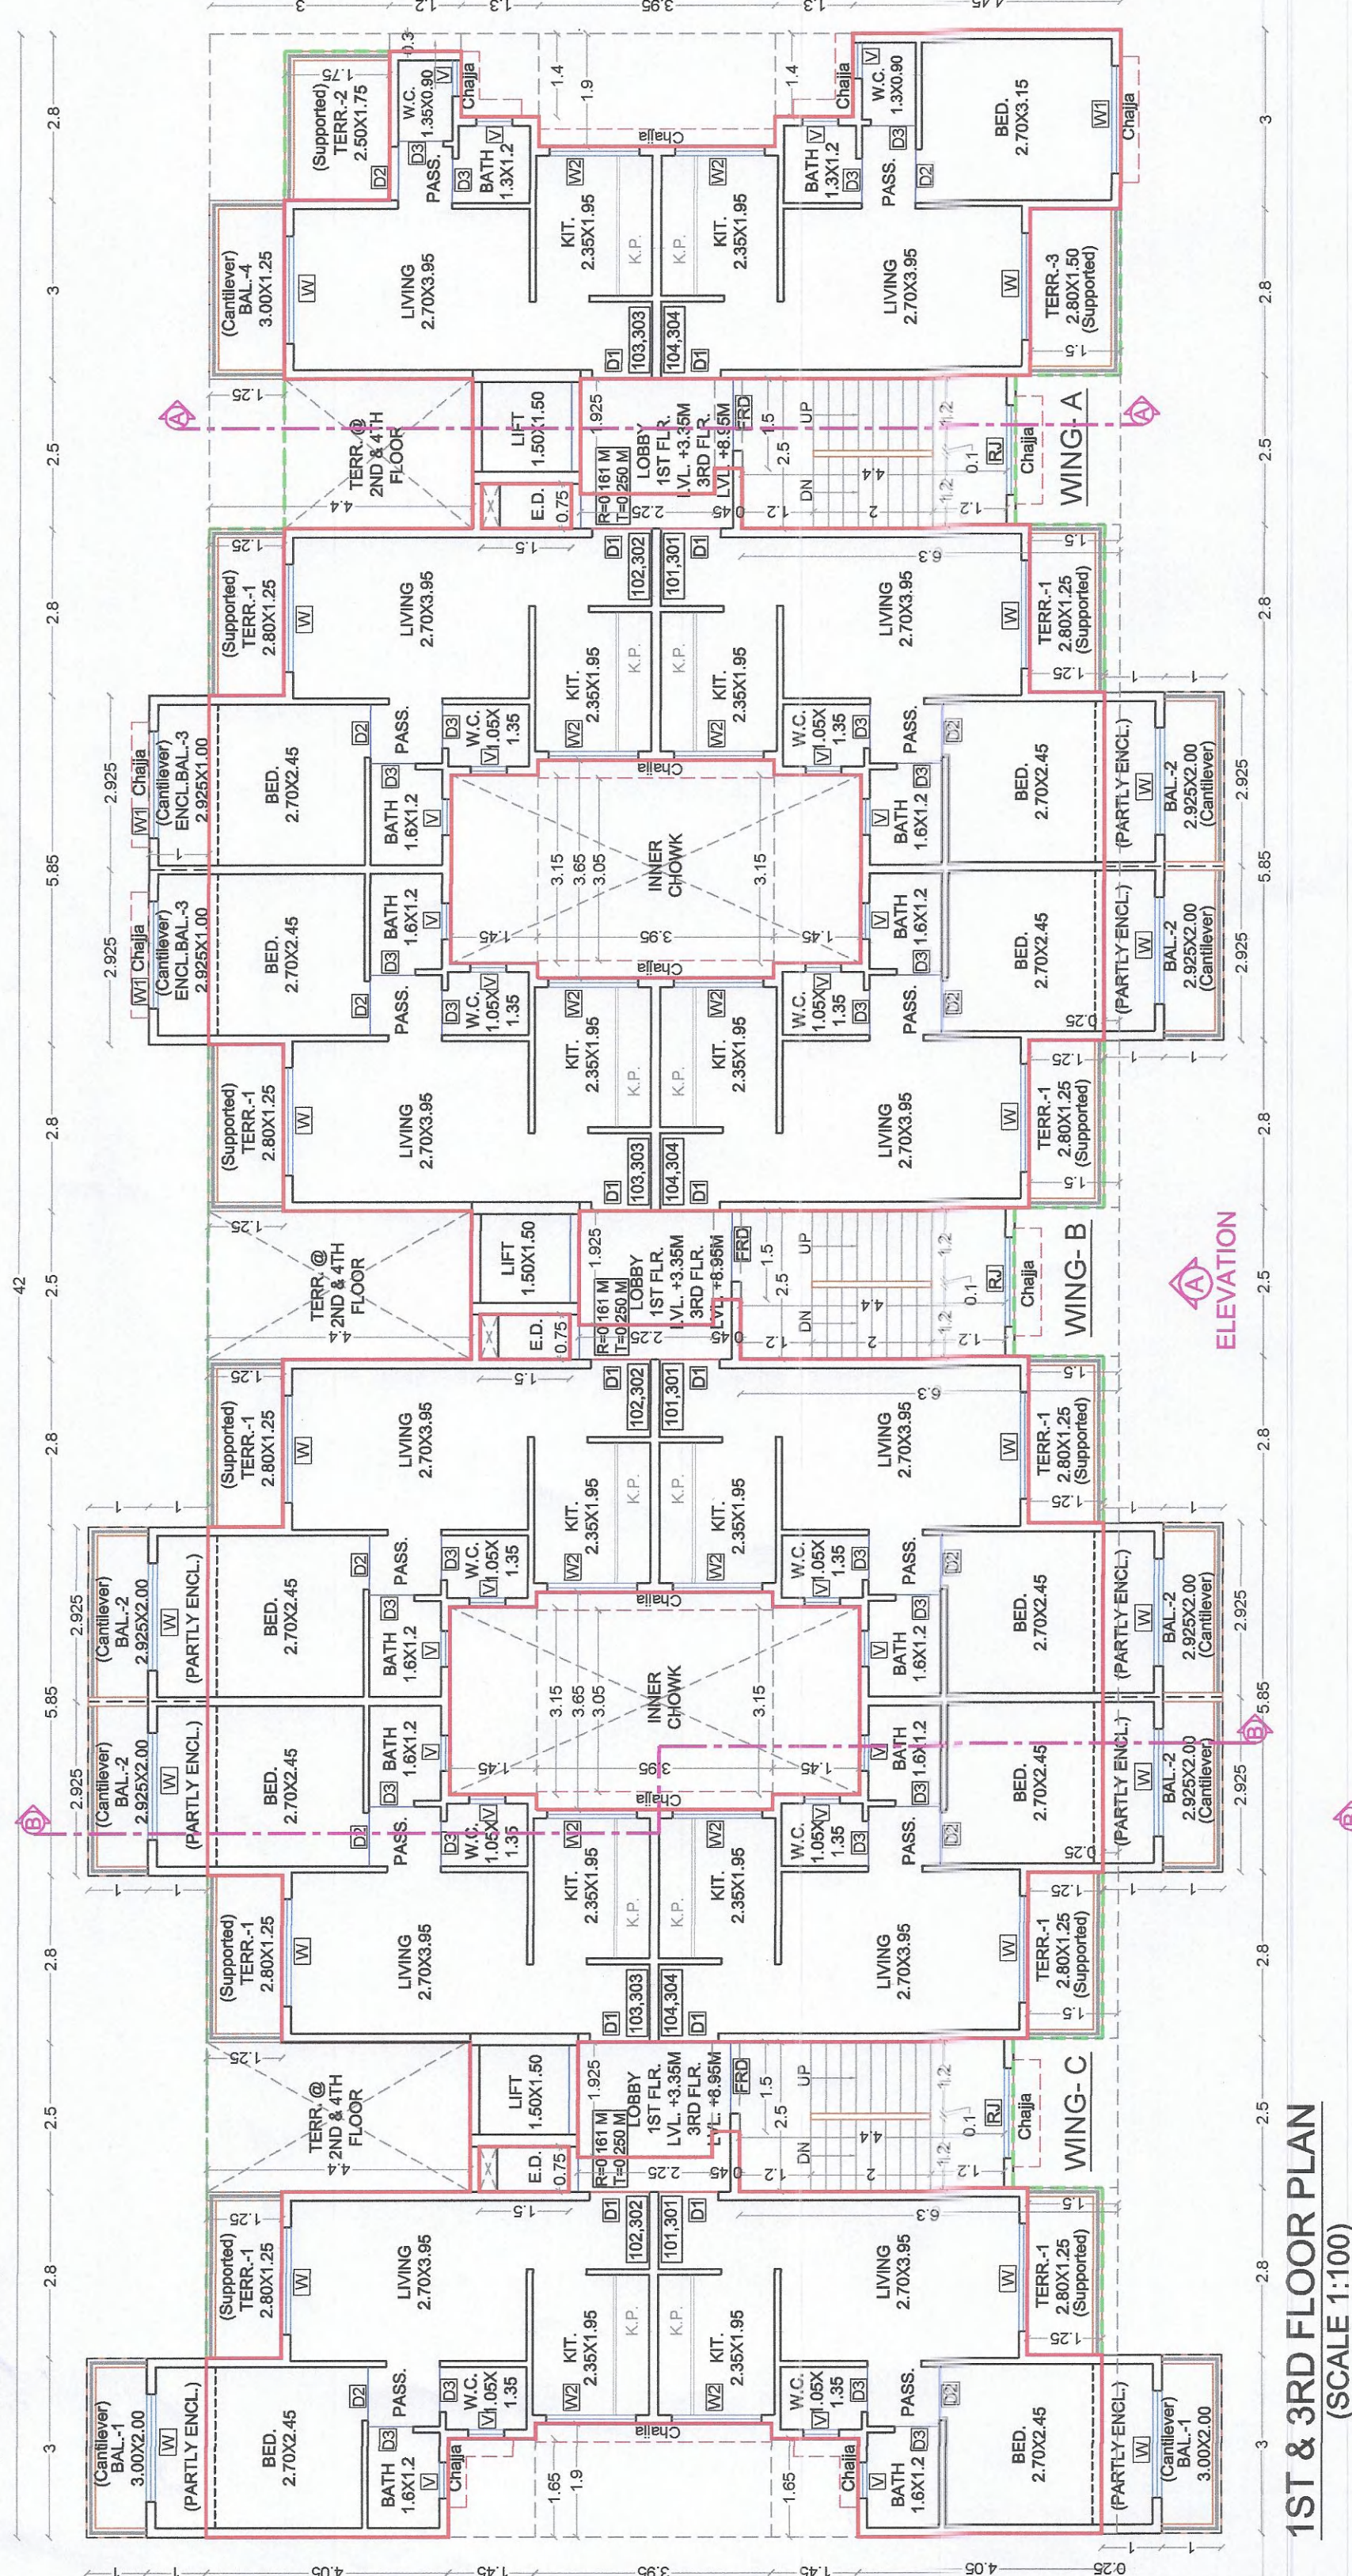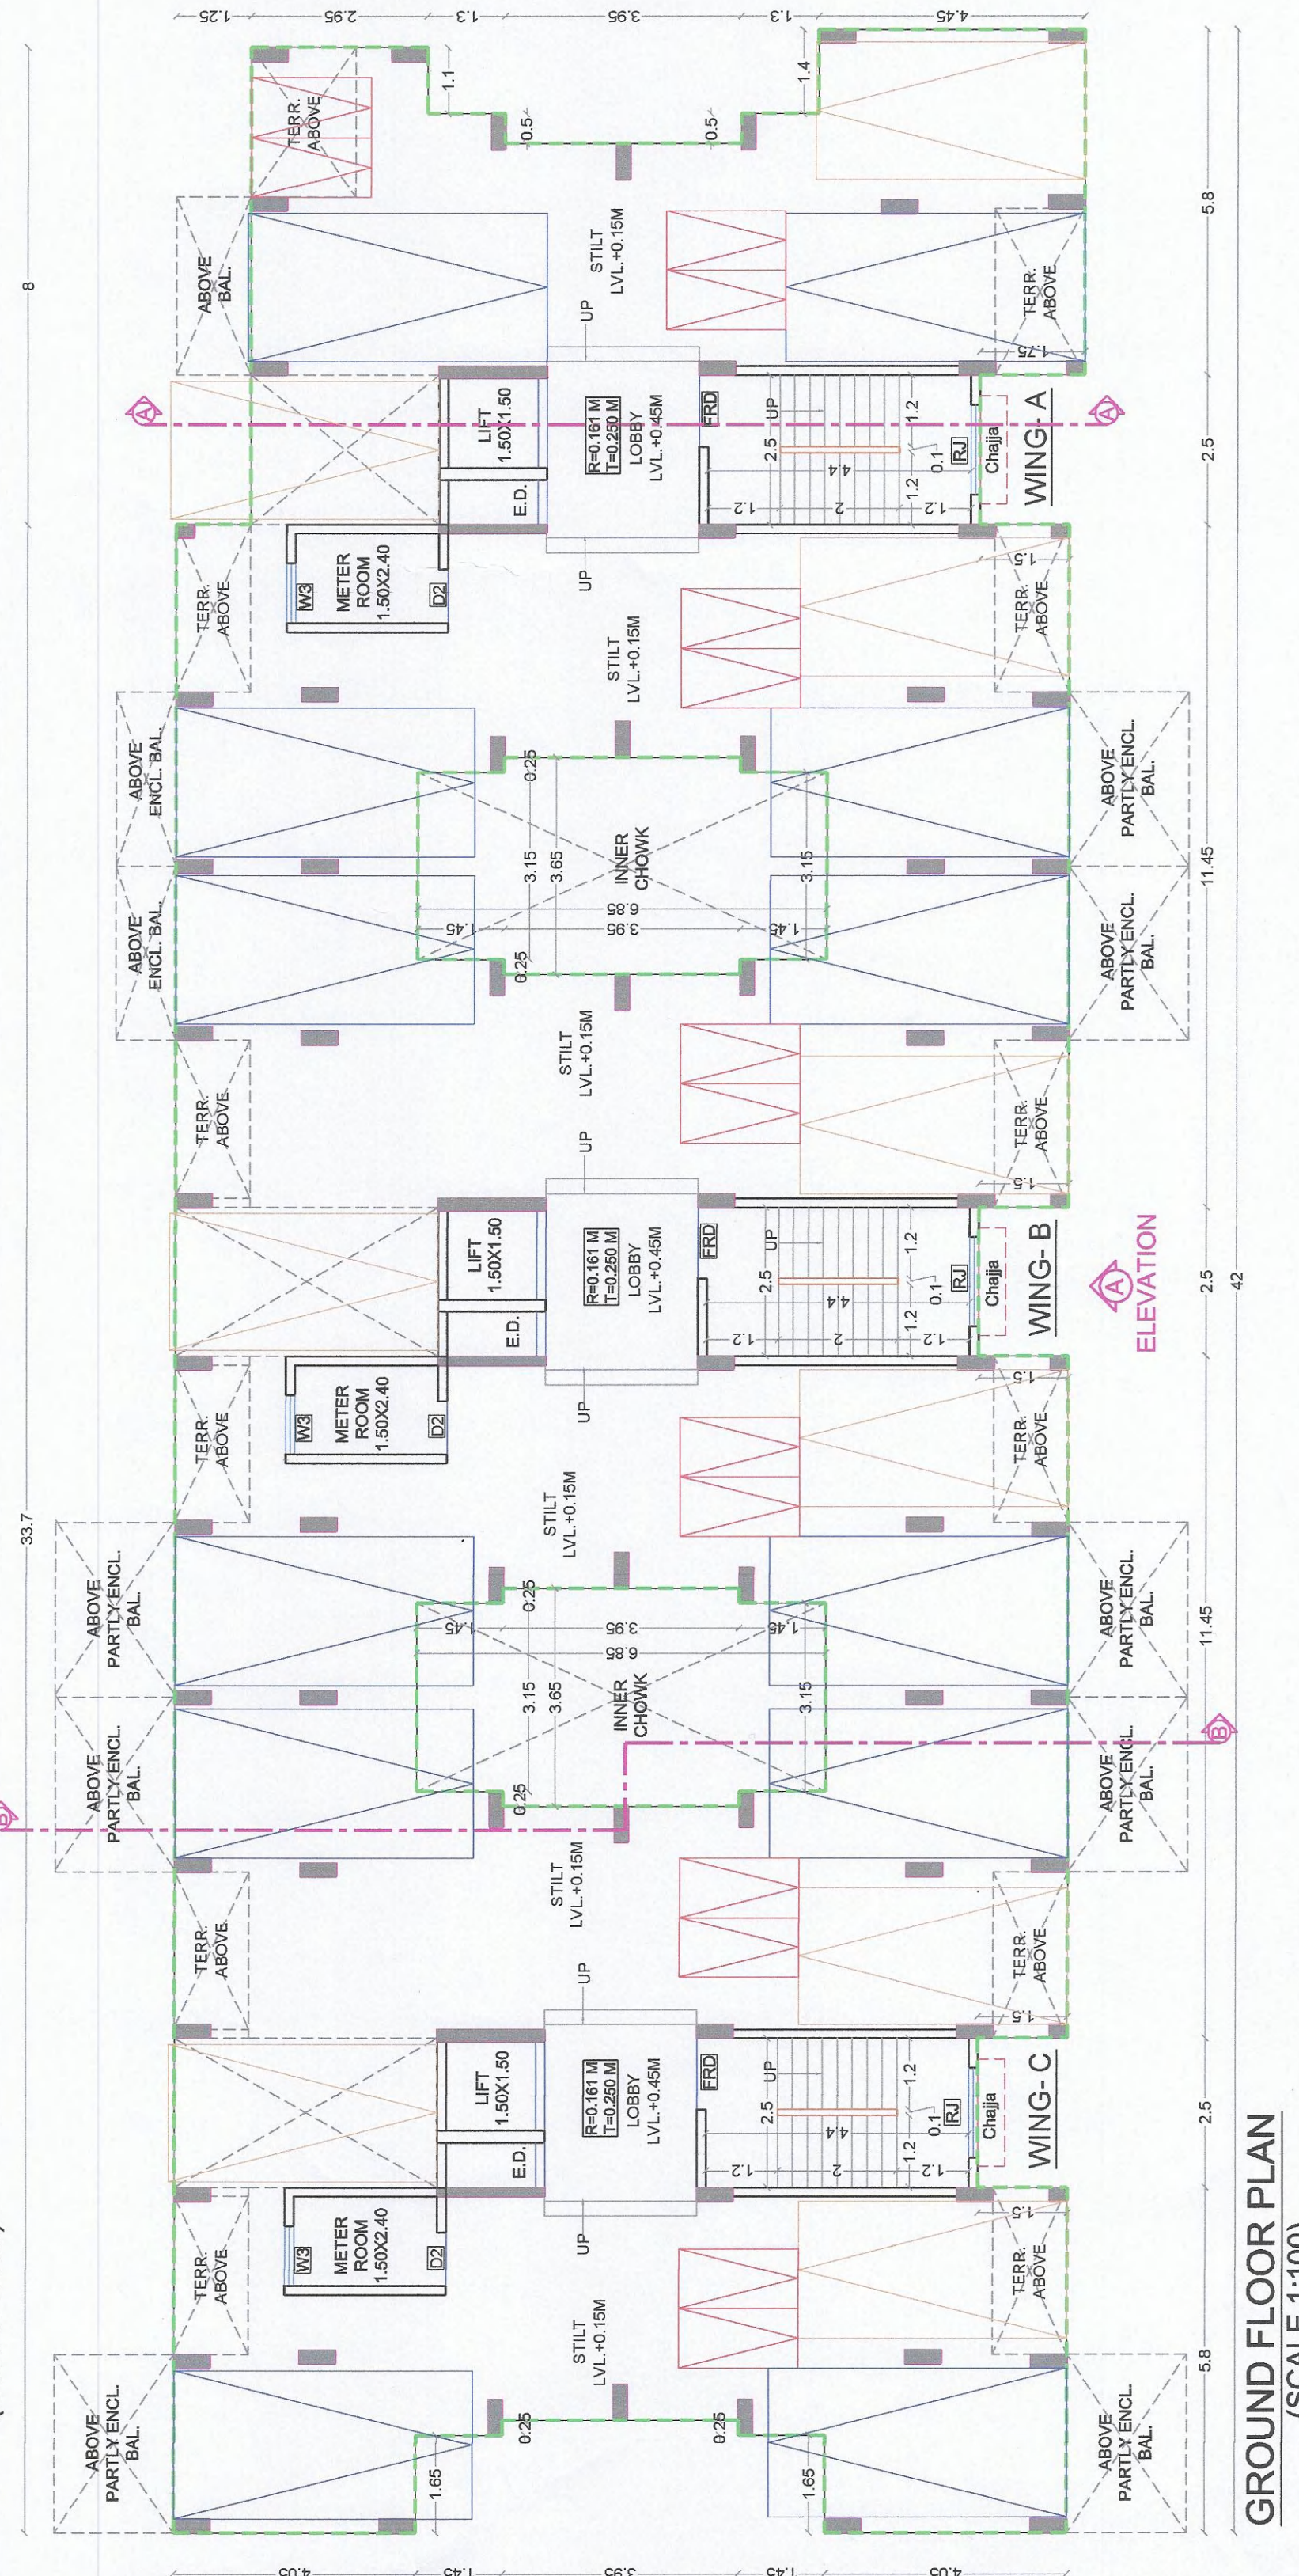Sr. No.	NUMBER	REDUCTION	BASE	HEIGHT	AREA	TOTAL ADDITION	TOTAL DEDUCTION	TOTAL EXCESS BALC.	TOTAL BALC. AREA
1	A	3	1	3.60	X	4.50	51.381		
2	1	5	1	0.35	X	1.80	3.594		
3	2	3	1	0.35	X	1.80	3.594		
4	3	3	1	0.35	X	1.80	3.594		
5	4	3	1	2.15	X	15.56	0.60		
6	5	3	1	1.75	X	2.50	4.671		
7	6	3	1	1.00	X	0.60	1.50		
8	7	3	1	0.25	X	0.60	0.450		
TOTAL DEDUCTION									25.40
TOTAL EXCESS BALC.									25.98


TYPICAL 1ST TO 3RD FLOOR AREA DIAGRAM & CALCULATION  
(SCALE 1:100)

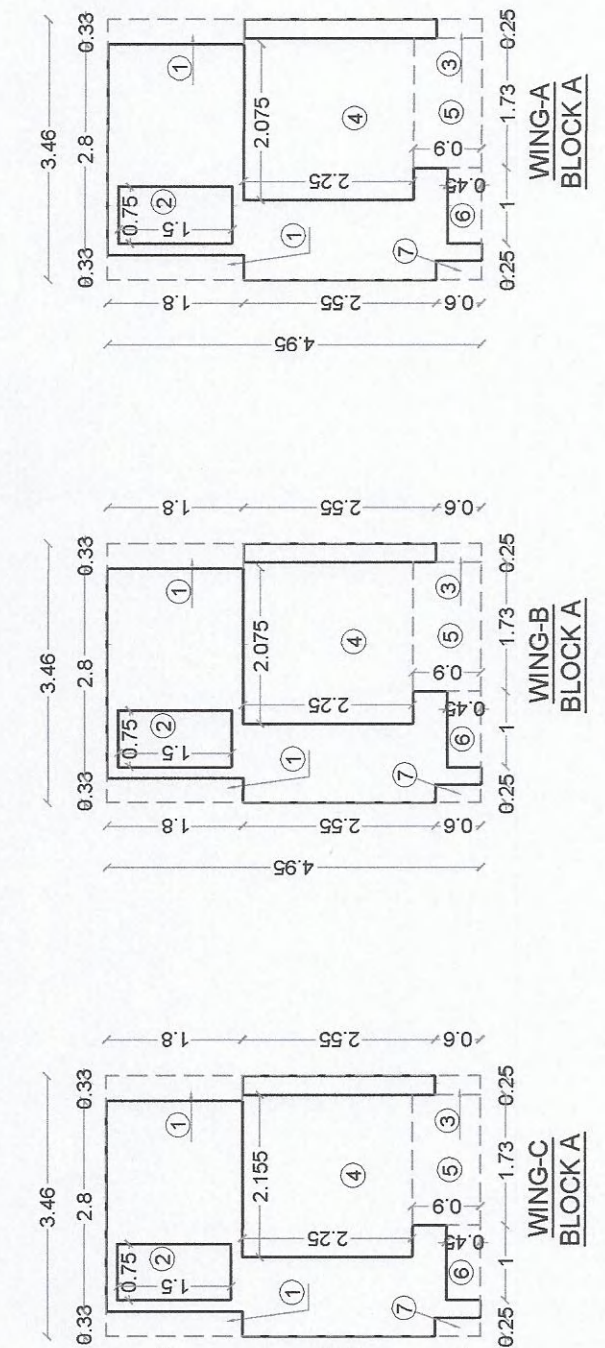Sr. No.	NUMBER	REDUCTION	BASE	HEIGHT	AREA	TOTAL ADDITION	TOTAL DEDUCTION	TOTAL EXCESS BALC.	TOTAL BALC. AREA
1	A	3	1	3.60	X	4.50	51.381		
2	1	5	1	0.35	X	1.80	3.594		
3	2	3	1	0.35	X	1.80	3.594		
4	3	3	1	0.35	X	1.80	3.594		
5	4	3	1	2.15	X	15.56	0.60		
6	5	3	1	1.75	X	2.50	4.671		
7	6	3	1	1.00	X	0.60	1.50		
8	7	3	1	0.25	X	0.60	0.450		
TOTAL DEDUCTION									25.40
TOTAL EXCESS BALC.									25.98


Sr. No.	NUMBER	REDUCTION	BASE	HEIGHT	AREA	TOTAL ADDITION	TOTAL DEDUCTION	TOTAL EXCESS BALC.	TOTAL BALC. AREA
1	A	3	1	3.60	X	4.50	51.381		
2	1	5	1	0.35	X	1.80	3.594		
3	2	3	1	0.35	X	1.80	3.594		
4	3	3	1	0.35	X	1.80	3.594		
5	4	3	1	2.15	X	15.56	0.60		
6	5	3	1	1.75	X	2.50	4.671		
7	6	3	1	1.00	X	0.60	1.50		
8	7	3	1	0.25	X	0.60	0.450		
TOTAL DEDUCTION									25.40
TOTAL EXCESS BALC.									25.98

METER ROOM AREA DIAGRAM & CALCULATION  
(SCALE 1:100)

Sr. No.	NUMBER	REDUCTION	BASE	HEIGHT	AREA	TOTAL ADDITION	TOTAL DEDUCTION	TOTAL EXCESS BALC.	TOTAL BALC. AREA
1	A	3	1	3.60	X	4.50	51.381		
2	1	5	1	0.35	X	1.80	3.594		
3	2	3	1	0.35	X	1.80	3.594		
4	3	3	1	0.35	X	1.80	3.594		
5	4	3	1	2.15	X	15.56	0.60		
6	5	3	1	1.75	X	2.50	4.671		
7	6	3	1	1.00	X	0.60	1.50		
8	7	3	1	0.25	X	0.60	0.450		
TOTAL DEDUCTION									25.40
TOTAL EXCESS BALC.									25.98

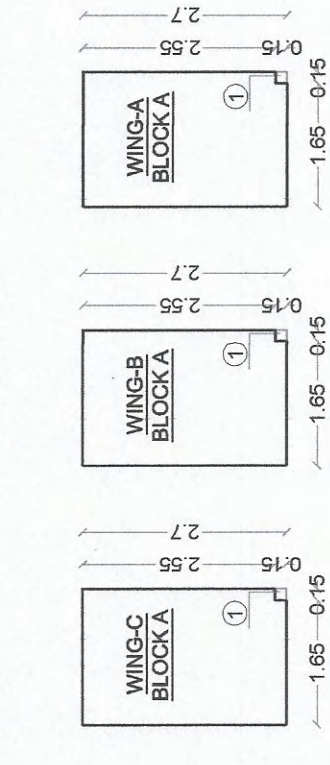


Sr. No.	NUMBER	REDUCTION	BASE	HEIGHT	AREA	TOTAL ADDITION	TOTAL DEDUCTION	TOTAL EXCESS BALC.	TOTAL BALC. AREA
1	A	3	1	3.60	X	4.50	51.381		
2	1	5	1	0.35	X	1.80	3.594		
3	2	3	1	0.35	X	1.80	3.594		
4	3	3	1	0.35	X	1.80	3.594		
5	4	3	1	2.15	X	15.56	0.60		
6	5	3	1	1.75	X	2.50	4.671		
7	6	3	1	1.00	X	0.60	1.50		
8	7	3	1	0.25	X	0.60	0.450		
TOTAL DEDUCTION									25.40
TOTAL EXCESS BALC.									25.98

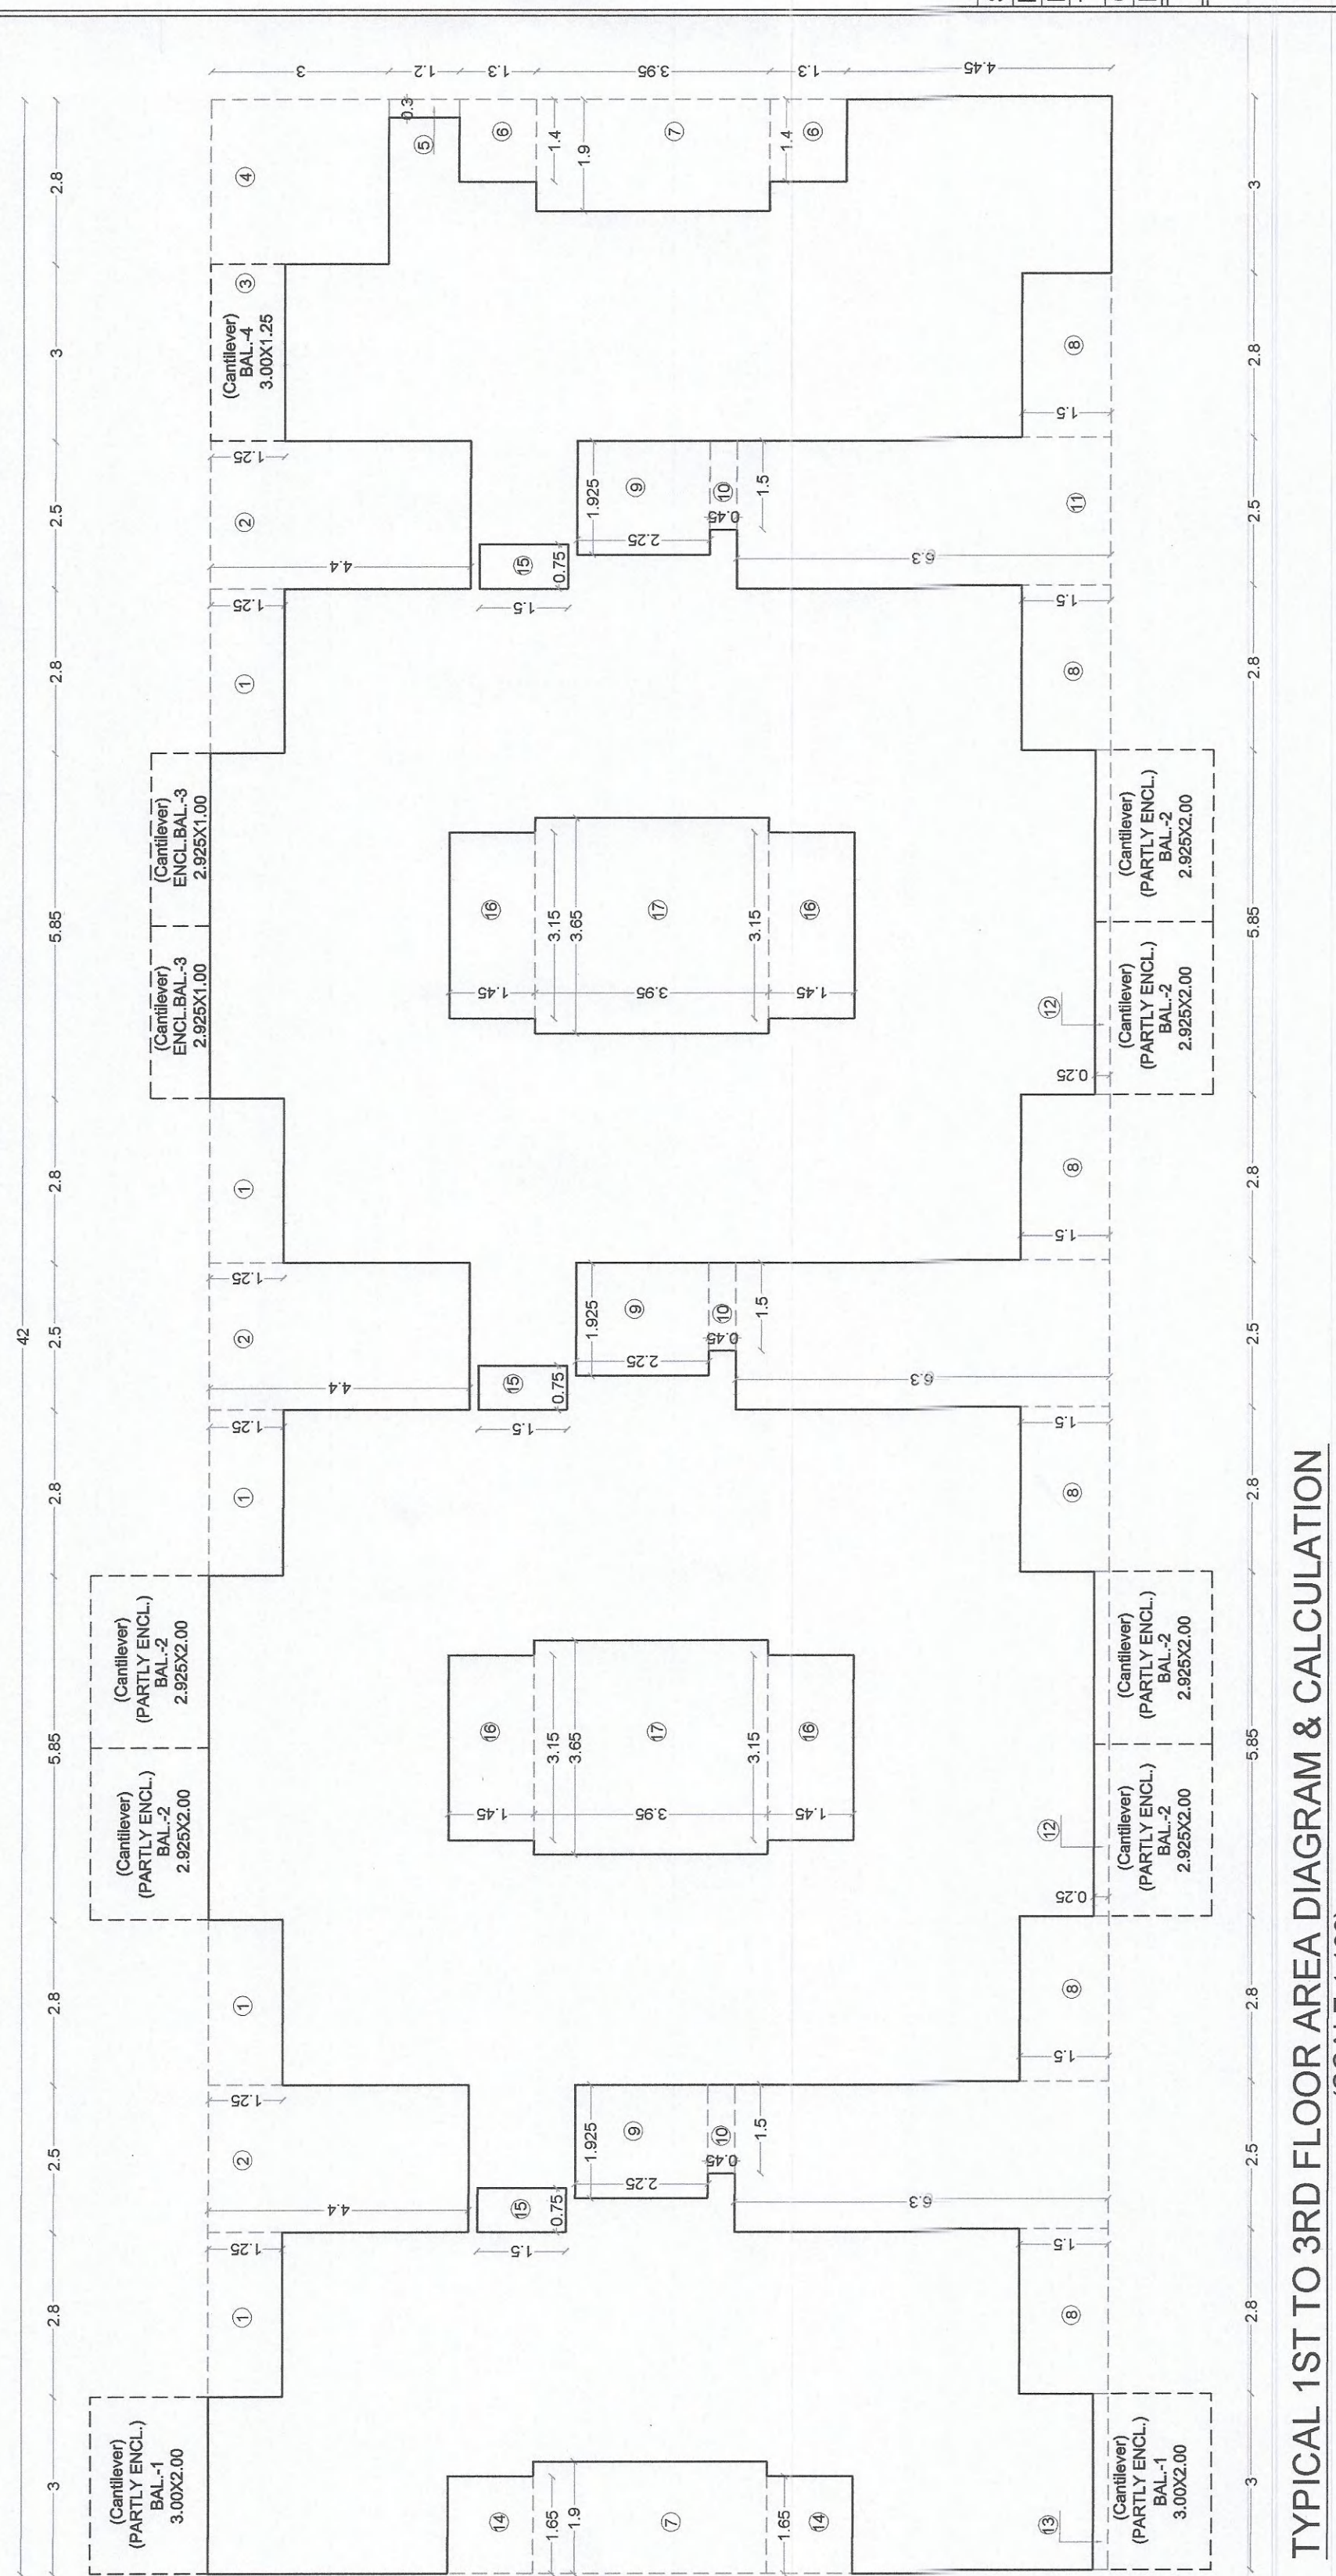
TYPICAL 1ST TO 3RD FLOOR AREA DIAGRAM & CALCULATION  
(SCALE 1:100)

Sr. No.	NUMBER	REDUCTION	BASE	HEIGHT	AREA	TOTAL ADDITION	TOTAL DEDUCTION	TOTAL EXCESS BALC.	TOTAL BALC. AREA
1	A	3	1	3.60	X	4.50	51.381		
2	1	5	1	0.35	X	1.80	3.594		
3	2	3	1	0.35	X	1.80	3.594		
4	3	3	1	0.35	X	1.80	3.594		
5	4	3	1	2.15	X	15.56	0.60		
6	5	3	1	1.75	X	2.50	4.671		
7	6	3	1	1.00	X	0.60	1.50		
8	7	3	1	0.25	X	0.60	0.450		
TOTAL DEDUCTION									25.40
TOTAL EXCESS BALC.									25.98

Sr. No.	NUMBER	REDUCTION	BASE	HEIGHT	AREA	TOTAL ADDITION	TOTAL DEDUCTION	TOTAL EXCESS BALC.	TOTAL BALC. AREA
1	A	3	1	3.60	X	4.50	51.381		
2	1	5	1	0.35	X	1.80	3.594		
3	2	3	1	0.35	X	1.80	3.594		
4	3	3	1	0.35	X	1.80	3.594		
5	4	3	1	2.15	X	15.56	0.60		
6	5	3	1	1.75	X	2.50	4.671		
7	6	3	1	1.00	X	0.60	1.50		
8	7	3	1	0.25	X	0.60	0.450		
TOTAL DEDUCTION									25.40
TOTAL EXCESS BALC.									25.98

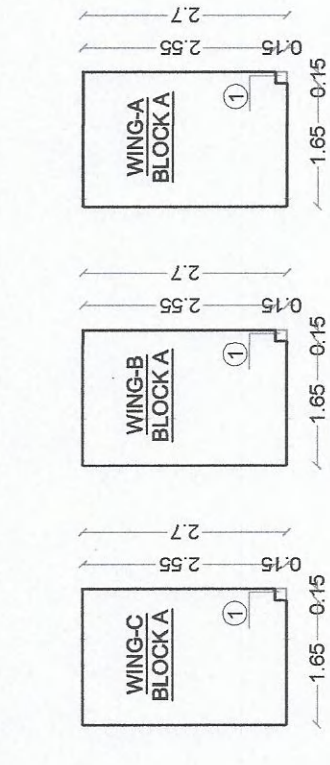
METER ROOM AREA DIAGRAM & CALCULATION  
(SCALE 1:100)

Sr. No.	NUMBER	REDUCTION	BASE	HEIGHT	AREA	TOTAL ADDITION	TOTAL DEDUCTION	TOTAL EXCESS BALC.	TOTAL BALC. AREA
1	A	3	1	3.60	X	4.50	51.381		
2	1	5	1	0.35	X	1.80	3.594		
3	2	3	1	0.35	X	1.80	3.594		
4	3	3	1	0.35	X	1.80	3.594		
5	4	3	1	2.15	X	15.56	0.60		
6	5	3	1	1.75	X	2.50	4.671		
7	6	3	1	1.00	X	0.60	1.50		
8	7	3	1	0.25	X	0.60	0.450		
TOTAL DEDUCTION									25.40
TOTAL EXCESS BALC.									25.98

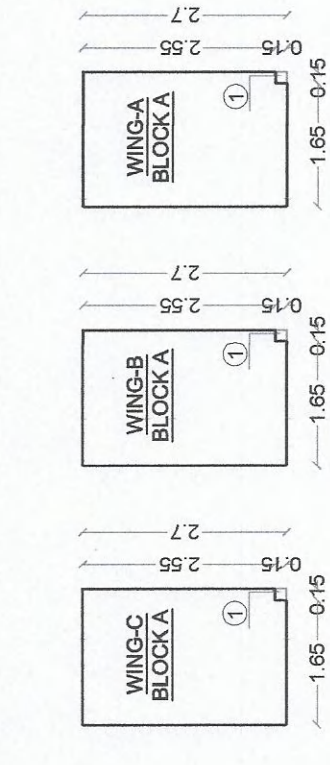
METER ROOM AREA DIAGRAM & CALCULATION  
(SCALE 1:100)




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TERRACE FLOOR PLAN  
(SCALE 1:100)

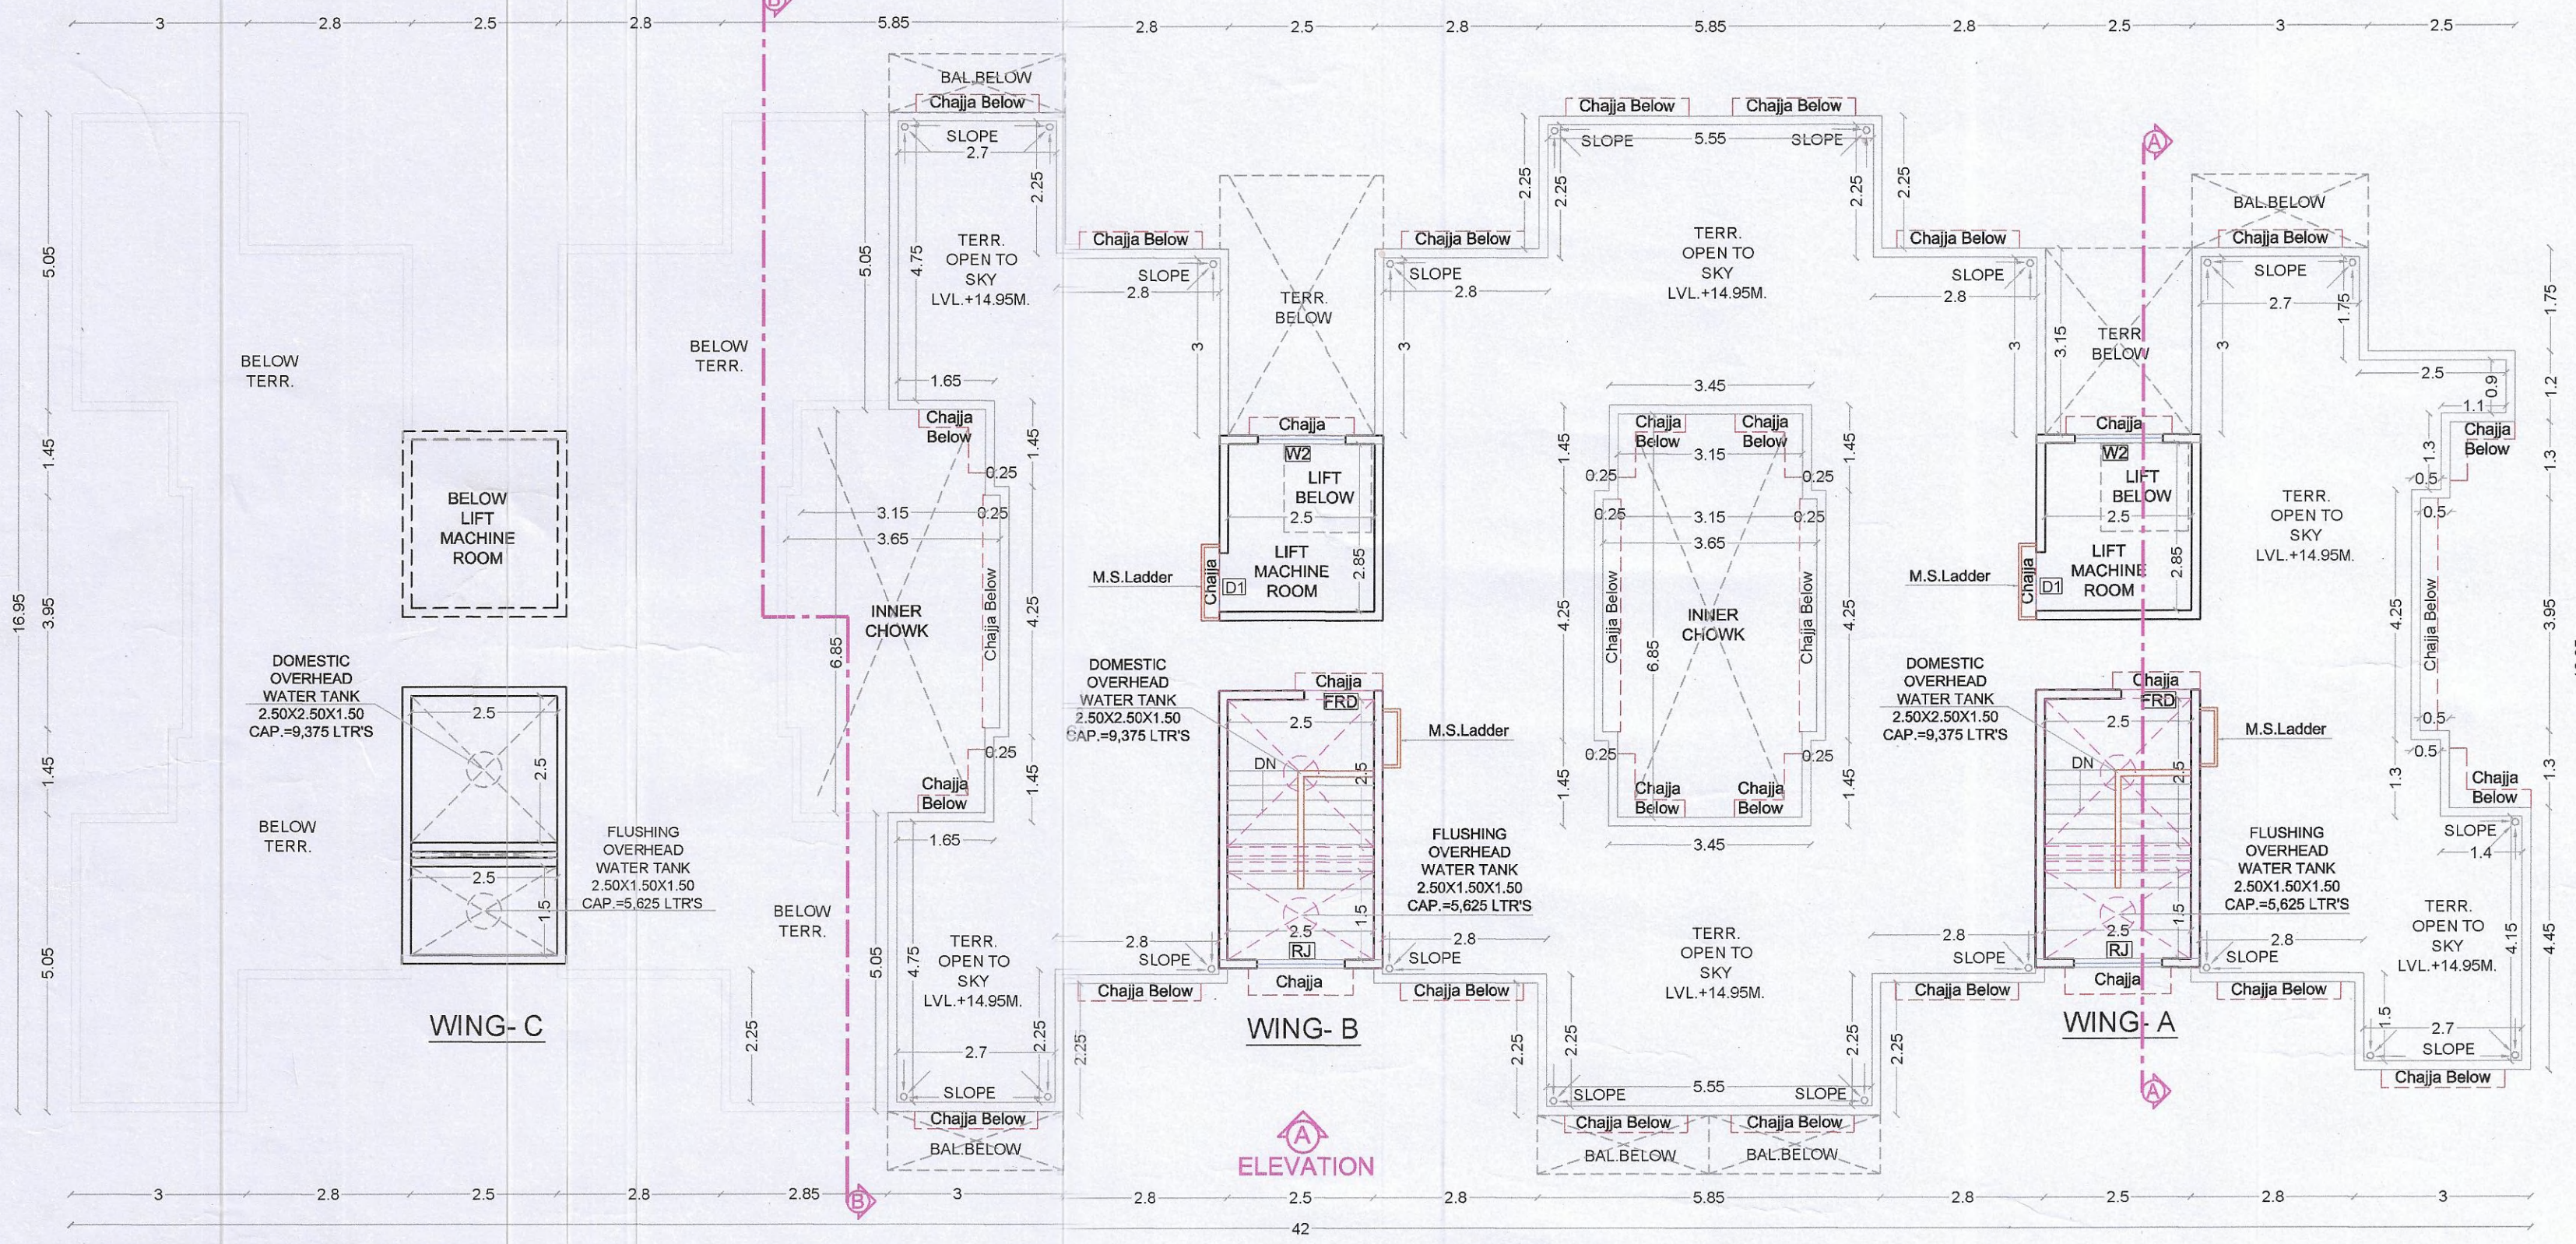

4TH FLOOR AREA DIAGRAM & CALCULATION  
(SCALE 1:100)

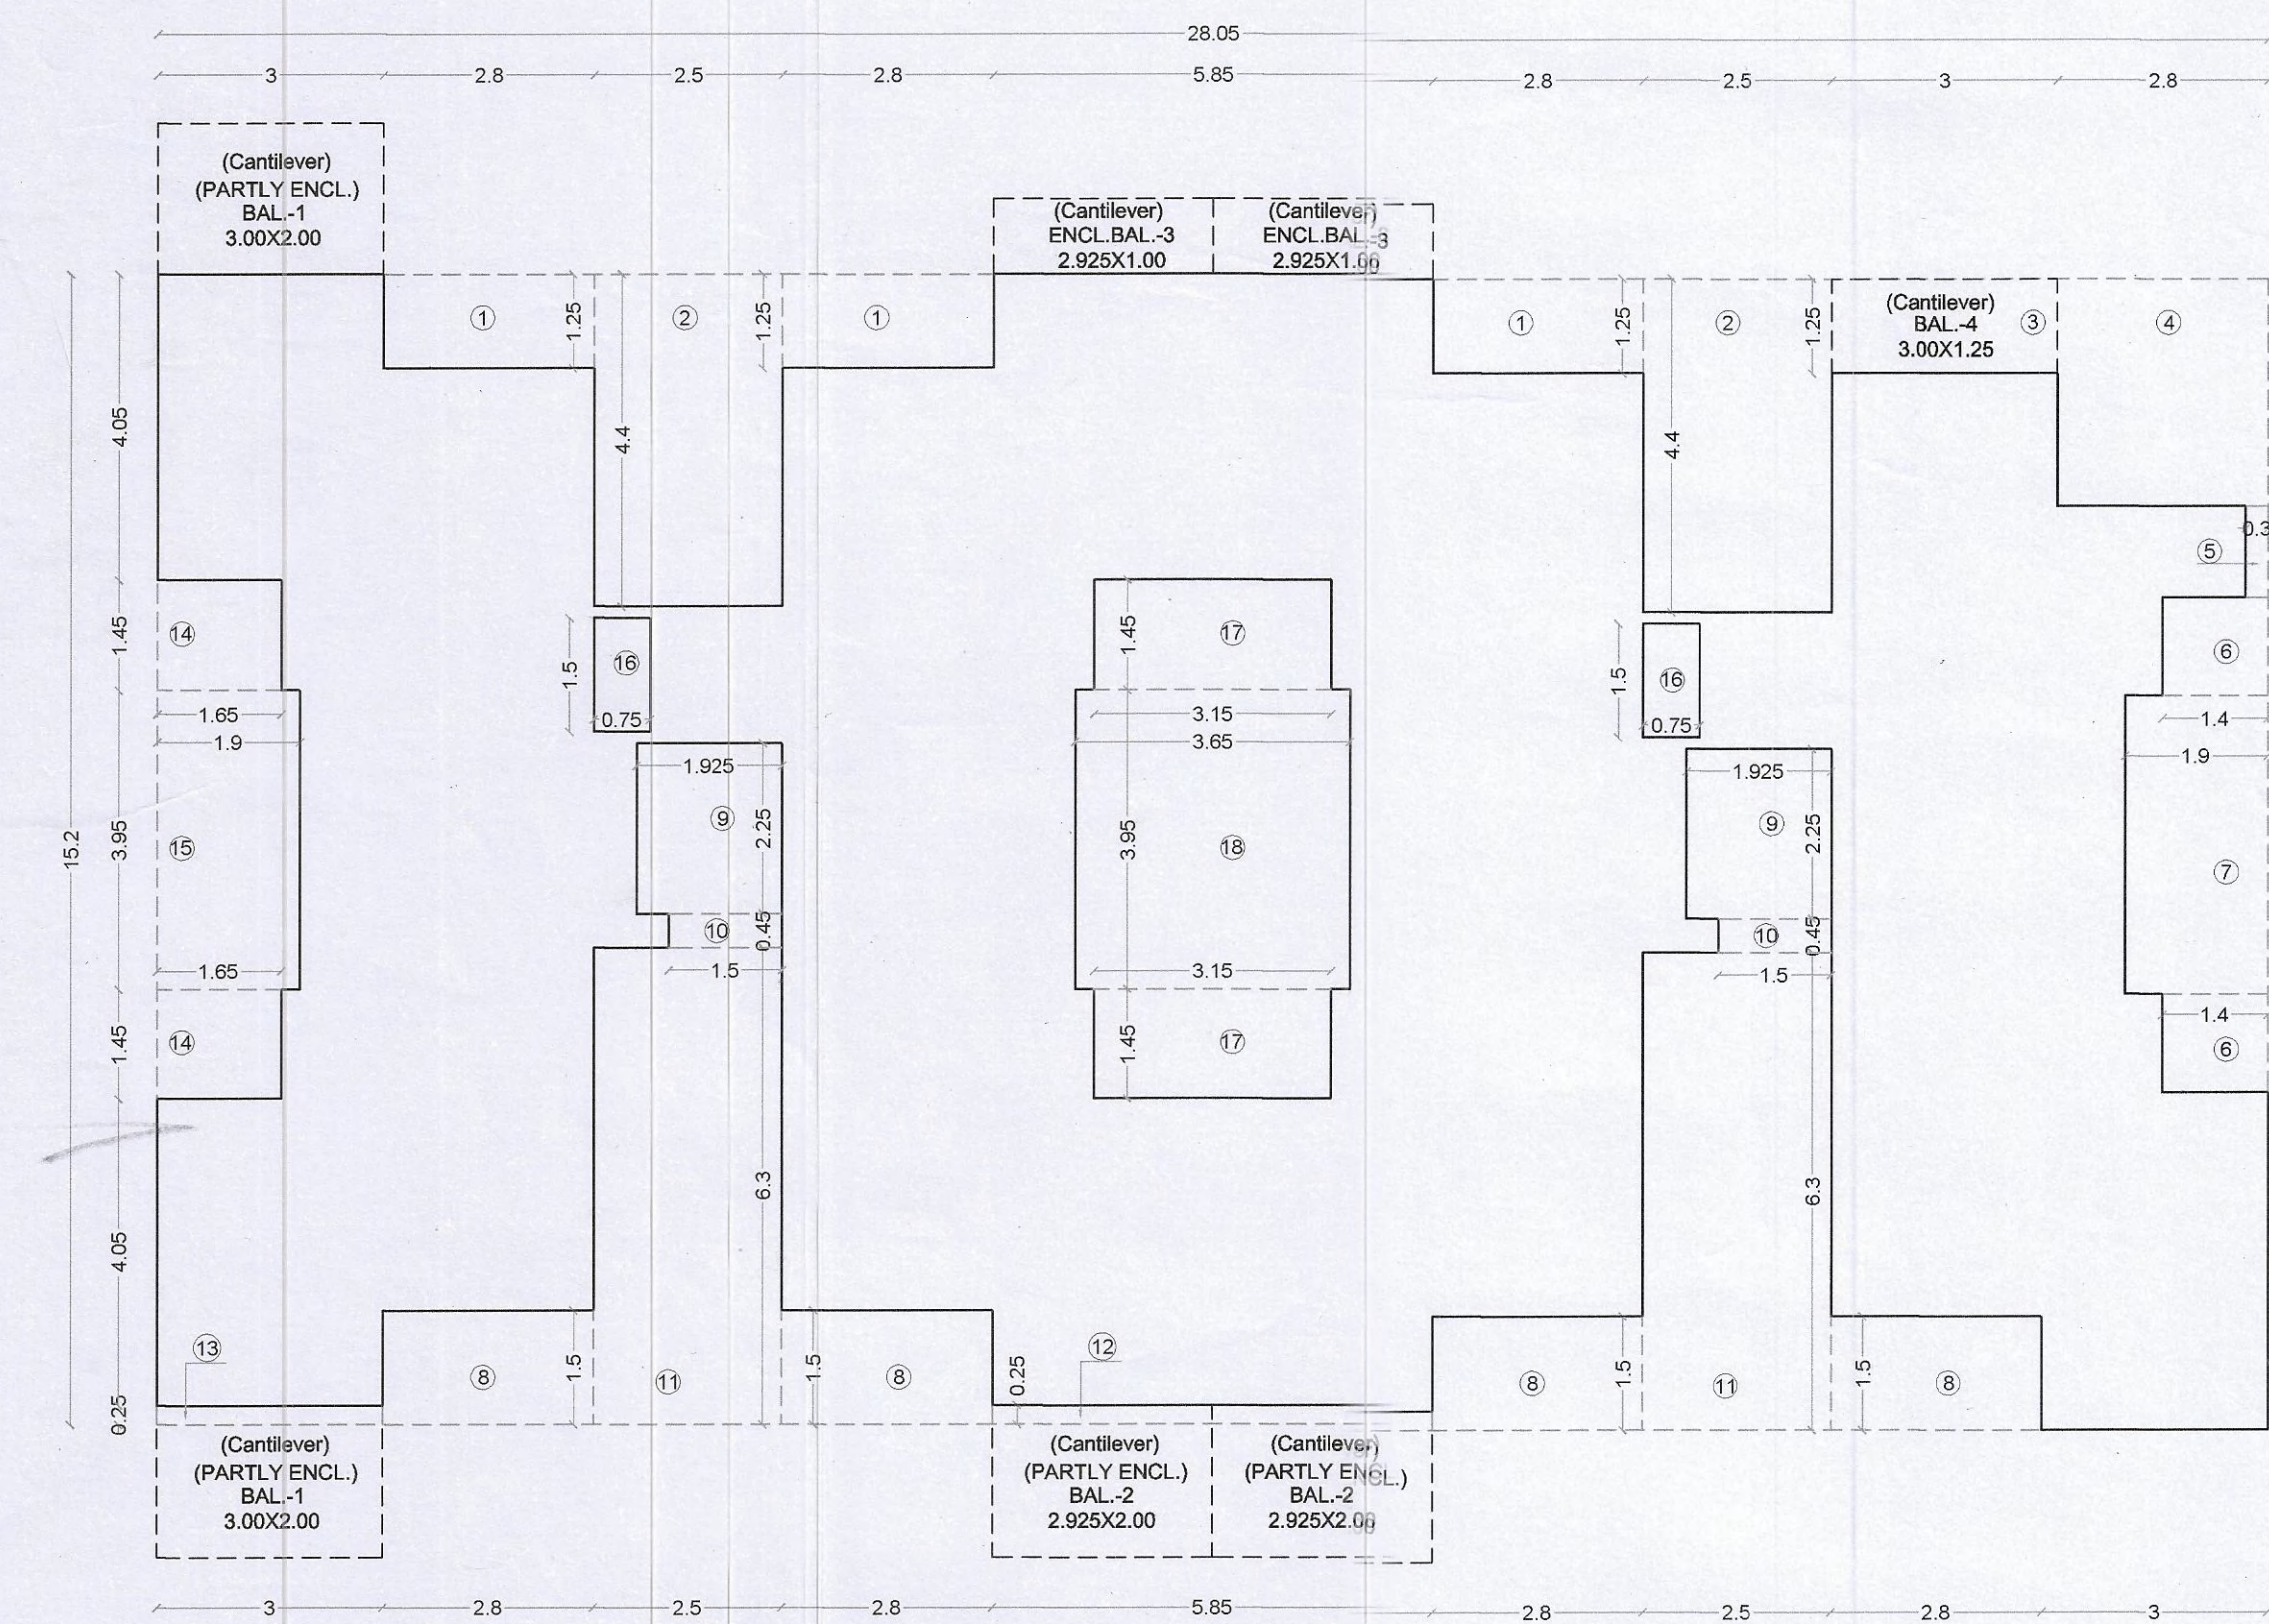

4TH FLOOR PLAN  
(SCALE 1:100)

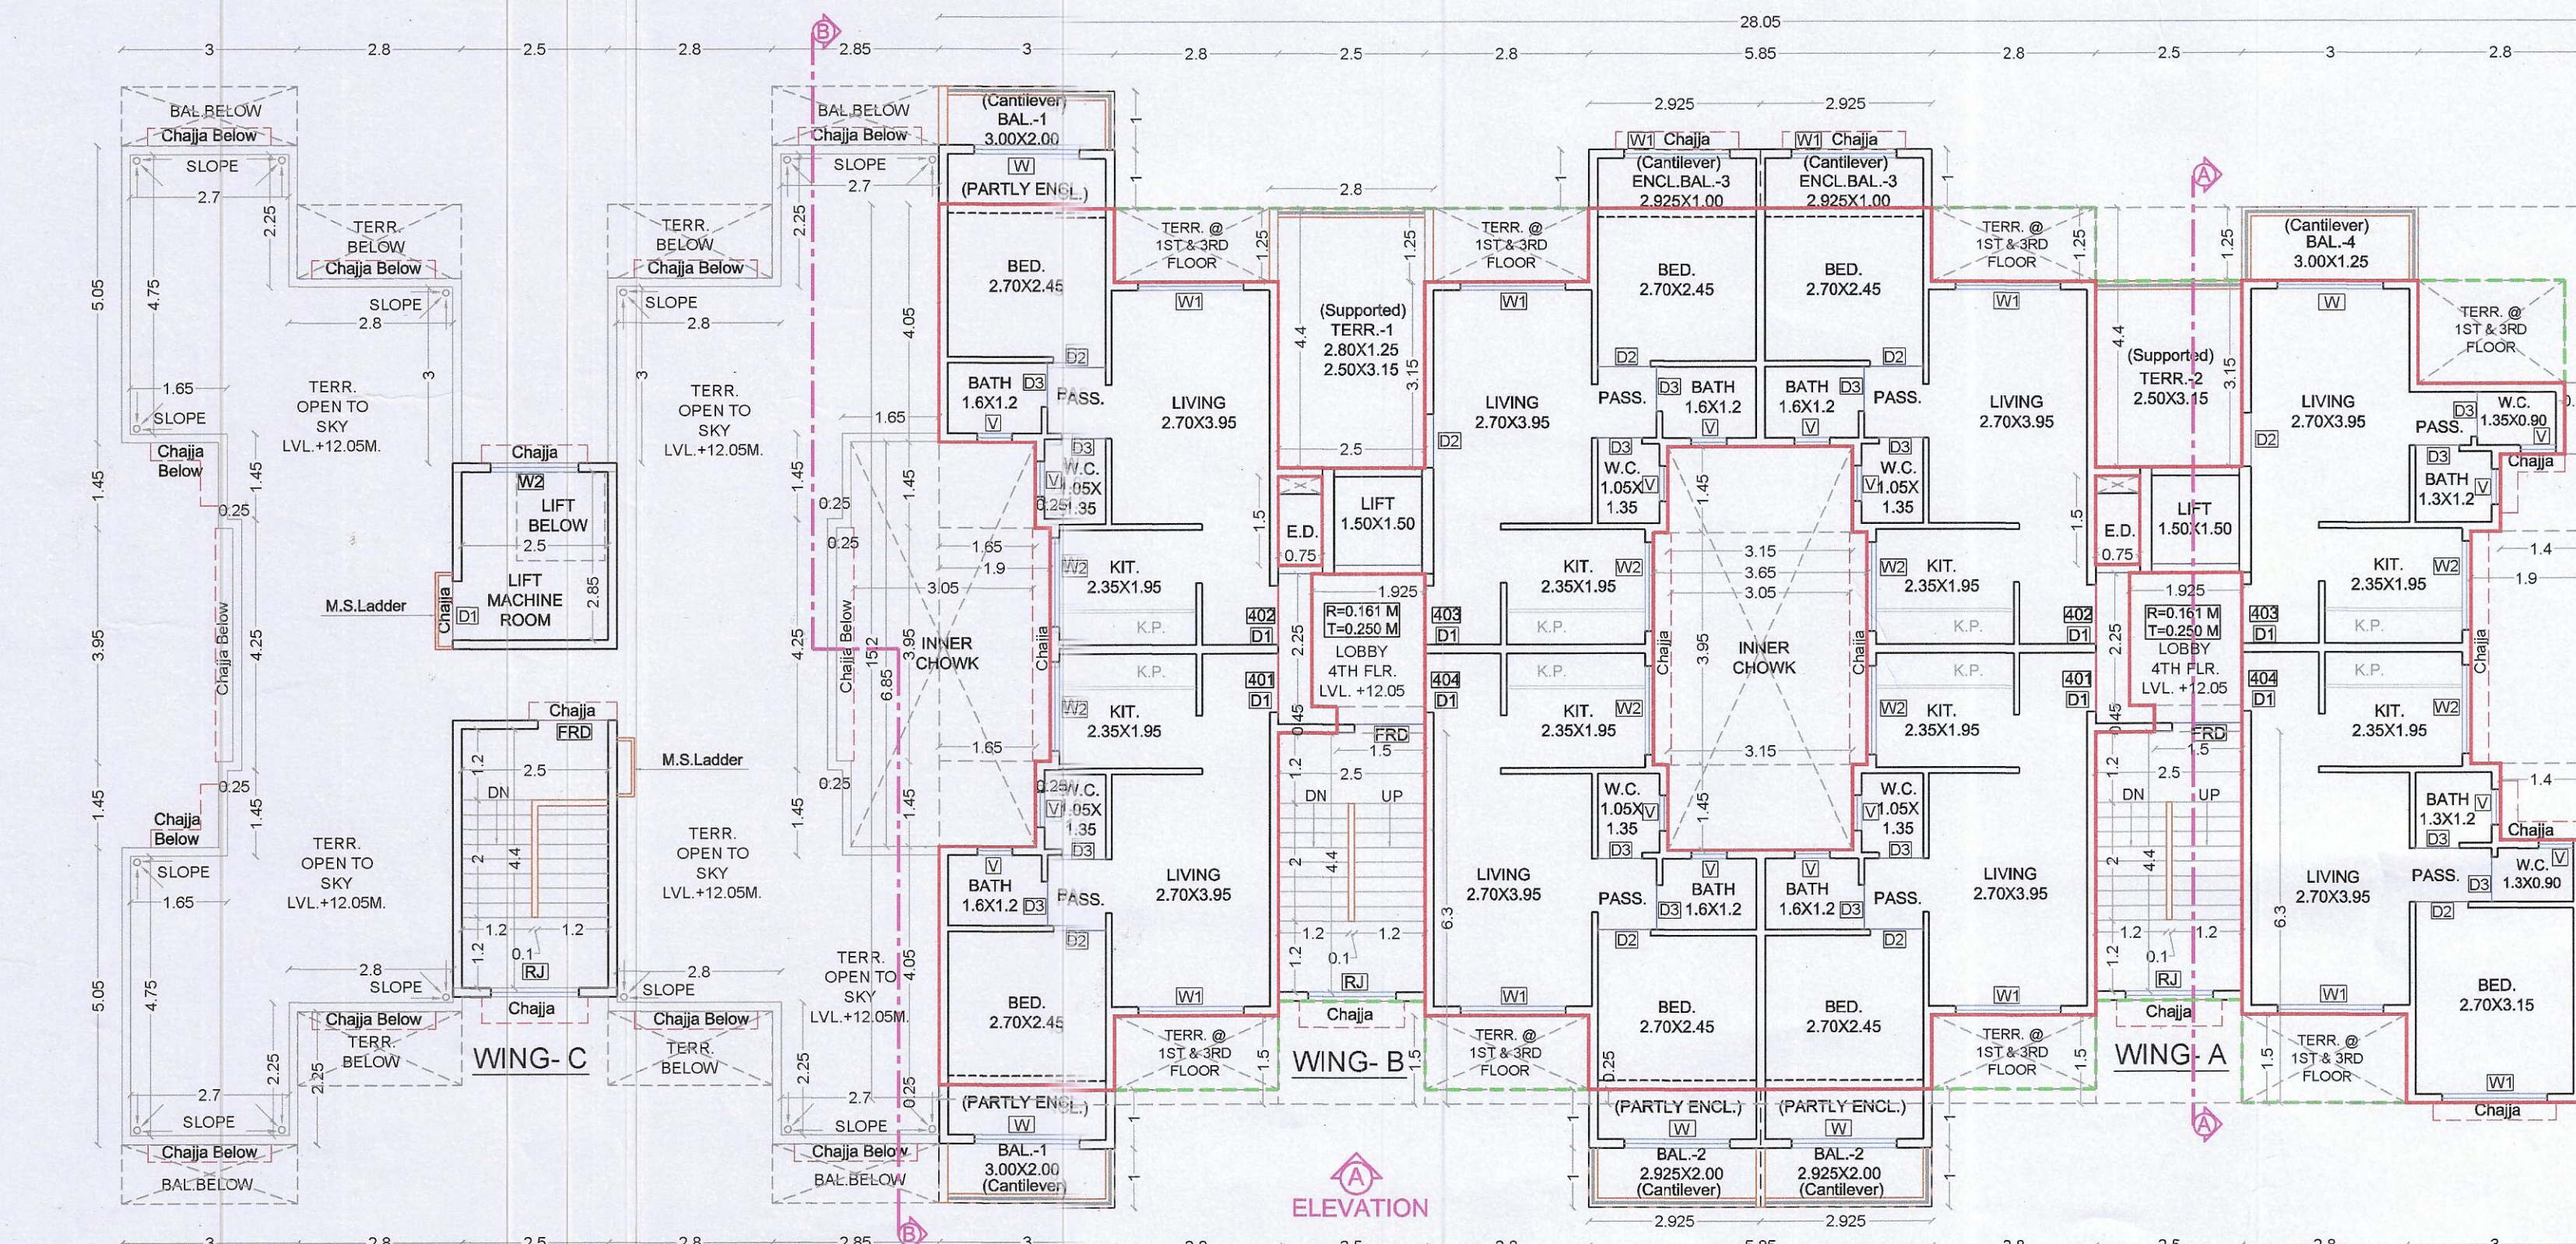TENEMENT AREA OF INDIVIDUAL UNIT						
WING NUMBER	FLAT NUMBER	UNITS	WING-A		TERRACE AREA (SQ.M.)	BUILT UP AREA (SQ.M.)
			CARPET AREA IN SQ.M.	BALCONY AREA ENCLOSED PROJECTED		
A	101	1	31.22	5.85	0.00	33.41
	102	1	31.22	2.93	0.00	33.41
	103	1	23.28	0.00	3.75	25.27
	104	1	32.10	0.00	0.00	35.03
	201	1	30.64	5.85	0.00	33.41
	202	1	30.64	2.93	0.00	33.41
	203	1	23.12	0.00	3.75	25.27
	204	1	31.48	0.00	0.00	35.03
	301	1	31.22	5.85	0.00	33.41
	302	1	31.22	2.93	0.00	33.41
	303	1	23.28	0.00	3.75	25.27
	304	1	32.10	0.00	0.00	35.03
	401	1	30.64	5.85	0.00	33.41
	402	1	30.64	2.93	0.00	33.41
	403	1	23.12	0.00	3.75	25.27
	404	1	31.48	0.00	0.00	35.03
TOTAL WING A			16	467.40	35.10	508.46

TENEMENT AREA OF INDIVIDUAL UNIT						
WING NUMBER	FLAT NUMBER	UNITS	WING-B		TERRACE AREA (SQ.M.)	BUILT UP AREA (SQ.M.)
			CARPET AREA IN SQ.M.	BALCONY AREA ENCLOSED PROJECTED		
B	101	1	31.22	5.85	0.00	33.41
	102	1	31.22	5.85	0.00	33.41
	103	1	31.22	2.93	0.00	33.41
	104	1	31.22	5.85	0.00	33.41
	201	1	30.64	5.85	0.00	33.41
	202	1	30.64	5.85	0.00	33.41
	203	1	31.09	2.93	0.00	33.41
	204	1	30.64	5.85	0.00	33.41
	301	1	31.22	5.85	0.00	33.41
	302	1	31.22	5.85	0.00	33.41
	303	1	31.22	2.93	0.00	33.41
	304	1	31.22	5.85	0.00	33.41
	401	1	30.64	6.00	0.00	33.71
	402	1	30.64	6.00	0.00	33.71
	403	1	31.09	2.93	0.00	33.41
	404	1	30.64	5.85	0.00	33.41
TOTAL WING B			16	495.78	82.20	535.10

TENEMENT AREA OF INDIVIDUAL UNIT						
WING NUMBER	FLAT NUMBER	UNITS	WING-C		TERRACE AREA (SQ.M.)	BUILT UP AREA (SQ.M.)
			CARPET AREA IN SQ.M.	BALCONY AREA ENCLOSED PROJECTED		
C	101	1	31.22	6.00	0.00	33.71
	102	1	31.22	6.00	0.00	33.71
	103	1	31.22	5.85	0.00	33.41
	104	1	31.22	5.85	0.00	33.41
	201	1	30.64	6.00	0.00	33.71
	202	1	31.09	6.00	0.00	33.71
	203	1	30.64	5.85	0.00	33.41
	204	1	30.64	5.85	0.00	33.41
	301	1	31.22	6.00	0.00	33.71
	302	1	31.22	6.00	0.00	33.71
	303	1	31.22	5.85	0.00	33.41
	304	1	31.22	5.85	0.00	33.41
	401	1	31.22	6.00	0.00	33.71
	402	1	31.22	6.00	0.00	33.71
	403	1	31.22	5.85	0.00	33.41
	404	1	31.22	5.85	0.00	33.41
TOTAL WING C			12	372.77	71.10	443.87
TOTAL WING A+B+C			44	1335.95	188.40	1524.35

SCHEDULE OF DOORS & WINDOWS						
TYPE	TENEMENT NUMBER	WIDTH (METER)	HEIGHT (METER)	AREA (SQ.M.)	SIL LEVEL (METER)	DESCRIPTION
(1)	(2)	(3)	(4)	(5)	(6)	(7)
D1	100	2.100	2.100	4.41	0.000	T.W. FRAMED PANEL DOOR
D2	100	2.100	2.100	4.41	0.000	T.W. FRAMED PANEL DOOR
D3	0.900	2.100	1.800	1.62	0.000	T.W. FRAMED PANEL DOOR
D4	0.750	2.100	1.575	1.18	0.000	T.W. FRAMED PANEL DOOR
W1	1.800	2.150	3.870	7.16	0.150	ALUMINIUM SLIDING WINDOW
W2	1.800	1.400	2.520	4.54	0.000	ALUMINIUM SLIDING WINDOW
W3	1.500	1.400	2.100	3.15	0.000	ALUMINIUM SLIDING WINDOW
W4	1.000	1.400	1.400	1.40	0.000	ALUMINIUM SLIDING WINDOW
V	0.600	0.750	0.450	0.27	1.550	ALUMINIUM LOUVERED WINDOW
R	1.500	1.400	2.100	3.15	0.000	R.C.C. JALI

SCHEDULE OF LIGHT & VENTILATION					
ROOM	TENEMENT NUMBER	CARPET AREA	WINDOW TYPE	L&V REQUIRED	L & V PROVIDED
(1)	(2)	(3)	(4)	(5)	(6)
LIVING	101	10.665	W W1	1.778	3.870 2.520
BED.	101	6.615	W	1.103	3.870
KITCHEN	101	4.582	W2	1.000	2.100
W.C.	101	1.417	V	0.236	0.450
BATH	102	1.920	V	0.320	0.450

4TH FLOOR BUILT UP AREA CALCULATION						
Sr. No.	NUMBER	NUMBER OF DEDUCTION	1/2	BASE (M)	HEIGHT (M)	AREA (SQ.M.)
(1)	(2)	(3)	(4)	(5)	(6)	(7) = (3)X(4)X(5)
1	A	1	1	28.050	X	15.200
TOTAL ADDITION						426.360
2	1	3	1	2.800	X	1.250
3	2	2	1	2.500	X	4.400
4	3	1	1	3.000	X	1.250
5	4	1	1	2.800	X	3.000
6	5	1	1	0.300	X	1.200
7	6	2	1	1.400	X	1.300
8	7	1	1	1.900	X	3.950
9	8	4	1	2.800	X	15.500
10	9	2	1	1.925	X	2.250
11	10	2	1	1.500	X	0.450
12	11	2	1	2.500	X	6.300
13	12	1	1	5.850	X	0.250
14	13	1	1	3.000	X	0.250
15	14	2	1	1.650	X	1.450
16	15	1	1	1.900	X	3.950
17	16	2	1	0.750	X	1.500
18	17	2	1	3.150	X	1.450
19	18	1	1	3.650	X	3.950
TOTAL DEDUCTION						154.770
TOTAL NET BUILT UP AREA 4TH FLOOR						271.59

BALCONY AREA STATEMENT						
4TH FLOOR PLAN						
BALCONY TYPE	Number of Balcony	Length (Meter)	Breadth (Meter)	Area in Sq. M.		
(1)	(2)	(3)	(4)	(5) = (2)X(3)X(4)	(6) = (2)X(3)X(4)	(7) = (2)X(3)X(4)
B1	2	3.000	2.000	= 0.000	12.000	
B2	2	2.925	2.000	= 0.000	11.700	
B3	2	2.925	1.000	= 0.000	5.850	
B4	1	3.000	1.250	= 3.750	0.000	
SUBTOTAL =				3.75	29.55	
Total Proposed Balcony Area = (5) + (6) + (7)					33.30	
NET B.U.A. OF FLOOR =					271.59	
Permissible Balcony Area (Net Built Up Area) X 15% =					40.74	
Balance Balcony Area, if any =					7.44	
Excess Balcony Area, if any =					0.00	
Proposed Balcony Area On 4th Floor =					33.30	

TERRACE AREA STATEMENT						
4TH FLOOR PLAN						
TERRACE TYPE	Number of Terrace	Length (Meter)	Breadth (Meter)	Area in Sq. M.		
(1)	(2)	(3)	(4)	(5) = (2)X(3)X(4)	(6) = (2)X(3)X(4)	(7) = (2)X(3)X(4)
T1	1	2.800	1.250	=	11.375	
T2	1	2.500	3.150	=	7.875	
SUBTOTAL =					19.25	
Total Proposed Terrace Area = (4) + (5) + (6) + (7)					271.59	
NET B.U.A. OF FLOOR =					271.59	
Permissible Terrace Area (Net Built Up Area) X 20% =					54.32	
Balance Terrace Area, if any =					35.07	
Excess Terrace Area, if any =					NIL	
Proposed Terrace Area On 4th Floor =					19.25	

## SPECIFICATIONS

External wall thk	0.15M
Internal wall thk	0.10M

## TOTAL NO. OF UNITS

COMMERCIAL UNITS	00
RESIDENTIAL UNITS	44

## SHEET CONTENT

4TH FLOOR PLAN,  
TERRACE FLOOR PLAN,  
BUILT UP AREA DIAGRAM & CALCULATION,  
BALCONY AREA STATEMENT,  
TERRACE AREA STATEMENT,  
TENEMENT AREA STATEMENT,  
SCHEDULE OF DOOR & WINDOW,  
SCHEDULE OF LIGHT & VENTILATION.

## NAME OF THE OWNER &amp; SIGNATURE

Rajendra J. Gandhi

## DESCRIPTION OF PROPOSAL &amp; PROPERTY

PROPOSED RESIDENTIAL BUILDING ON LAND BEARING SURVEY No. 71/2 AT VILLAGE - KEVALE, TAL - PANVEL, DIST - RAIGAD.

## ARCHITECT NAME &amp; SIGN

NEHA JAIN  
REG NO : CA/2006/0003

DATE 26-02-2020

DRAWN BY Rajeshree

CHKD. BY Gharat

SCALE 1:100

NORTH

AN.ARCH ARCHITECT & PLANNERS

Office no.20/21-Raheja Arcade, Sec-11,Plot no.61,CBD Belapur-400614.

contact no.022-27562410, mail id-anarch.architect@gmail.com







Approved subject to the condition mentioned in this office letter no. CIDCO/NAINA/Panvel/Kevale/ BP-00517/CC/2021/0080 Dated: 16 Apr 2021

## SHEET CONTENT

GROUND FLOOR PLAN,  
ELEVATION & SECTIONS,  
BUILT UP AREA DIAGRAM & CALCULATION,  
SCHEDULE OF DOOR & WINDOW,  
SCHEDULE OF LIGHT & VENTILATION.

## SPECIFICATIONS

External wall thk	0.15M
Internal wall thk	0.10M

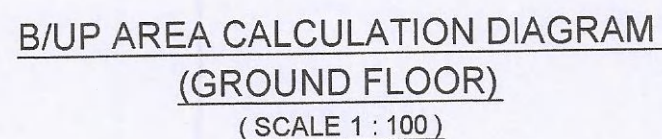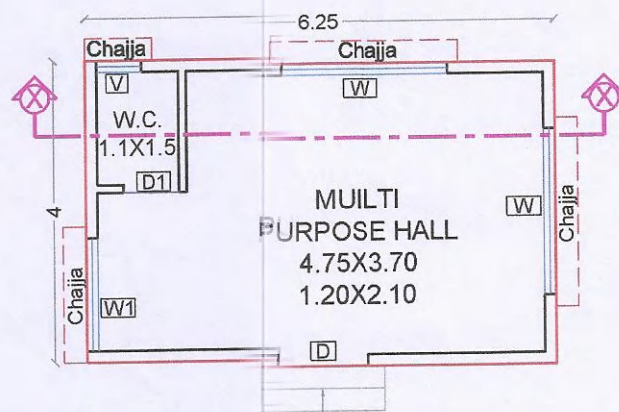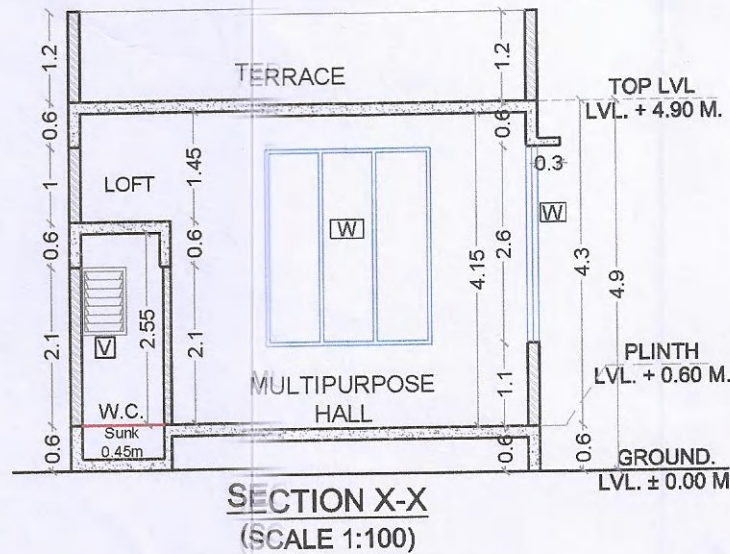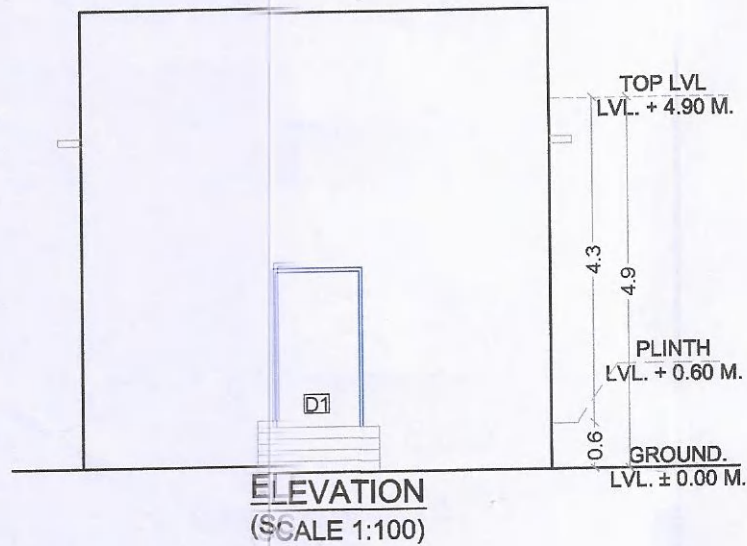

	RECREATIONAL OPEN SPACE AREA STATEMENT	Area Sq.M.
1	Permissible Recreational Open Space Area	250.000
2	Proposed Recreational Open Space Area	254.448
Permissible Structure In Recreational Open Space = (15%) Of		37.500
3	a Allowed On Ground Floor 10%	25.000
	b Allowed On 1st Floor 5%	12.500
Total Permissible B.U.A.		37.500
Proposed Structure In Recreational Open Space 1		
4	a Proposed On Ground Floor	25.000
Total Proposed B.U.A.		25.000

SCHEDULE OF DOORS & WINDOWS				
TYPE	SIZE IN M.	AREA IN SQ.M.	SILL HEIGHT IN M.	DESCRIPTION
D	1.20X2.10	2.100	0.00	T.W. PANEL DOOR
D1	0.75X2.10	1.575	0.00	T.W. PANEL DOOR
W	2.20X2.60	5.720	1.10	AL.SLIDING FRENCH WINDOW
W1	1.50X2.60	3.900	1.10	AL.SLIDING FRENCH WINDOW
V	0.60X0.90	0.540	1.20	AL. FRAME LOUVERED WINDOW

SCHEDULE OF LIGHT & VENTILATION				
ROOM	CARPET AREA	WINDOW TYPE	L&V REQUIRED	L & V PROVIDED
(1)	(2)	(3)	(4)=(2)/6	(5)
MULTIPURPOSE HALL	20.095	W, W1 3 Nos.	3.349	15.340
W. C.	1.650	V 1Nos.	0.275	0.540

GROUND FLOOR BUILT UP AREA CALCULATION						
Sr. No.	NUMBER	NUMBER OF DEDUCTION	1/2	BASE (M)	HEIGHT (M)	AREA (SQ.M.)
(1)	(2)	(3)	(4)	(5)	(6)	(7)=3X4X5X6
GROUND FLOOR BUILT UP AREA CALCULATION						
1	A	1	1	6.250	4.000	25.000
TOTAL NET BUILT UP AREA GROUND FLOOR						25.000

## NAME OF THE OWNER &amp; SIGNATURE

Rajendra J. Gander  
Rim

## DESCRIPTION OF PROPOSAL &amp; PROPERTY

PROPOSED RESIDENTIAL BUILDING ON LAND BEARING SURVEY No. 71/2 AT VILLAGE - KEVALE, TAL - PANVEL, DIST - RAIGAD.

## ARCHITECT NAME &amp; SIGN



NEHA JAIN  
REG NO : CA/2008/43603

DATE	DRAWN. BY	CHKD. BY	SCALE	NORTH
26-02-2020	Rajeshree	Gharal	1:100	



DESIGN WITH A DIFFERENCE

**AN.ARCH**  
ARCHITECT & PLANNERS

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