

				a Area of Plot (as per 7/12) and NA order
				b Area of Plot as per TILR (by triangulation method at true scale)
	HIT UD ADEA CU	ASSABU	1	c Area of Plot as per Physical Survey
	BUILT-UP-AREA SUI		-	d Area of plot considered {least of (a), (b) and (c)}
	(AS PER SANCTIONED NAINA DCPR)	MODIFICATION IN NAINA DCPR UNDER SECTION 37 OF MRTP ACT)		Deduction for
Floors↓	Area In Sqm.	Area In Sqm.		a Existing road (ROW)
(1)	(2)	(2)	2	b Proposed widening of existing road
Ground	26.819	58.625	1 1 '	c Proposed IDP/DP road
1st Floor	354.448	436.788		d Area under reservation, if any
2nd Floor	354.448	436.788		Total (a+b+c+d)
3rd Floor	354.448	436.788		
4th Floor	354.448	436.788	3	Gross area of Plot (1-2)
Total	1444.611	1805.777		Deduction for Amenity Space, if any
RVANT TOILET	4.781	4.781	4	a Required Amenity Space (5% of 3)
DRIVER ROOM	14.404	14.404		b Proposed Amenity Space
OCIETY OFFICE		20	5	Net Plot area (3-4a)
al Built-up - Area	1463.796	1844.962		a Required RG/Open Space (10% of 5)
			6	b Proposed RG/open Space
				Permissible FSI
			7	a Base FSI permissible
				b Premissible FSI with payment of premimum
			8	Permissible Built Up Area {(7a+7b)x5}
			9	Proposed Built Up Area
			10	Permissible Built Up area of EWS component (20% of 9)
148		GR	11	Proposed Built Up Area Of EWS component
40	94 /	110	12	Existing Built Up Area, If any
1	1	111	13	Excess Balcony area counted in FSI
			14	Excess Terrace area counted in FSI

Sr. No.

Floor		Built-Up- rea (Sqm) Permissible balcony Area (Sqm)		Proposed Balcony Area (In Sqm)			
			Enclosed	Open	Total	Excess	
(1)	(2)	(3)=(2) X 15%	(4)	(5)	(6)	if(6)>(3), (7)=(6)-(3)	
Ground Floor	26.819	4.023	0.000	0.000	0.000	0.000	
1st Floor	354.448	53.167	0.000	51.200	51.200	0.000	
2nd Floor	354.448	53.167	0.000	51.200	51.200	0.000	
3rd Floor	354.448	53.167	0.000	51.200	51.200	0.000	
4th Floor	354.448	53.167	0.000	51.200	51.200	0.000	
Total	1444.611	216.692	0.000	204.800	204.800	0.000	

AREA STATEMENT

Particulars

a Trees to be planted against plot area (1 tree for evey 100 Sq. M.)

b Trees to be planted against RG/open space (5 tree for evey 100 Sq. M.)

e Trees to be planted against tree fell (5 tree for every 1 tree fell) (d x 5)=

15 Balance Built Up Area = (8-9)

No. of units proposed

c Existing trees

d Trees to be cut

a Residential - Sale component

f Total required trees (a+b+e) =

g Existing Number of trees to be retain (c-d)=

h Req. Number of trees to be planted (f-g)

16 Excess Built Up Area

17 Total FSI consumed

18 Balance FSI

Area(in Sq. M.)

3680.000

4044.812

3535.100

3535.100

0.000 0.000

0.000

0.000

0.000 3535.100

NA

NA 3535.100

353.510 370.828

> 0.7 0.3

3535.1 1463.796

N.A.

0 0 0

0

2071.304

0.000

0.414

0.586

40

37

19

6

0

0

56

6

50

			The state of the s	LOOR AF	REA STAT	EMENT					
1	2	3	4	5	6	7	8	9	10	11	12
		FLOORS PROPOSED AREA PERMISSIBLE PROPOSED BALCONY ENCLOSED TOTAL (5 + 6 +7)	PERMISSIBLE	PROPOSED BALCONY				PERMISSIBLE TERRACE	PROPOSED TERRACE	EXCESS	
SR.	FLOORS		TOTAL	TOTAL BALANCE							
NO.	TEOGRA		OPEN	N (5 + 6 +7)	1 1 1 1 1 1 1 1 1 1 1 1 1 1 1 1 1 1 1 1	AREA (20% OF 3)	AREA	(11 - 10)			
1	GROUND	26.819	4.023	0.000	0.000	0.000	0.000	0.000	0.000	0.000	0.000
2	FIRST	354.448	53.167	0.000	0.000	51.200	51.200	0.000	70.890	0.000	0.000
3	SECOND	354.448	53.167	0.000	0.000	51.200	51.200	0.000	70.890	0.000	0.000
4	THIRD	354.448	53.167	0.000	0.000	51.200	51.200	0.000	70.890	0.000	0.000
5	FOURTH	354.448	53.167	0.000	0.000	51.200	51.200	0.000	70.890	0.000	0.000
6	TOTAL	1444.611	216.692	0.000	0.000	204.800	204.800	0.000	283.558	0.000	0.000
7	TOTAL EXCESS BALC.	0.000									
8	TOTAL EXCESS TERRACE	0.000									
9	SERVANT TOILET AREA	4.781	10 1 7								
10	DRIVER ROOM	14.404									

		30.075		
17.578		32.523	0	12.14 827:11
	2	24 049		7
		31.018		

TENEMENT AREA STATEMENT A WING

B WING

24 181.380 0.000 123.000

0.000 5.150

CARPET AREA BALCONY AREA BUILT UP AREA

0.000 204.800

5.150

30.228 0.000 5.000 16 120.912 0.000 81.800 132.356

0.000

CARPET AREA

30.228

30.228

BUILT UP AREA

33.225

32.771

33.196

198.835

TOTAL BUILTUP AREA 1463.796

RECREATIONAL OPEN SPACE AREA CALCULATION DIAGRAM SCALE 1:250

		Pa	rking Area Statemer	nt			
Bldg.	Occupancy		One Parking for Every	Number	Standard	Parking type	
No.				of units	Car	Car	Scoote
(1)	(2		(3)	(4)	(5)=(3)x(4)	(6)	(7)
	4 tenements having 35 sq.m		0.25	40	10	10	
		Subtotal	Parking required			10	
		Visitor Parking 1	0% of above (10 X 10%)			1	
		Total Pa	rking Required			11	7
		Total Pa	rking Provided			16	8
1	Note:		g = (No. of Car) X (12.5 i.e. i.e. Area of Scooter Parking		ing) X (10%) /		

STAMP OF APPROVAL

Approved subject to the conditions mentioned in Commencement Certificate issued by this office bearing Certificate no. CIDCO/NAINA/Panvel/Adai/BP-00554/CC/2022/0223 dated 21.07.2022.

EG	ENDS		
Sr. No.	Item	Site Plan on White Print	Building Plan On White Print
1	Plot Line		
2	EXisting Street		
74	Future Street		
4	Permisible Building lines		
5	Built up area lines		
6	Marginal Open Spaces	No colour	
7	Drainage & Sewerage Work		
8	Water Supply Work		
9	RWH Line		
10	S. W. Drain		
12	Two wheeler parking	222	
13	Big car parking		
14	Small car parking		

CERTIFICATE OF AREA

CERTIFIED THAT I HAVE SURVEYED THE PLOT BEARING S.NO.102/3/A/3/B/2, AT-VILLAGE- ADAI, TALUKA PANVEL, DIST.RAIGAD.DATED 07/08/2021.AND THAT THE DIMENSIONS OF THE SIDES ETC.OF THE PLOT STATED ON THE PLAN ARE AS PER MEASURED ON SITE AND AREA SO WORKED OUT IS 3535,100 SQ.MTR

M/S.JB INFRA PROJECTS FROM PARTNER

15 EXisting Tree

(MR.BINOJ MATHEW) (MR.SHARAD NAMA PATIL)
(SIGNATURE OF POA HOLDER) (SIGNATURE OF OWNER) FORM OF CERTIFICATE

PARAG MEHETAR HAVE BEEN EMPLOYED BY THE APPLICANT AS HIS ARCHITECT. I HAVE EXAMINED THE BOUNDARIES AND THE AREA OF THE PLOT ALL THE STATEMENTS MADE BY THE APPLICANT WHO IS THE OWNER / LEASE IN POSSESSION OF THE PLOT AS IN THE ABOVE FORM AND FOUND THEM TO BE

ADD:Office No.2, 2nd Floor, A Wing, Yashokiran Hsg Society, Sawarkar Chauk, Panvel-410206. MOB. : +919819595299



CA/2013/58335

SPECIFICATIONS

• EXTERNAL WALL THK. 150 MM
• INTERNAL WALL THK. 100 MM

SHEET CONTENTS

DIGITALIZED SCAN TILR.

. LOCATION PLAN & NAINA DP MAP.

• TILR PLOT CALCULATION & DIAGRAM.

• LAYOUT PLAN & PARKING AREA STATEMENT

· BUILT UP AREA SUMMARY. FLOOR AREA STATEMENT. BALCONY AREA & TERRACE AREA STATEMENT.

NAME OF THE OWNER & SIGNATURE M/S.JB INFRA PROJECTS FROM PARTNER

SIGNATURE OF POA HOLDER)


(MR.SHAFAD NAMA PATIL) (SIGNATURE OF OWNER) **DESCRIPTION OF PROPOSAL & PROPERTY**


PROPOSED RESIDENTIAL BUILDING ON S.NO.102/3/A/3/B/2, AT VILLAGE-ADAI,TAL PANVEL, DIST. - RAIGAD.




SCALE

SHEET NO.1/4

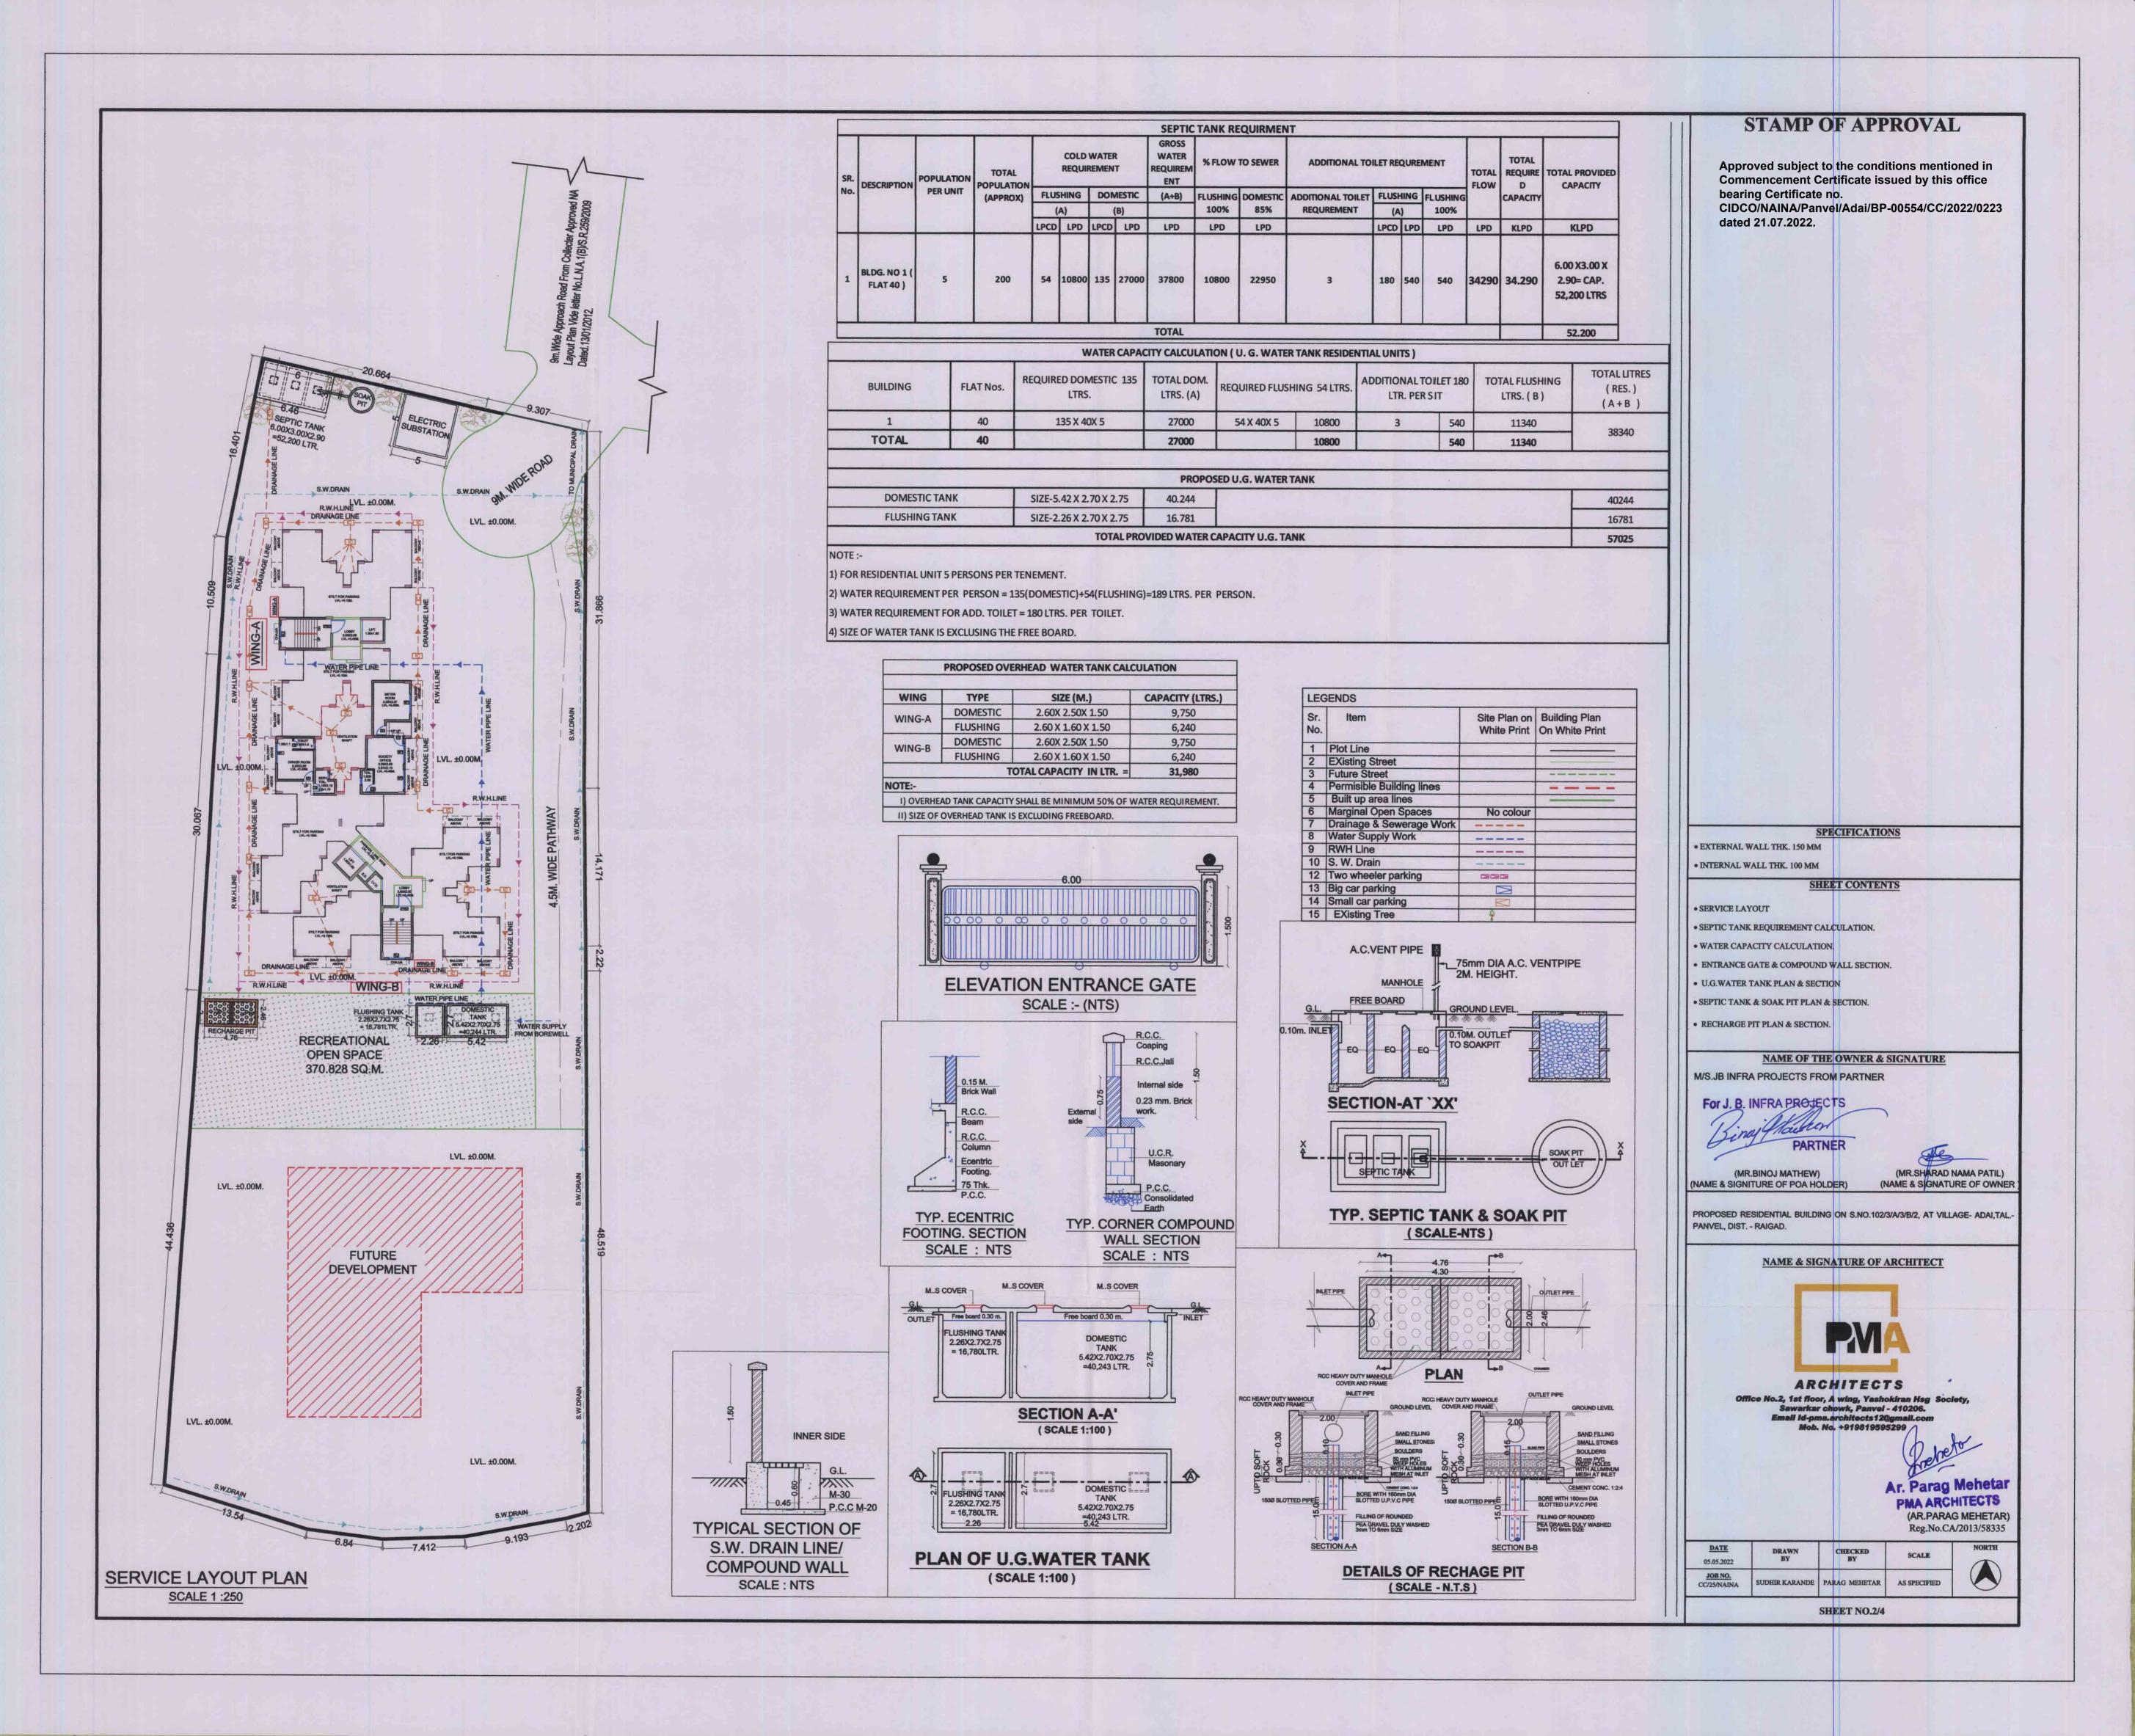

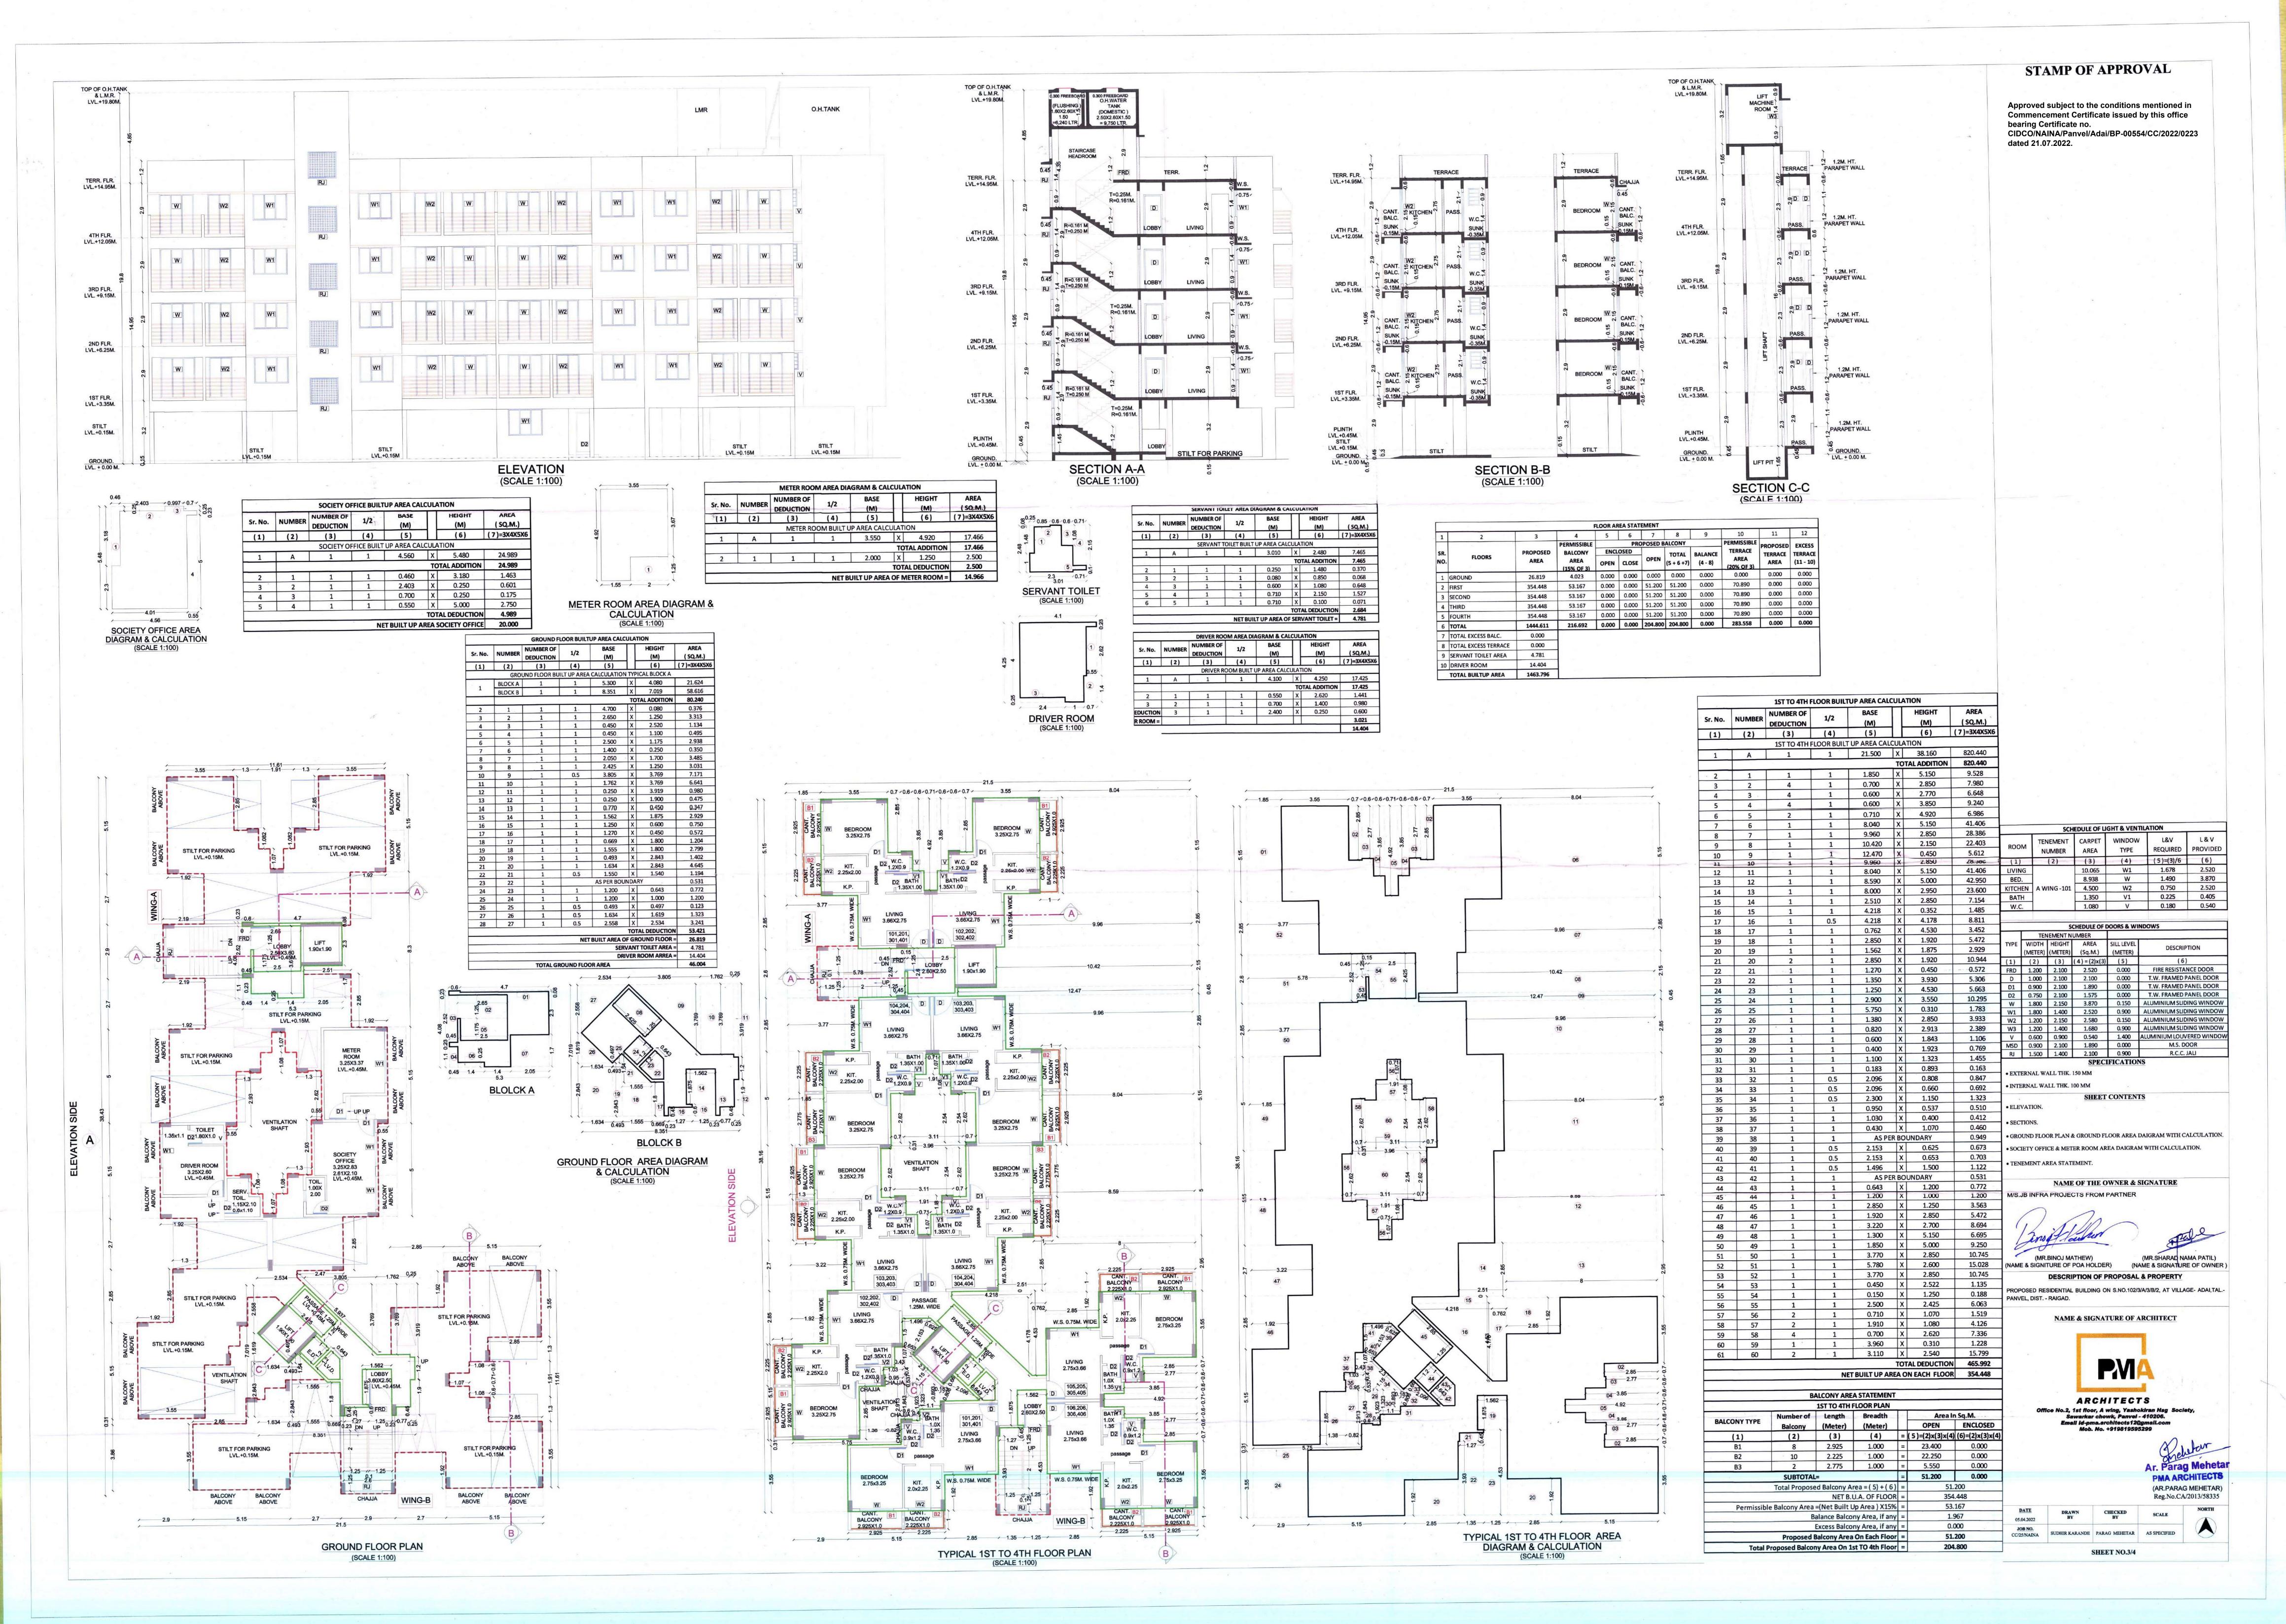

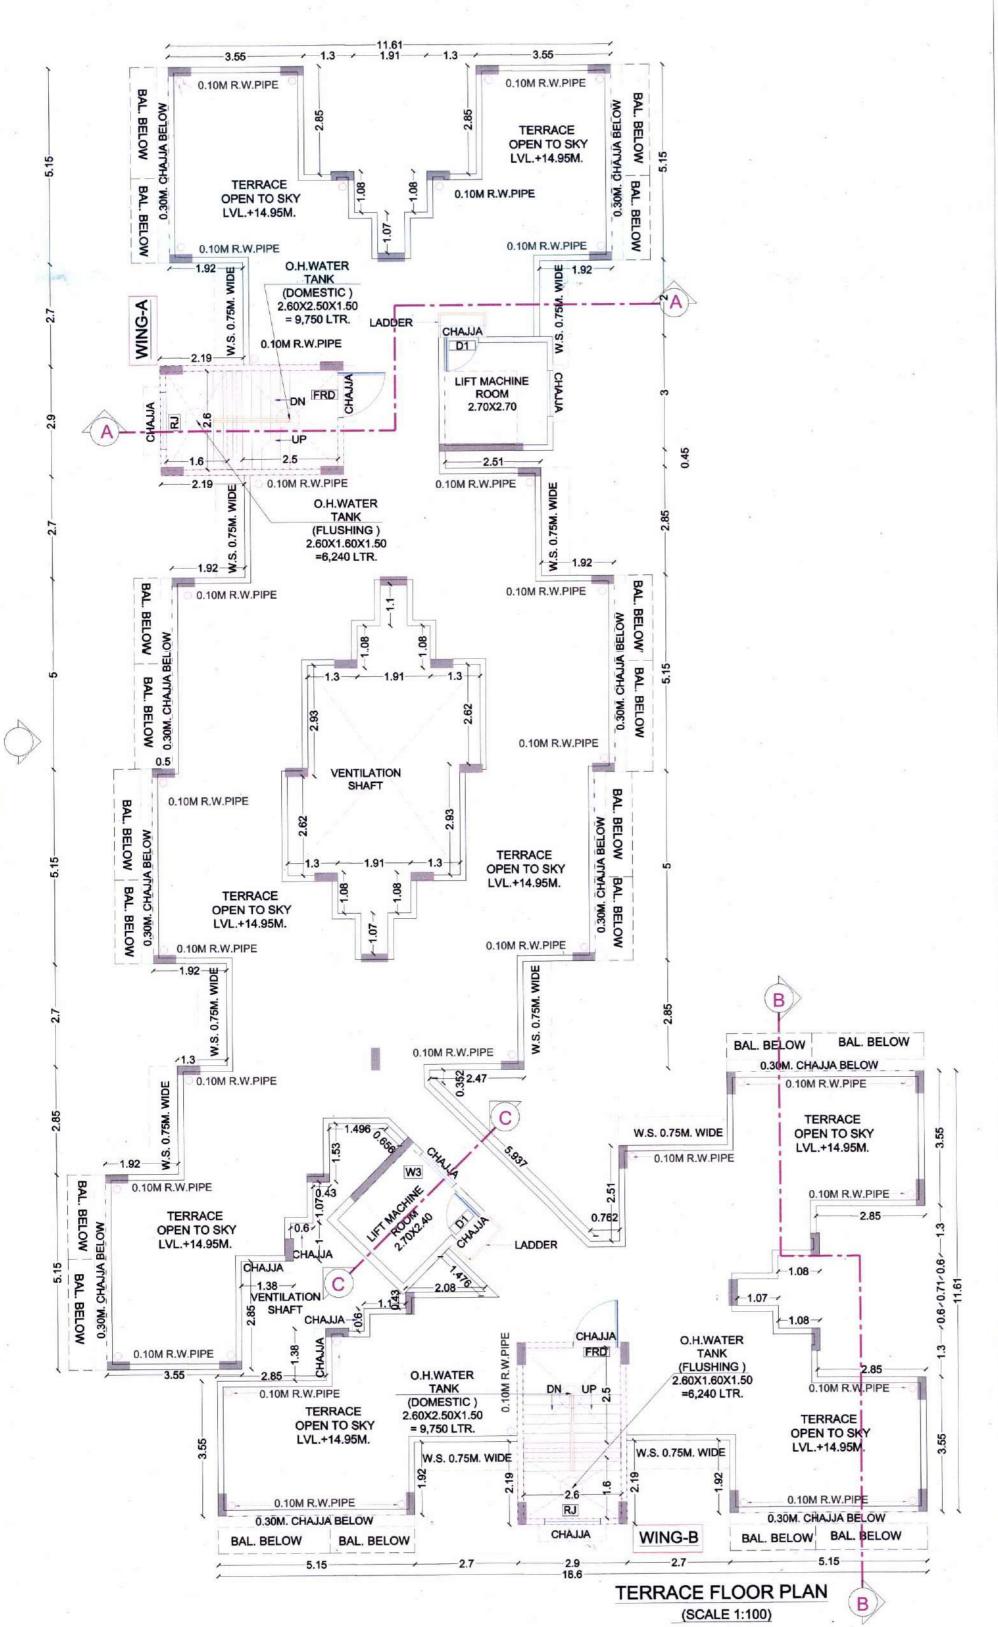

ELEVATION SIDE

STAMP OF APPROVAL

Approved subject to the conditions mentioned in **Commencement Certificate issued by this office** bearing Certificate no. CIDCO/NAINA/Panvel/Adai/BP-00554/CC/2022/0223 dated 21.07.2022.

	- 12	S	CHEDULE OF D	OORS & W	INDOWS
	TENEMENT NUMBER				
TYPE	WIDTH (METER)	HEIGHT (METER)	AREA (Sq.M.)	SILL LEVEL (METER)	DESCRIPTION
(1)	(2)	(3)	(4) = (2)x(3)	(5)	(6)
FRD	1.200	2.100	2.520	0.000	FIRE RESISTANCE DOOR
D	1.000	2.100	2.100	0.000	T.W. FRAMED PANEL DOOR
D1	0.900	2.100	1.890	0.000	T.W. FRAMED PANEL DOOR
D2	0.750	2.100	1.575	0.000	T.W. FRAMED PANEL DOOR
W	1.800	2.150	3.870	0.150	ALUMINIUM SLIDING WINDOW
W1	1.800	1.400	2.520	0.900	ALUMINIUM SLIDING WINDOW
W2	1.200	2.150	2.580	0.150	ALUMINIUM SLIDING WINDOW
W3	1.200	1.400	1.680	0.900	ALUMINIUM SLIDING WINDOW
٧	0.600	0.900	0.540	1.400	ALUMINIUM LOUVERED WINDOW
MSD	0.900	2.100	1.890	0.000	M.S. DOOR
RJ	1.500	1.400	2.100	0.900	R.C.C. JALI

SPECIFICATIONS • EXTERNAL WALL THK. 150 MM

• INTERNAL WALL THK. 100 MM

SHEET CONTENTS

• ELEVATION.

• SECTIONS.

• GROUND FLOOR PLAN & GROUND FLOOR AREA DAIGRAM WITH CALCULATION.

• SOCIETY OFFICE & METER ROOM AREA DAIGRAM WITH CALCULATION.

• TENEMENT AREA STATEMENT.

NAME OF THE OWNER & SIGNATURE

M/S.JB INFRA PROJECTS FROM PARTNER

(MR.BINOJ MATHEW)

(MR.SHARAD NAMA PATIL)

(NAME & SIGNITURE OF POA HOLDER) **DESCRIPTION OF PROPOSAL & PROPERTY**

(NAME & SIGNATURE OF OWNER)

PROPOSED RESIDENTIAL BUILDING ON S.NO.102/3/A/3/B/2, AT VILLAGE- ADAI,TAL.-

NAME & SIGNATURE OF ARCHITECT

PANVEL, DIST. - RAIGAD.



ARCHITECTS

Office No.2, 1st floor, A wing, Yashokiran Hsg Society, Sawarkar chowk, Panvel - 410206. Email Id-pma.architects12@gmail.com Mob. No. +919819595299

> Ar. Parag Mehetar PMA ARCHITECTS

(AR.PARAG MEHETAR) Reg.No.CA/2013/58335

NORTH DATE CHECKED DRAWN SCALE 05.04.2022 JOB NO. SUDHIR KARANDE PARAG MEHETAR AS SPECIFIED CC/25/NAINA

SHEET NO.4/4