

Approved subject to the conditions mentioned in commencement certificate issued by the office bearing Certificate no. : CIDCO/NAINA/Panvel/Chipale/BP-00600/ CC/2023/0343 dated 17 Mar 2023

2/4

Legend								
Sr. no.	Item	Site plan on white print	Building plan on white print					
(1)	(2)	(3)	(4)					
1	Plot line	***************************************	talahan kananta penalahan menjanan					
2	Drainage & Sewerage work							
3	Water supply work							
4	RWH line							
5	S.W.Drain							

## SHEET CONTENTS:

SERVICES PLAN, UGT PLAN & SECTION & CAP. CAL., GATE ELEVATION, OHT CAP. CALCULATION, SEPTIC TANK & SOAK PIT PLAN & SECTION, & CAP. CAL., S.W.DRAIN TYP. SECTION, COUMPOUND WALL SECTION, ECCENTRIC FOOTING SECTION, RWH TANK PLAN AND SECTION.

OWNERS NAME & SIGNATURE

for Meenakshi & Associates Reg. No. CA/1998/22946

R.C.C.Jali

TYP. CORNER COMPOUND

WALL SECTION

SCALE : NTS

0.23 mm. Brick work.

D - VARIABLE

SIGNATURE OF OWNER RAJENDRA CHAMPALAL GANDHI

SIGNATURE OF ARCHITECT (AR. MEENAKSHI SHRIVASTAV) (REG. NO. CA/1998/22946)

Description Of Proposal & Property

PROPOSED RESIDENTIAL BUILDING ON GUT NO. 25/4/A AT VILLAGE - CHIPALE,

TAL. - PANVEL, DIST. - RAIGAD.

Subject:

Ar

## DEVELOPMENT PERMISSION

Name & Signature of Architect:

Ar. Meenakshi Shrivastav CA/98/22946



1:100 DEALT PRIYA

JOB NO.

P356/2021

DATE

15/11/2022

SCALE

DRG. NO. 02/04

A.C.VENT PIPE TL.75mm DIA A.C. VENTPIPE OF 2M. HEIGHT IF TANK 15mts. AWAY FROM BUILDING OR AT A HT. 2M. FROM TOP OF THE BLDG IF LESS THEN 15mts. SEPTIC TANK REQUIREMENT

SECTION-AT A-A' DOMESTIC SEPTIC TANK 4.50 X 2.00 X 2.00 CAP. 18000.00 LTRS.

IN LET FREE BOARD R.C.C. SLAB

DOMESTIC TANK VITH SUBMERSIBLE PUMP CAP = 12000.00 LTS

U.G.TANK- (SCALE - 1:100)

Total

270

8100

Drivers

3.00 X 2.00 X 2.00

[3] [4]=[2]x[5] [5]=[3]x180 [6]=[4]x189 [7]=[2]x270 [7]=[5]+[6]

of units | 135 LITRES

1) For Residential unit 5 persons per tenement

4) Size of water tank is exclusing the free board.

PROPOSED 45.0 M. WIDE IDP ROAD


3) Water requirement for addl. Toilet = 180 litre per tenement

2) Water requirement per capita = 135(Domestic) + 54(Flushing) = 189 litres per capita

**BUILDING LINE** 

BLDG 1

Servant toilet

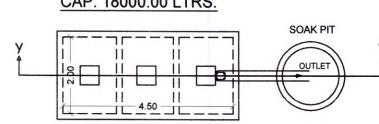

Bldg nos.	Number of	Donulation	T					<u> </u>						
biug nos.	Number of	Population	1	Wa	ter require	ment				Flow to sewer		Total flow	Septic tank provided	
	tenement								110W to sewer			to septic tank	Septic talk provided	
			Flushing		Domestic		Total	Flushir	g(100%)	Domestic(85%)	Total		Size	Capacity
			LPCD	LPD	LPCD	LPD	LPD	L	PD	LPD	LPD	LPD		
[1]	[2]	[3] = [2] X 5 nos.	[4]	[5]=[3]X[4]	[6]	[7]=[3]X[6]	[8]=[5]+[7]	[9]=[5	X100%	[10]=[7]X85%	[11]=[9]+[10]	[12]	[13]	[14]
BLDG 1	8	40	54	2160	135	5400	7560	2	160	4590.00	6750.00	6750.00	4.50 X 2.00 X 2.00	18000.00
Servant's toilet	1		270	270				2	70		270.00	270.00		
Driver's toilet	1		270	270					70		270.00	270.00		
	8						7560	270	0.00		7290.00	7290.00		18000.00
Note:														
1) LPCD = Litre	per capita pe	er day												
2) LPD = Litre p	er day						***************************************							
3) For septic ta	nk capacity f	lushing & domest	ic flow to s	ewer will be	100% & 85	% respective	ely							
4) Size of septi	c tank is excl	using the free boa	ard.											

FREE BOARD R.C.C. SLAB CAP = 10000 L SECTION-AT A-A



-	OVERHEAD WA	TER TANK CAP	PACITY CALCUL	ATION
Bldg no.	Water required		ead water tank pro	
	ltrs.	Tank size(meter)	Number of tank	Capacity (litre)
[1]	[2]	[3]	[4]	[5]
BLDG 1	4050.00	2.50 X4.40 X1.50	1	16500.00
Total	4050.00		1	16500.00
Note:				
1) OHT cap	ocity should be mi	nimum 50% of wa	ter requirement	
2) Size of	overhead water ta	nk is exclusing the	free board.	

M.S.GATE SCALE: N.T.S.

**ELEVATION OF GATE** 

**SERVICES PLAN** (SCALE - 1:200)

NOTE: ALL DIMENSIONS ARE IN MTS.

TYPICAL SECTION OF S.W.

DRAIN LINE/ COMPOUND

WALL

SCALE: NTS

**INNER SIDE** 


P.C.C M-20

TYP.ECENTRIC FOOTING.

SECTION

SCALE : NTS

PLAN (SCALE - 1:100) 12000.00

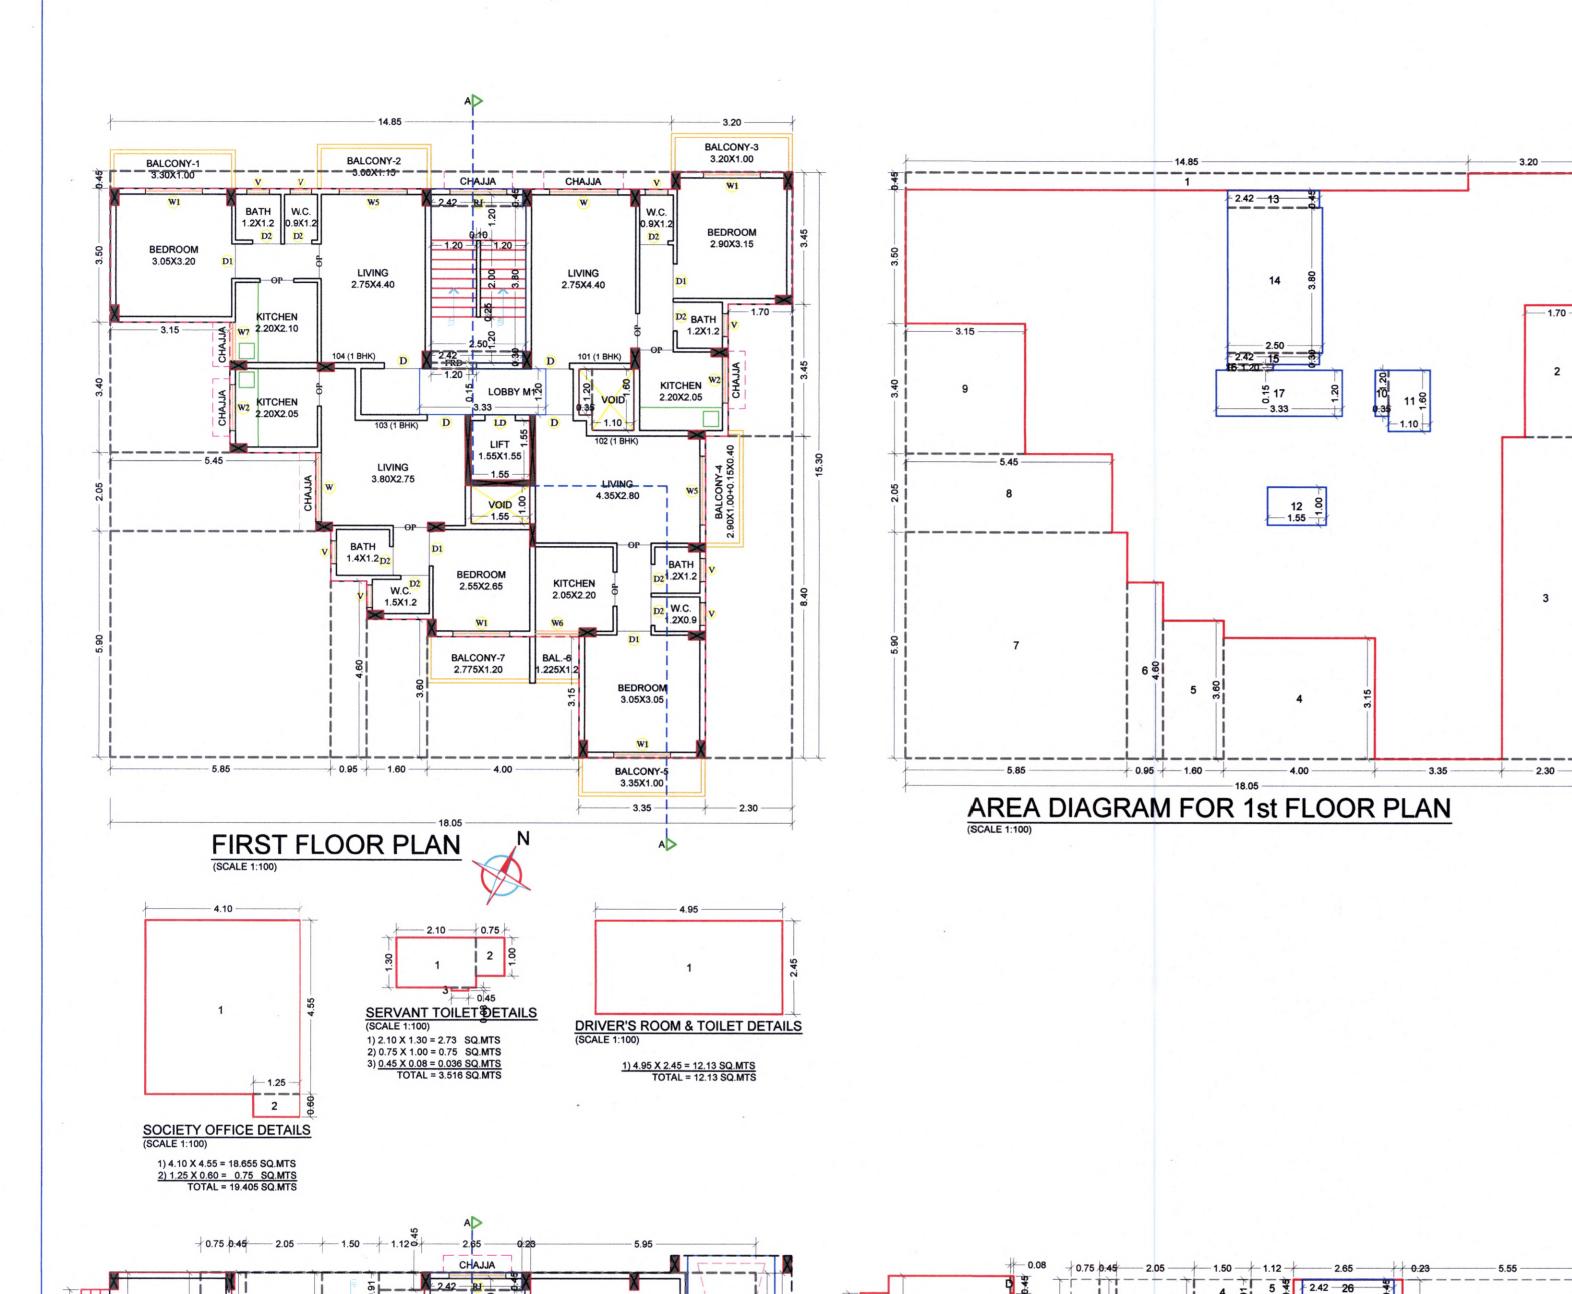

6 1 2

2.30 -

3.05

21

AREA DIAGRAM FOR GROUND FLOOR PLAN-

(SHOP, SERVANT TOILET & DRIVER'S ROOM & TOILET

0.45 2.50 0.45 2.25 -

--- 3.22 ----

SOCIETY OFFICE

LVL+0.60 MTS.

DRIVER'S ROOM

TOILET

SHOP 1 3.07X3.20

0.75

LVL + 0.15 MTS.

3.77X2.05

က် LVL+0.45 MTS.

SHOP 3

GROUND FLOOR PLAN

VISITORS PARKING-1

3.95X1.85+2.33X0.85

3.05 0.45 2.50 0.45 / 2.25 \

		BUA Sta	tement o	of 1st Floor	
_	Block	Number of	Length	Breadth	Area in
	Description	blocks	(meter)	(meter)	sq.mts
	[1]	[2]	[3]	[4]	[5]=[2]x[3]x[4
	Α	1	18.05	15.30	276.17
				Subtotal : A	276.17
	DEDUCTION	S:			
	1	1	14.85	0.45	6.68
	2	1	1.70	3.45	5.87
	3	1	2.30	8.40	19.32
	4	1	4.00	3.15	12.60
	5	1	1.60	3.60	5.76
	6	1	0.95	4.60	4.37
	7	1	5.85	5.90	34.52
8	8	1	5.45	2.05	11.17
-	9	1	3.15	3.40	10.71
	10	1	0.35	1.20	0.42
	11	1	1.10	1.60	1.76
	12	1	1.55	1.00	1.55
	13	1	2.42	0.45	1.09
	14	1	2.50	3.80	9.50
	15	1	2.42	0.30	0.73
	16	1	1.20	0.15	0.18
	17	1	3.33	1.20	3.99
	Total	17		Subtotal : B	130.21
	Net Built-ur	area = (Subt	otal:A) - (S	ubtotal : B)	145.95

	<b>BUA State</b>	ment of	<b>Ground Flo</b>	or
Block	Number of	Length	Breadth	Area in
Description	blocks	(meter)	(meter)	sq.mts
[1]	[2]	[3]	[4]	[5]=[2]x[3]x[4
Α	1	14.30	11.78	168.45
В	1	0.75	1.40	1.05
С	1	3.22	3.50	11.27
D	1	0.08	0.45	0.04
			Subtotal : A	180.81
DEDUCTION	S:			
1	1	0.75	4.55	3.41
2	1	0.45	4.51	2.03
3	1	2.05	4.55	9.33
4	1	1.50	0.91	1.36
5	1	1.12	0.45	0.50
6	1	1.20	0.71	0.85
7	1	5.55	4.55	25.25
8	1	2.70	0.60	1.62
9	1	0.75	0.30	0.23
10	1	1.35	3.20	4.32
11	1	2.70	2.80	7.56
12	1	0.45	2.72	1.22
13	1	0.95	2.80	2.66
14	1	0.65	2.53	1.64
15	1	0.30	0.08	0.02
16	1	4.20	0.08	0.34
17	1	2.25	2.88	6.48
18	2	0.45	2.83	2.55
19	1	2.50	2.88	7.20
20	1	3.05	3.68	11.22
21	1	2.30	1.20	2.76
22	1	0.75	0.95	0.71
23	1	0.35	1.20	0.42
24	1	1.10	1.60	1.76
25	1	1.55	1.00	1.55
26	1	2.42	0.45	1.09
27	1	2.50	3.80	9.50
28	1	2.42	0.30	0.73
29	1	1.20	0.15	0.18
30	1	3.33	1.20	3.99
Total	31	1	Subtotal : B	112.48
	area = (Subt	11.00.40		68.33

	<b>BUA State</b>	ement of	Ground Flo	or
Block	Number of	Length	Breadth	Area in
Description	blocks	(meter)	(meter)	sq.mts
[1]	[2]	[3]	[4]	[5]=[2]x[3]x[4]
Α	1	14.30	11.78	168.45
В	1	0.75	1.40	1.05
С	1	3.22	3.50	11.27
D	1	0.08	0.45	0.04
V			Subtotal : A	180.81
DEDUCTION	S:			
1	1	0.75	4.55	3.41
2	1	0.45	4.51	2.03
3	1	2.05	4.55	9.33
4	1	1.50	0.91	1.36
5	1	1.12	0.45	0.50
6	1	1.20	0.71	0.85
7	1	5.55	4.55	25.25
8	1	2.70	0.60	1.62
9	1	0.75	0.30	0.23
10	1	1.35	3.20	4.32
11	1	2.70	2.80	7.56
12	1	0.45	2.72	1.22
13	1	0.95	2.80	2.66
14	1	0.65	2.53	1.64
15	1	0.30	0.08	0.02
16	1	4.20	0.08	0.34
17	1	2.25	2.88	6.48
18	2	0.45	2.83	2.55
19	1	2.50	2.88	7.20
20	1	3.05	3.68	11.22
21	1	2.30	1.20	2.76
22	1	0.75	0.95	0.71
23	1	0.35	1.20	0.42
24	1	1.10	1.60	1.76
25	1	1.55	1.00	1.55
26	1	2.42	0.45	1.09
27	1	2.50	3.80	9.50
28	1	2.42	0.30	0.73
29	1	1.20	0.15	0.18
30	1	3.33	1.20	3.99
T . I	24			110.10

	Daic.ony			Open	Enclosed	
[1]	[2]	[3]	[4]	[5]=[2]x[3]x[4]	[6]=[2]x[3]x[4	
B1	1	3.30	1.00	3.30	-	
B2	1	3.00	1.15	3.45	-	
В3	1	3.20	1.00	3.20	-	
B4	1	2.90	1.00	2.96		
04		0.15	0.40	2.90	-	
B5	1	3.35	1.00	3.35	-	
B6	1	1.225	1.20	1.47	-	
В7	1	2.775	1.20	3.33	-	
TOTAL	7		Subtotal	21.06	0.00	
Total propos	ed balcony a	rea = [5] +	[6]	21	.06	
Net BUA of f	loor			145	5.95	
Permissible	balcony area	= (Net BU	A) x 15%	21	.89	
Balance, balo	cony arrea if a	ny		0.	83	
Evenss halco	ny area if any	,		0.	00	

Balcony area statement for 1st Floor

Area in sq.mts

Balcony type Number of Length Breadth

	T	ENEMEN	IT AREA	STATEM	IENT		
	Fllat	NO. of	Carpet	Balcor	ny area	Terrace	Built-up
FLOOR NO.	The difference of the		mts	area	area		
			Sqmts	Enclosed	Projected	Sqmts	Sqmts
T	:1	1	9.82	-	-	-	11.27
GROUND FLOOR	:2	1	7.73	-	-	-	9.02
SHOP	:3	1	9.29	-	-	-	10.87
	Total	3	26.84	0.00	0.00	0.00	31.16
	1(01	1	32.55	-	3.20	-	35.92
	102	1	33.75	-	7.78	-	35.96
1st FLOOR	103	1	28.67	-	3.33	-	32.14
13t T LOOK	104	1	33.35	-	6.75	-	35.91
	Total	4	128.32	0.00	21.06	0.00	139.93
	2:01	1	23.17		-	10.08	25.74
	2102	1	33.75	-	7.87	-	36.18
2nd FLOOR	2(03	1	21.64	-	-	6.97	24.59
ZIIG FLOOR	204	1	33.35	-	6.75	-	35.91
	Total	4	111.91	0.00	14.62	17.05	122.42
Grand total	al	8	240.23	0.00	35.68	17.05	262.35

BUILT- UP	AREA S	TATEM	ENT
FLOORS	BUA IN	SQ.MTS.	TOTAL
GROUND	34.26	34.07	68.33
1st	-	145.95	145.95
2nd	-	128.90	128.90
TOTAL	34.26	308.92	343.18
GRAND TOTAL	343	3.18	343.18

STAMP OF APPROVAL

Approved subject to the conditions mentioned in commencement certificate issued by the office bearing Certificate no. : CIDCO/NAINA/Panvel/Chipale/BP-00600/ CC/2023/0343 dated 17 Mar 2023

3/4

TOTAL UNITS RESIDENTIAL 07 COMMERCIAL **SPECIFICATIONS** 0.15M External wall thk

0.10M

Schedule of light & ventilation Room Tenement Carpet Window L&V L&V provided area type required number [3] [4] [5]=[3] / 6 [2] Living 2.04 2.16 12.25 W Bedroom 9.23 W1 1.54 2.93 Kitchen 4.56 W2 0.76 1.44 BATH 1.51 0.25 0.45 V 1.16 V 0.19

				50145055	2000
			SCH		DOOR & WINDOW
Type	Width	Height	Area	Sill Ivl.	Description
	(meter)	(meter)	(sq.mtr)	(meter)	
[1]	[2]	[3]	[4]=[2]x[3]	[5]	[6]
D	1.00	2.10	2.10	0.00	T.W. 40MM THK FRAME DOOR
D1	0.90	2.10	1.89	0.00	T.W. 40MM THK FRAME DOOR
D2	0.75	2.10	1.58	0.00	35MM SINTEX DOOR
FRD	1.20	2.10	2.52	0.00	FIRE RESISTANT DOOR
W	1.80	1.20	2.16	0.90	ALFRAME SLIDING WINDOW WITH FIXED M.S. GRIL
W1	1.50	1.95	2.93	0.15	AL.FRAME SLIDING WINDOW
W2	1.20	1.20	1.44	0.90	ALFRAME SLIDING WINDOW WITH FIXED M.S. GRIL
W3	1.20	1.95	2.34	0.15	AL.FRAME SLIDING WINDOW
W4	1.50	1.20	1.80	0.90	ALFRAME SLIDING WINDOW WITH FIXED M.S. GRIL
W5	1.80	1.95	3.51	0.15	AL.FRAME SLIDING WINDOW
W6	1.15	1.95	2.24	0.15	ALFRAME SLIDING WINDOW
W7	1.01	1.20	1.21	0.90	ALFRAME SLIDING WINDOW WITH FIXED M.S. GRIL
RJ	1.50	1.20	1.80	0.90	RCC JALI
٧	0.60	0.75	0.45	1.35	GLASS LOUVERED VENTILATOR
LD	A	S PER LIFT	CONSULTAN	T	LIFT DOOR
M1				ART	TIFICIAL LIGHTING
RS	0.00	2.40	0.00	0.00	ROLLER SHUTTER DOOR

SHEET CONTENTS:

Internal wall thk

NOTE: PARAPET WALL - 1.20 MTS HT.

GROUND & FIRST FLOOR PLAN, AREA DIAGRAM FOR GROUND & FIRST FLOOR PLAN & AREA CALCULATIONS BALCONY AREA STATEMENT, TERRACE AREA STATEMENT TENEMENT AREA STATEMENT, BUILT-UP AREA STATEMENT LIGHT & VENTILALTION STATEMENT, SCHEDULE OF DOOR & WINDOW OWNERS NAME & SIGNATURE

SIGNATURE OF OWNER

Mr.RAJENDRA CHAMPALAL GANDHI

TAL. PANVEL, DIST. RAIGAD.

for Meenakshi & Associates Reg. No. CA/1998/22946 SIGNATURE OF ARCHITECT

(Ar.Meenakshi Shrivastav)

DESCRIPTION OF THE PROPERTY PROPOSED RESIDENTIAL BUILDING ON GUT NO. 25/4/A, AT VILLAGE - CHIPALE,

Subject:

DEVELOPMENT PERMISSION

Name & Registration of Architect:

Ar. Meenakshi Shrivastav CA/98/22946


chi Ar

JOB NO. Associates P355/2019 DATE Shop no. 1, Sadguru Universal, 30/11/2022 Plot # 19, Sector-17, SCALE New Panvel(w), 410206 1:100 phone: +91-9820082293 DEALT email: meenakshi2001@hotmail.com PRIYA DRG. NO.

03/04

NOTE: ALL DIMENSIONS ARE IN MTS.

Approved subject to the conditions mentioned in commencement certificate issued by the office bearing Certificate no. : CIDCO/NAINA/Panvel/Chipale/BP-00600/ CC/2023/0343 dated 17 Mar 2023

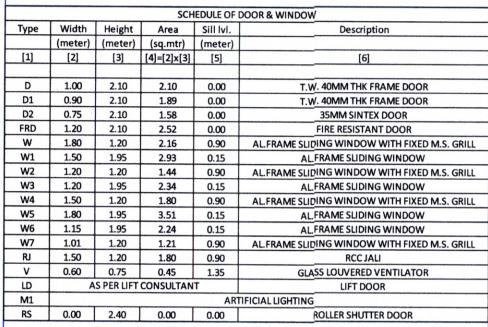

SHEET CONTENTS:

O.OOM. GROUND TVL SECOND & TERRACE FLOOR PLAN, AREA DIAGRAM FOR SECOND FLOOR PLAN & AREA CALCULATIONS BALCONY AREA STATEMENT, TERRACE AREA STATEMENT LIGHT & VENTITALTION STATEMENT, SCHEDULE OF DOOR & WINDOW SECTIONS A-A' AND FRONT SIDE ELEVATION

OWNERS NAME & SIGNATURE

SIGNATURE OF OWNER

for Meenakshi & Associa

DEALT

PRIYA

DRG. NO.

04/04

DESCRIPTION OF THE PROPERTY

PROPOSED RESIDENTIAL BUILDING ON GUT NO. 25/4/A, AT VILLAGE - CHIPALE,

Subject:

DEVELOPMENT PERMISSION

Name & Registration of Architect:


Ar. Meenakshi Shrivastav CA/98/22946


chi


Ar

Shop no. 1, Sadguru Universal, Plot # 19, Sector-17, New Panvel(w), 410206 phone: +91-9820082293 email: meenakshi2001@hotmail.com

Mr.RAJENDRA CHAMPALAL GANDHI SIGNATURE OF ARCHITECT (Ar.Meenakshi Shrivastav) TAL. PANVEL, DIST. RAIGAD. JOB NO. Associates P355/2019 DATE 30/11/2022 SCALE 1:100

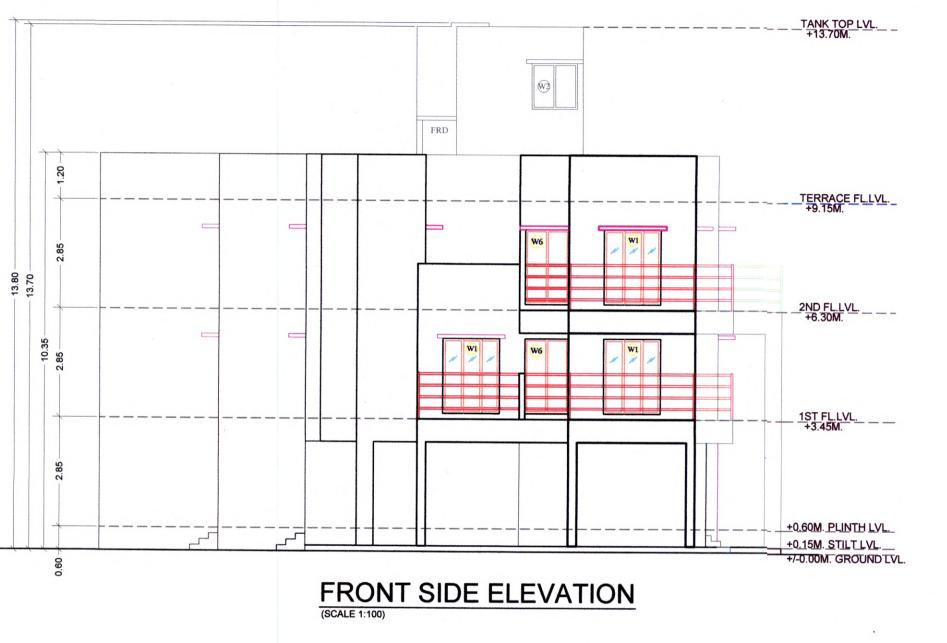

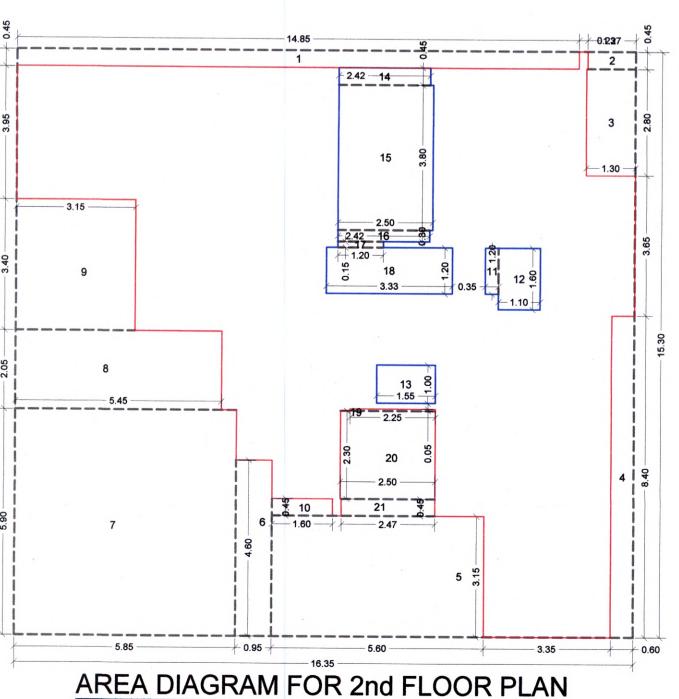

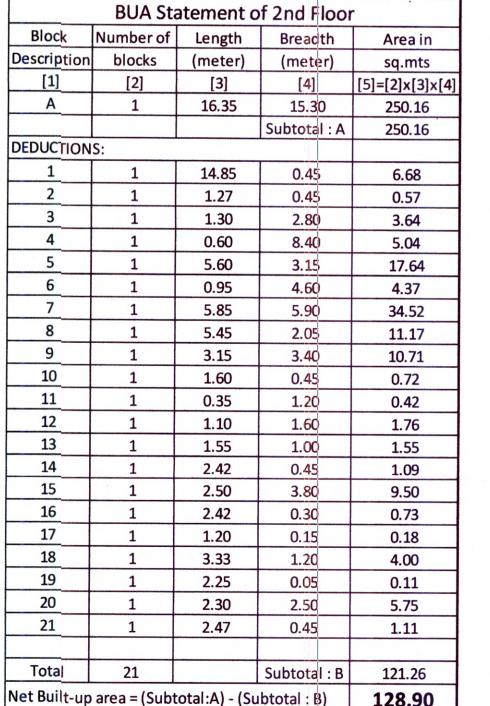

2.50X4.40X1.50

MACHINE ROOM

TREAD-250 RISER-158

	1.00					0.10	2,0		F
	0	2.85		3.20 2.75 2.65			3.30		
	2	FRD		3.2	D2 c		8		F
	2.02	LOBBY		to	DILET NK2500 LVL+0.4	5		+0.60M, PLINTH LVL.	
			S	TILT	NK250 EVE+0.4	STILT FOR	PARKING	+0.15M. STILT LVL.	1
		0.60		2	4	}	0.60	+/-0.00M. GROUND LVL	1
SECT	TION A-A'	LIF	T PIT	0.60	-	5	0.66		F B
(SCALE 1:100)				J					L
,									S
		The same of the sa	The same of the sa			or 2nd Flo			
2nd Floor		Balcony type N	balcony	Length	Breadth		ea in sq.mts		L'
Breadth		[1]	[2]	[3]	[4]	Open [5]=[2]x[3]x	Enclosed [4] [6]=[2]x[3]x[4]		
	Areain	[-]	[-]	[0]	1.7	[0] [2]/[0]/	[4] [0]-[2]*[3]*[4]		
(meter)	sq.mts	B1	1	3.30	1.00	3.30	-		
[4] 15.30	[5]=[2]x[3]x[4]	B2	1	3.00	1.15	3.45	-		
ubtotal : A	250.16 250.16	В3	1	2.90 0.15	1.00 0.40	2.96	-		
ubtotal . A	250.16	B4	1	3.35	1.00	3.35	<del>-</del>		
0.45	6.60	B5	1	1.30	1.20	1.56	-		SI M
0.45	6.68								147
	0.57	TOTAL	5		Subtotal	14.62	0.00		D
2.80	3.64	Total proposed Net BUA of floo		rea = [5] +	[6]		14.62		D
8.40	5.04	Permissible ba		= (Net RU	Δ) v: 15%		128.90 19.34		P
3.15	17.64	Balance, balcon			A) X: 1370		4.72		25
4.60	4.37	Excess balcony					0.00		T.
5.90	34.52	To	rracoa	roa sta	tomont	for 2nd	Class.		
2.05	11.17					for 2nd			
3.40	10.71	Terrace type			Le ngth	Breadth	Area in sq.mts		
0.45	0.72	[1]	terr		II 21	[4]	[5] [3] [3] [4]		_
1.20	0.42	[1]	[2	2]	[3]	[4]	[5]=[2]x[3]x[4]		N
1.60	1.76				21.07	0.45	1.24		
1.00	1.55	T1	1		2.97	0.45	1.34		
0.45	1.09		-	·  -	3.00	2.80	8.40		A
3.80	9.50				170 247	0.20	0.34		_
0.30	0.73	T2	1	, F	2:.50	0.45 2.30	1.11 5.75		
0.15	0.18	12	1	·	2:.25				
1.20	4.00		+		225	0.05	0.11		
0.05	0.11	TOTAL	2	, +		Cubtotal	17.05		
2.50	5.75	Net BUA of f				Subtotal	17.05		Ü
0.45	1.11	Permissible		rea = (Ne	t BIIA) v	20%	128.90 25.78		+
		Balance, terr			L DOA) X	20/0			0
ubtotal : B	121.26						8.73		+
otal : B)	128.90	Excess, terra	ce area if	any			0.00		ב
			NOT	E : Al	L DIMI	ENSION	IS ARE IN M	ITS	7
		1							A
		-							

3.40	KITCHEN 2.20X2.05	1.20 LOBBY M1 N 0.35 VOID & 1.10	KITCHEN WZ 2.20X2.05
2.05	CHAJA	LIVING 3.80X2.75 W 2.25	0.15.30
5.90		1.4X1.2D2	D2 W.C. V

SECOND FLOOR PLAN

0.23

SBELOW TERRACE

CHAJJA BELOW CHAJJA

M.S.LADDER

T | MACHINE ROOM - 3.05 | W2

1.20 M. HEIGHT

3.35

CHAJJA

0.1237

D2 BATH 1.2X1.2

BALCONY-4

BELOW CHAJJA

号 2.97X0.45+3.00X2.80

BELOW CHAJJA

TERRACE BELOW

TERRACE FLOOR PLAN

BALCONY-2

BATH W.C. 1.2X1.2 0.9X1.2

€ W7 2.20X2.10

CHAJJA

PARAPET WALL 1.20 M. HEIGHT

OHT TANK

OPEN TO SKY TERRACE LVL.+9.15 MTS.

2.50X4.40X1.50 -16500 LTRS. CAP.

BELOW CHAJJA

**BALCONY-1** 

BEDROOM 3.05X3.20