
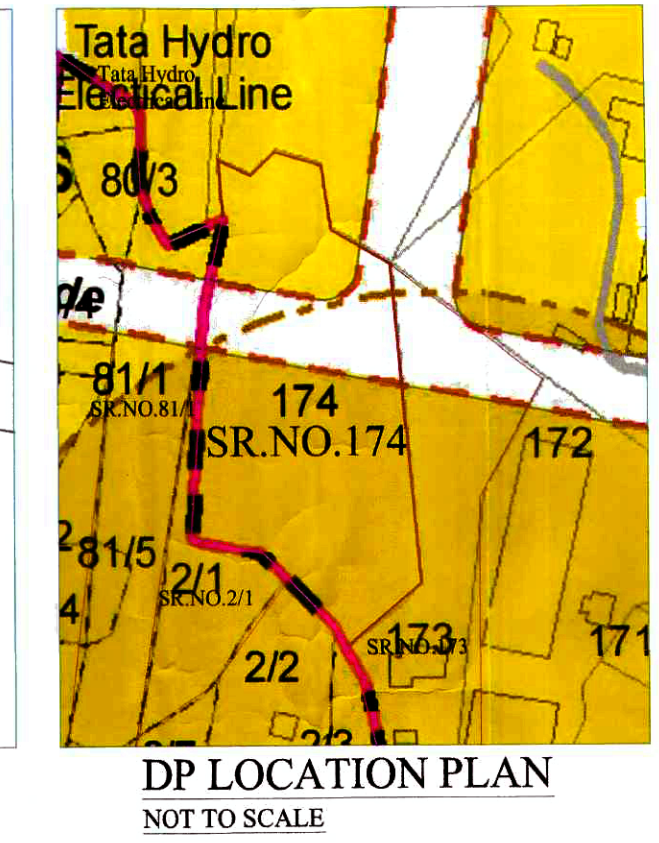
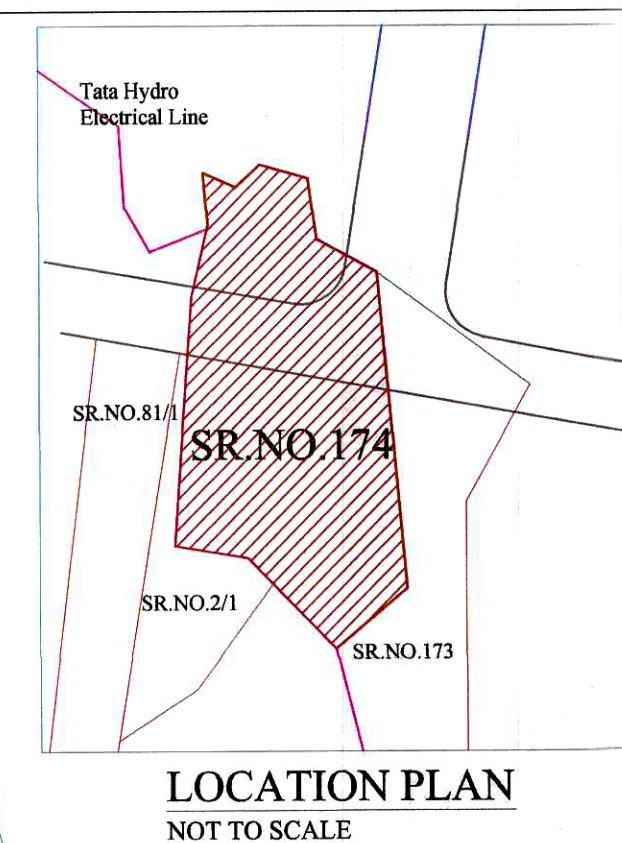
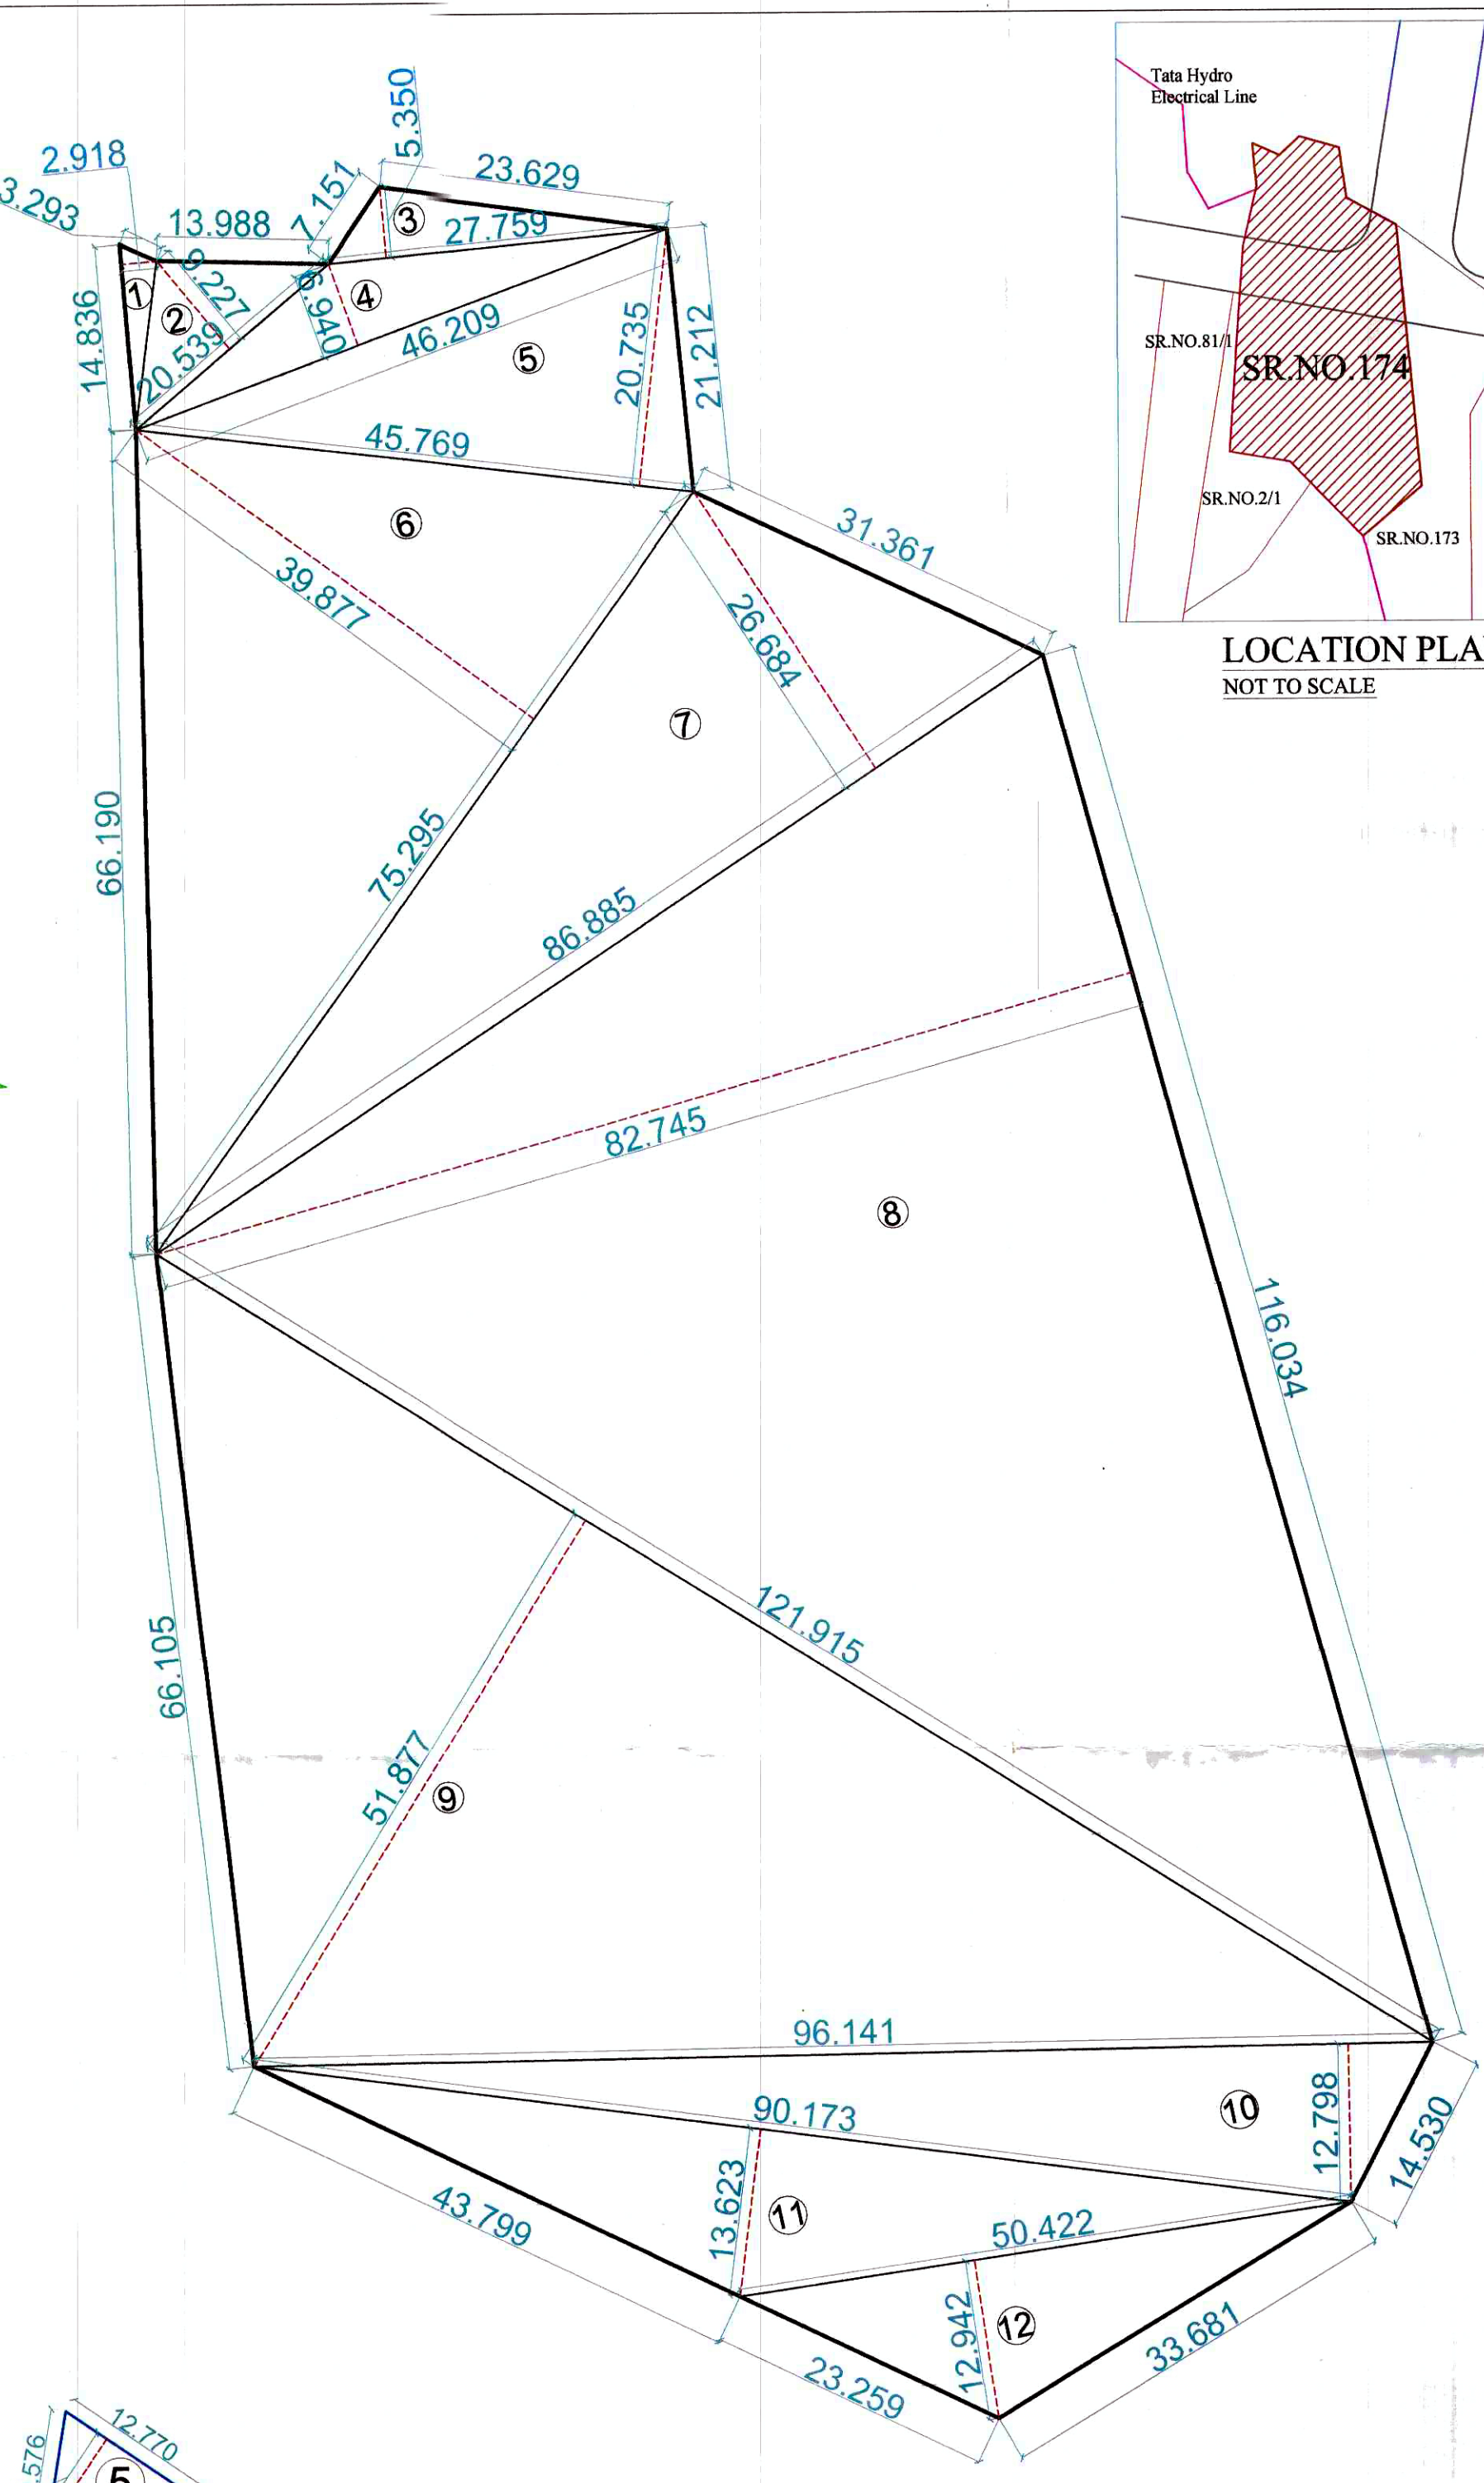


STAMP OF APPROVAL 1/5

This plans are approved subject to the conditions mentioned in commencement certificate issued by this office bearing certificate No.: CIDCO/NAINA/Panvel/Shirdhon/BP-00608/CC/2024/0478
 Dated: 31 January 2024

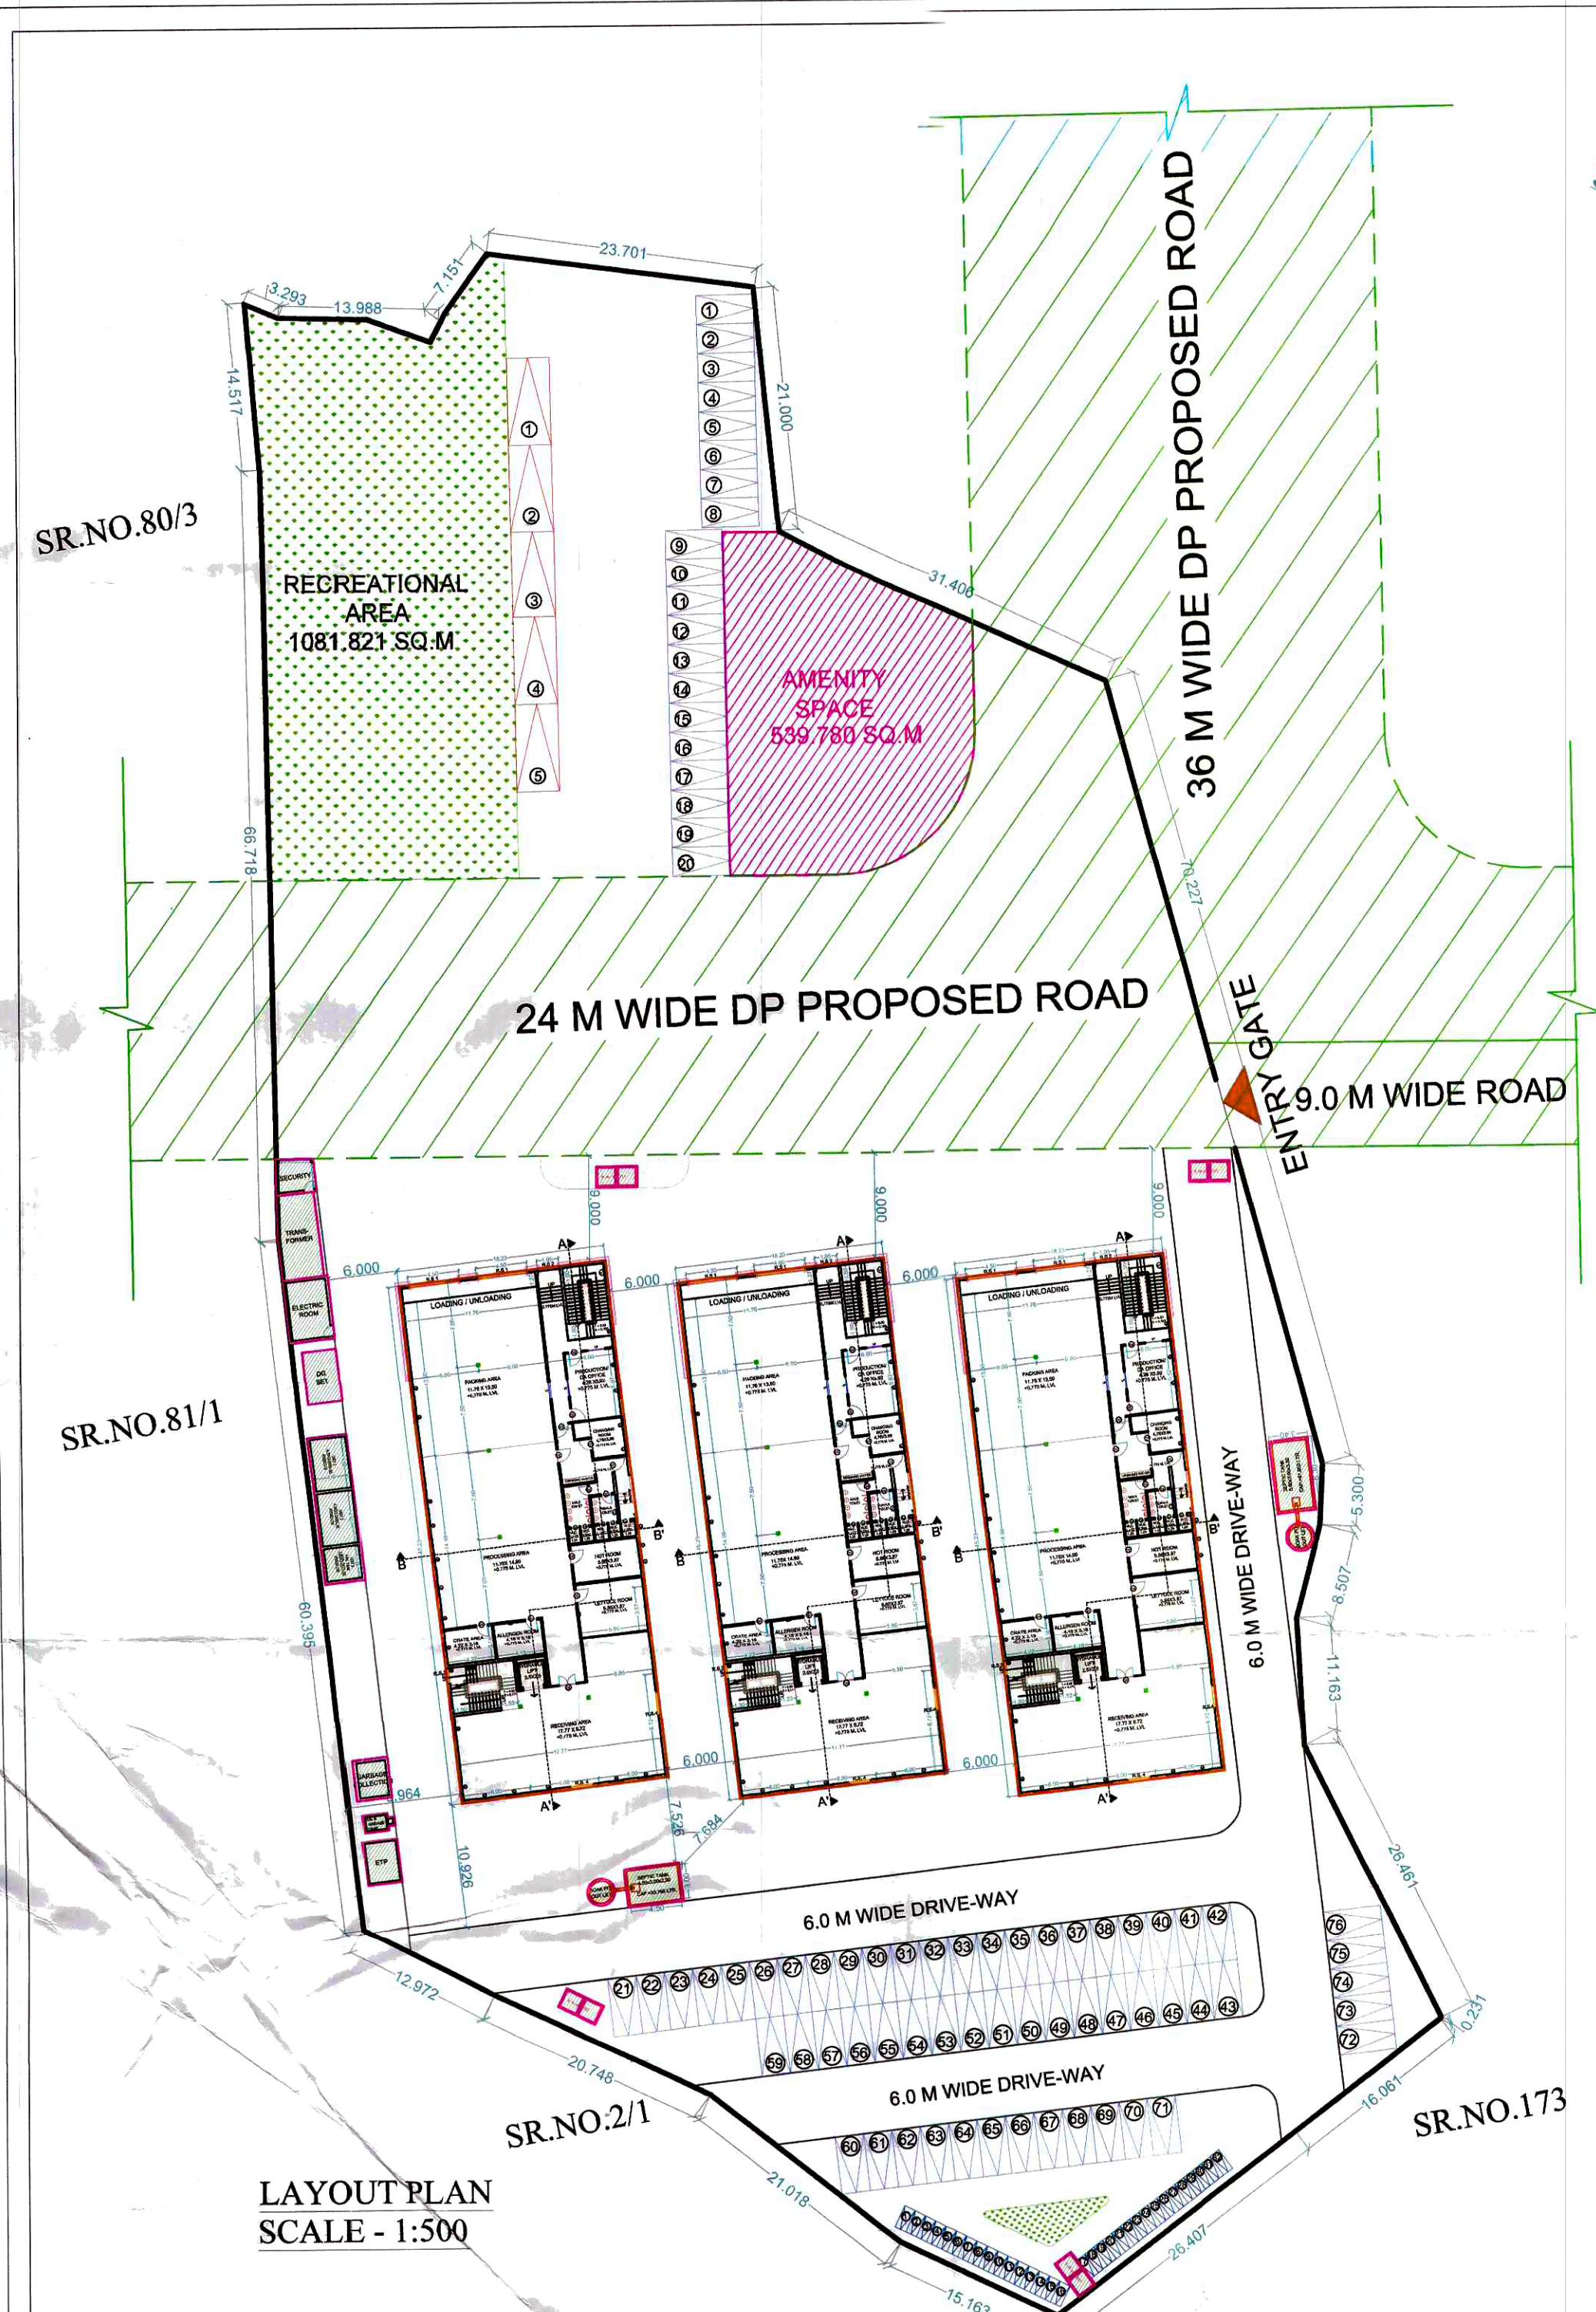

PROFORMA I - For Developments in Urban Village

Sl. No.	Area Statements	Area (sq.m)
1	Area of plot (as per details in (3) Appendix A Item 4)	13004.534
2	Deductions for:	
(a)	Road Acquisition Area	0
(b)	Proposed DP Road Area	2230.956
(c)	Any Reservation	0
(Total a+b+c)		2230.956
3	Gross Area of Plot (1-2)	10773.578
4	Amenity Space required, if any (as per reg. no.20.3)	539.780
5	Net Area of Plot (3-4)	10233.798
6	Addition of area for F.S.I., if any:	
(a)		0
(b)		0
(c)		1
7	Total Area (5+6)	10233.798
8	Recreational open space (Required)	1023.380
	Recreational open space (Proposed)	1081.821
9	Base F.S.I. Permissible	0.70
10	F.S.I. with Payment of premium	0.30
11	Permissible Built-up Area	10233.798
12	Existing Built-up Area	0
13	Proposed Built-up Area	5321.411
14	Total Built-up Area (11+12)	5321.411
15	F.S.I. Consumed (14/7)	0.520

PROFORMA II
Form of Certificate

I, Ar. Navnath L. Gole have been employed by the applicant as his Architect. I have examined the boundaries and the area of the plot and I do hereby certify that I have personally verified and checked all the statements made by the applicant who is the owner / lessee in possession of the plot as in the above form and found them to be correct.

Signature of Architect: *Ar. Navnath L. Gole*

Address: SARASAWATI CHS. PLOT NO. 83 ROOM NO. 21 SECTOR. 12, KHARGHER, NAVI MUMBAI. 410210
 Email ID: adassociates021@gmail.com
 Mobile no: +91-8668982545

DETAILS OF BUILT UP AREA OF INDUSTRIAL SHED

SR.NO.	BUILDING NO.	PREDOMINANT USE	NO. OF FLOORS	BUA IN SQ.M
1	Industrial Shed - 1	Industrial	Ground First Loft	824.543 808.343 140.918
TOTAL				1773.804
TOTAL BUA OF 3 SHEDS				5321.411

OCCUPANT LOAD CALCULATION (As per the Reg. 27.3.2 Table 27.2)

SR. NO.	BLOCK	GROSS AREA (SQ.M)	OCCUPANT LOAD	TOTAL OCCUPANTS
1	GROUND FLOOR	818.293	191.2710	82
2	FIRST FLOOR	818.293	81.829	82
3	LOFT FLOOR	140.918	14.092	14
TOTAL OCCUPANT LOAD FOR 1 SHED				177.390
OCCUPANT LOAD FOR 3 SHEDS				533.251

Marginal Open Space (As per the Reg.No.22.3.10 Table 22.4 in Modified Draft DCPR for NAINA)

SR. No.	Building	Building Sides	Required Open Space	Min. Open Space proposed
1	Industrial shed-1	Front	9.00	9.000
		Rear	9.00	20.519
		Left	6.00	9.564
		Right	6.00	56.259
2	Industrial shed-2	Front	9.00	9.000
		Rear	9.00	25.777
		Left	6.00	6.000
		Right	6.00	6.000
3	Industrial shed-3	Front	9.00	9.000
		Rear	9.00	28.737
		Left	6.00	6.000
		Right	6.00	6.000

FLOOR AREA STATEMENT

SR. NO.	2	3	4	5	6	7	8	9	10	11	12
1	BUILDINGS	TOTAL PROPOSED AREA	PERMISSIBLE TERRACE AREA (15% OF 3)	ENCLOSED TERRACE AREA	OPEN TERRACE AREA	TOTAL TERRACE AREA	PERMISSIBLE TERRACE AREA (20% OF 5)	PROPOSED TERRACE AREA	EXCESS TERRACE AREA		
1	GROUND FLOOR	824.543	123.681	0.000	0.000	123.681	164.909	0.000	0.000		
2	FIRST FLOOR	808.343	121.751	0.000	0.000	121.751	162.669	0.000	0.000		
3	LOFT FLOOR	140.918	21.138	0.000	0.000	21.138	28.384	0.000	0.000		
4	TOTAL	1773.804	266.571	0.000	16.200	282.771	355.962	0.000	0.000		
5	TOTAL EXCESS BALCONY	0.000									
6	TOTAL EXCESS TERRACE	0.000									
7	TOTAL BUILT UP AREA FOR 3 SHEDS	5321.411									

DP ROAD AREA CALCULATION



SR. NO.	0.50	BASE	HEIGHT	AREA (SQ.M)
1	0.5	54.868	21.753	596.772
2	0.5	84.015	24.000	1008.180
AREA AS PER P LINE				312.568
4	0.5	42.668	12.090	257.928
5	0.5	12.770	8.693	55.505
TOTAL AREA OF PLOT				2230.953

Area as per 7/12 extract

No.	Survey No.	Village Name	Owner Name	Area (SQ.M.)
1	174/1		MR.ANOOP SINGH	9250
2	174/2	SHIRDHON	SATNAM SINGH & 2 OTHERS	4000
3	173/B			2300
Total				15550

TILR BOUNDARY AREA CALCULATION

SR. NO.	0.50	BASE	HEIGHT	AREA (SQ.M)
1	0.5	14.836	2.918	21.646
2	0.5	20.539	9.227	94.757
3	0.5	27.759	5.350	74.255
4	0.5	46.209	6.940	160.345
5	0.5	45.769	20.735	474.510
6	0.5	75.295	39.877	1501.269
7	0.5	86.885	26.684	1159.220
8	0.5	116.034	82.745	4800.617
9	0.5	121.915	51.877	3162.292
10	0.5	96.141	12.798	615.206
11	0.5	90.173	13.623	614.201
12	0.5	50.422	12.942	326.216
TOTAL AREA OF PLOT				13004.534

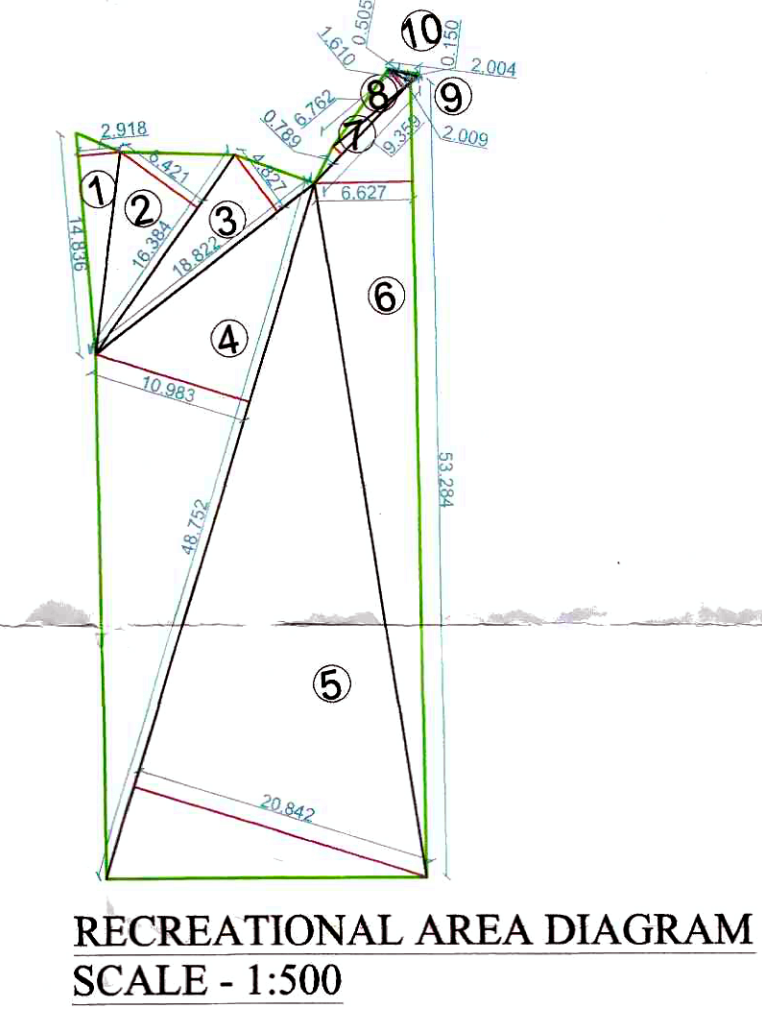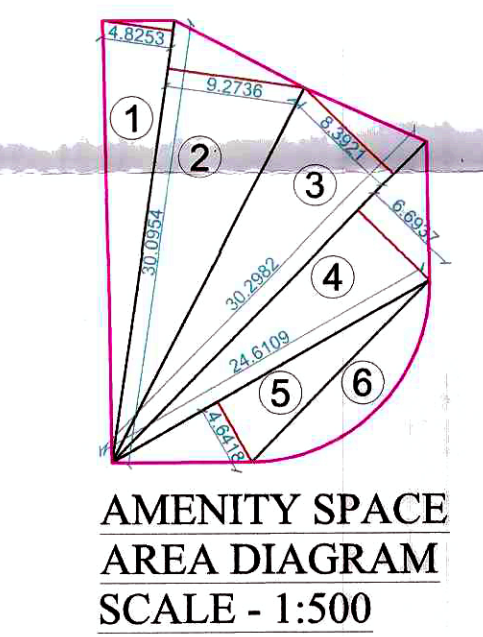

AMENITY SPACE AREA CALCULATION

SR. NO.	0.50	BASE	HEIGHT	AREA (SQ.M)
1	0.5	30.095	4.825	72.610
2	0.5	30.095	9.274	139.546
3	0.5	30.298	8.392	127.134
4	0.5	30.298	6.694	101.404
5	0.5	24.611	4.642	57.120
6		AREA AS PER P-LINE		41.967
TOTAL AREA OF PLOT				539.780

R.G SPACE AREA CALCULATION

SR. NO.	0.50	BASE	HEIGHT	AREA (SQ.M)
1	0.5	14.836	2.918	21.645
2	0.5	16.384	6.421	52.806
3	0.5	18.822	4.827	45.428
4	0.5	48.752	10.983	267.727
5	0.5	48.752	20.842	508.057
6	0.5	53.284	6.627	176.566
7	0.5	9.359	0.789	3.690
8	0.5	6.762	1.610	5.444
9	0.5	2.009	0.505	0.507
10	0.5	2.004	0.150	0.150
TOTAL AREA OF PLOT				1081.821

CONTENT OF SHEET

- 1 LOCATION PLAN
- 2 LAYOUT PLAN
- 3 SITE AREA DIAGRAM AND CALCULATION
- 4 RG AREA DIAGRAMS AND CALCULATIONS
- 5 TOTAL BUILT-UP AREA STATEMENT
- 6 PROFORMA
- 7 OCCUPANT LOAD CALCULATION
- 8 AMENITY SPACE AREA DIAGRAM & CALCULATION
- 9 FLOOR AREA STATEMENT
- 10 7/12 AREA STATEMENT

NAME & SIGNATURE OF OWNER

MR. ANOOP SINGH SATNAM SINGH	<i>Anoop Singh</i>
MR. TARUN SINGH ANOOP SINGH	<i>Tarun Singh</i>
MR. RAVNEET SINGH ANOOP SINGH	<i>Ravneet Singh</i>

DESCRIPTION OF PROPOSAL & PROPERTY

PROPOSED INDUSTRIAL DEVELOPMENT ON LAND BEARING SURVEY NO. 174/1, 174/2, 173/B OF VILLAGE - SHIRDHON, TALUKA - PANVEL, DIST-RAIGAD

NAME & SIGN. OF ARCHITECT

Ar. Navnath L. Gole
Ar. NAVNATH GOLE
 CA/2017/85526
 AR. NAVNATH L. GOLE

DATE	DRAWN BY	CHKD BY	SCALE	NORTH
10-04-2023	JCG	NLG	1:500	
				AYD.23.OV.0514







AR. NAVNATH L. GOLE.
 CA/2017/85526, (B.A.RCH)
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SARASAWATI CHS. PLOT NO. 83 ROOM NO. 21 SECTOR. 12, KHARGHER, NAVI MUMBAI. 410210



STAMP OF APPROVAL 2/5

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 Dated: 31 January 2024

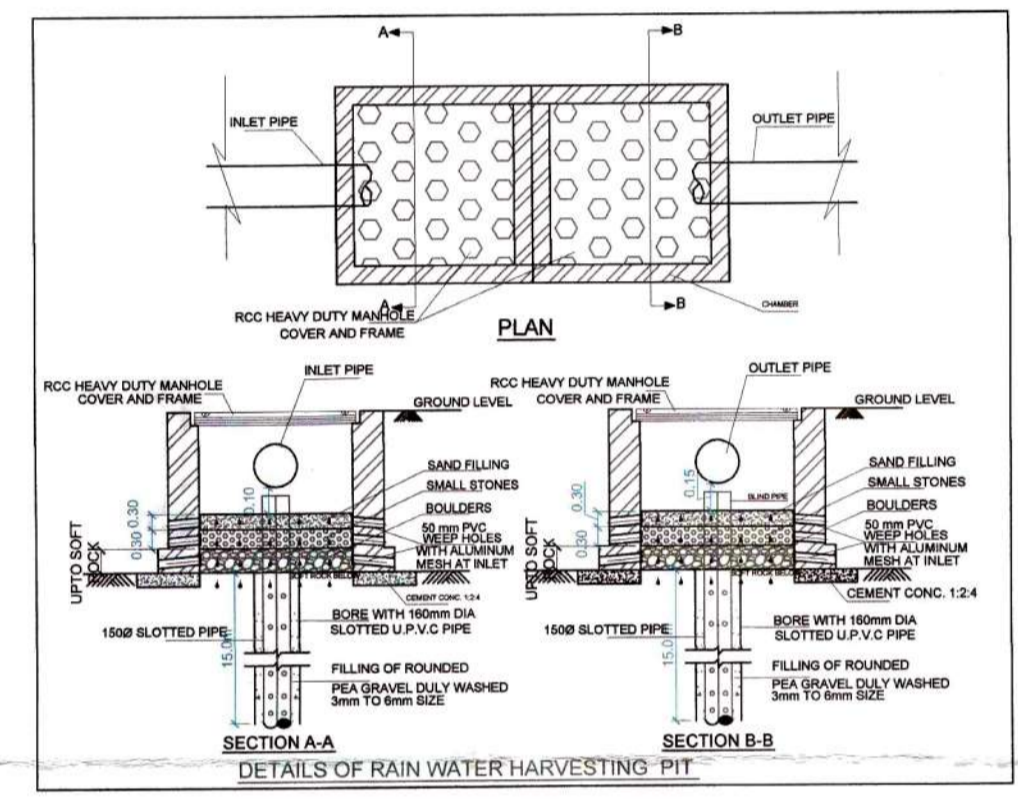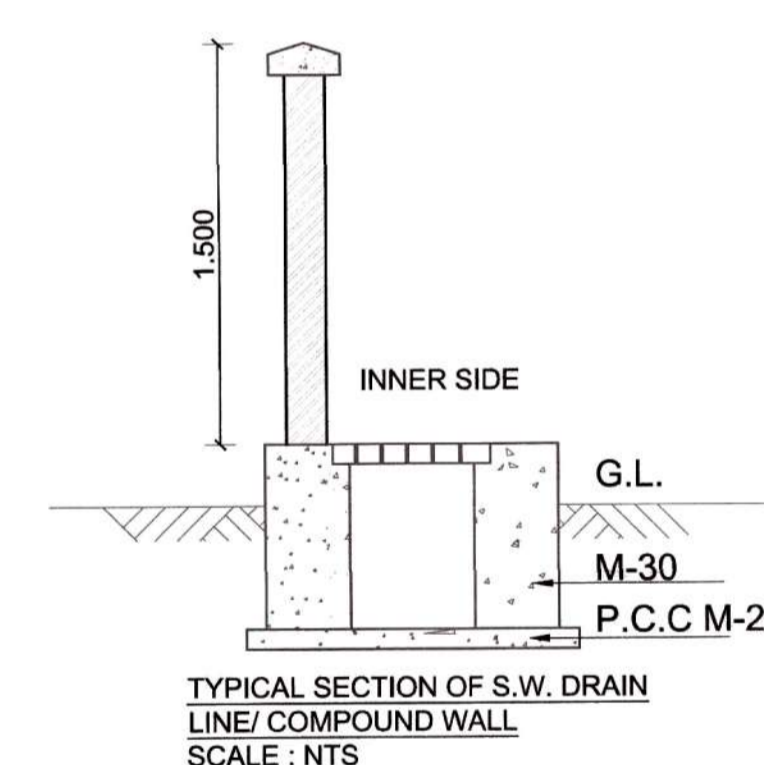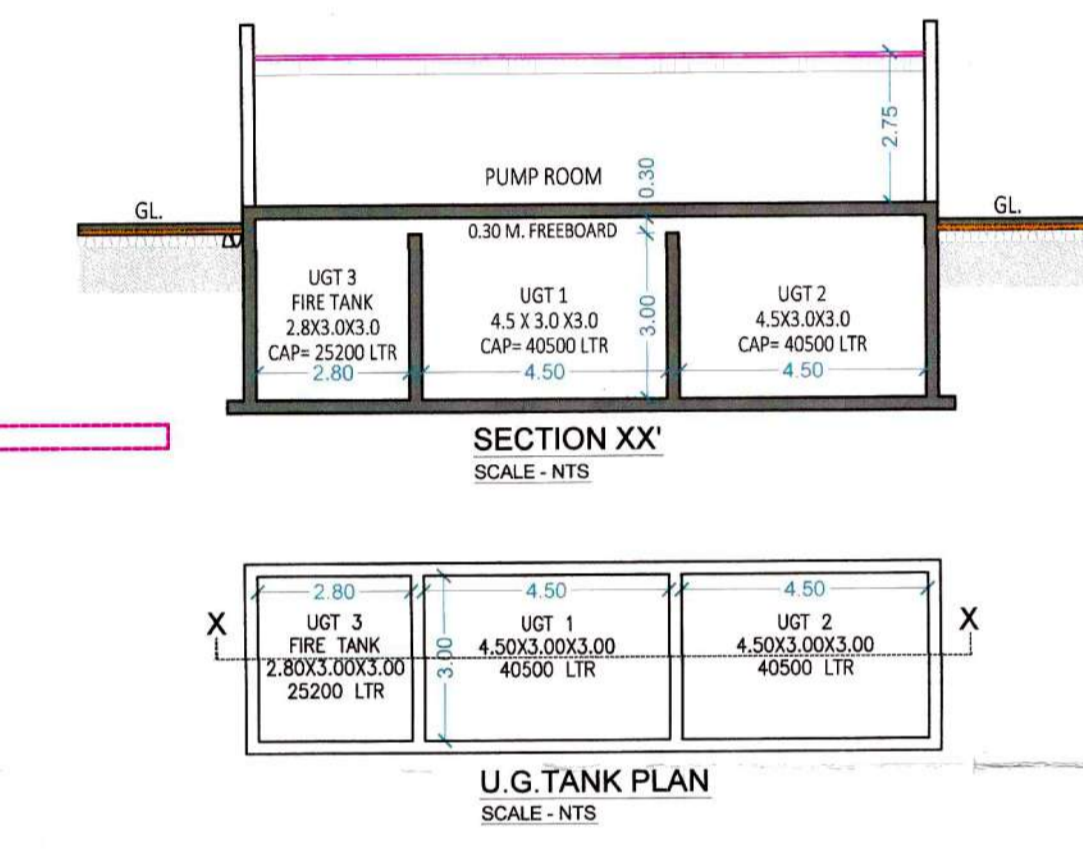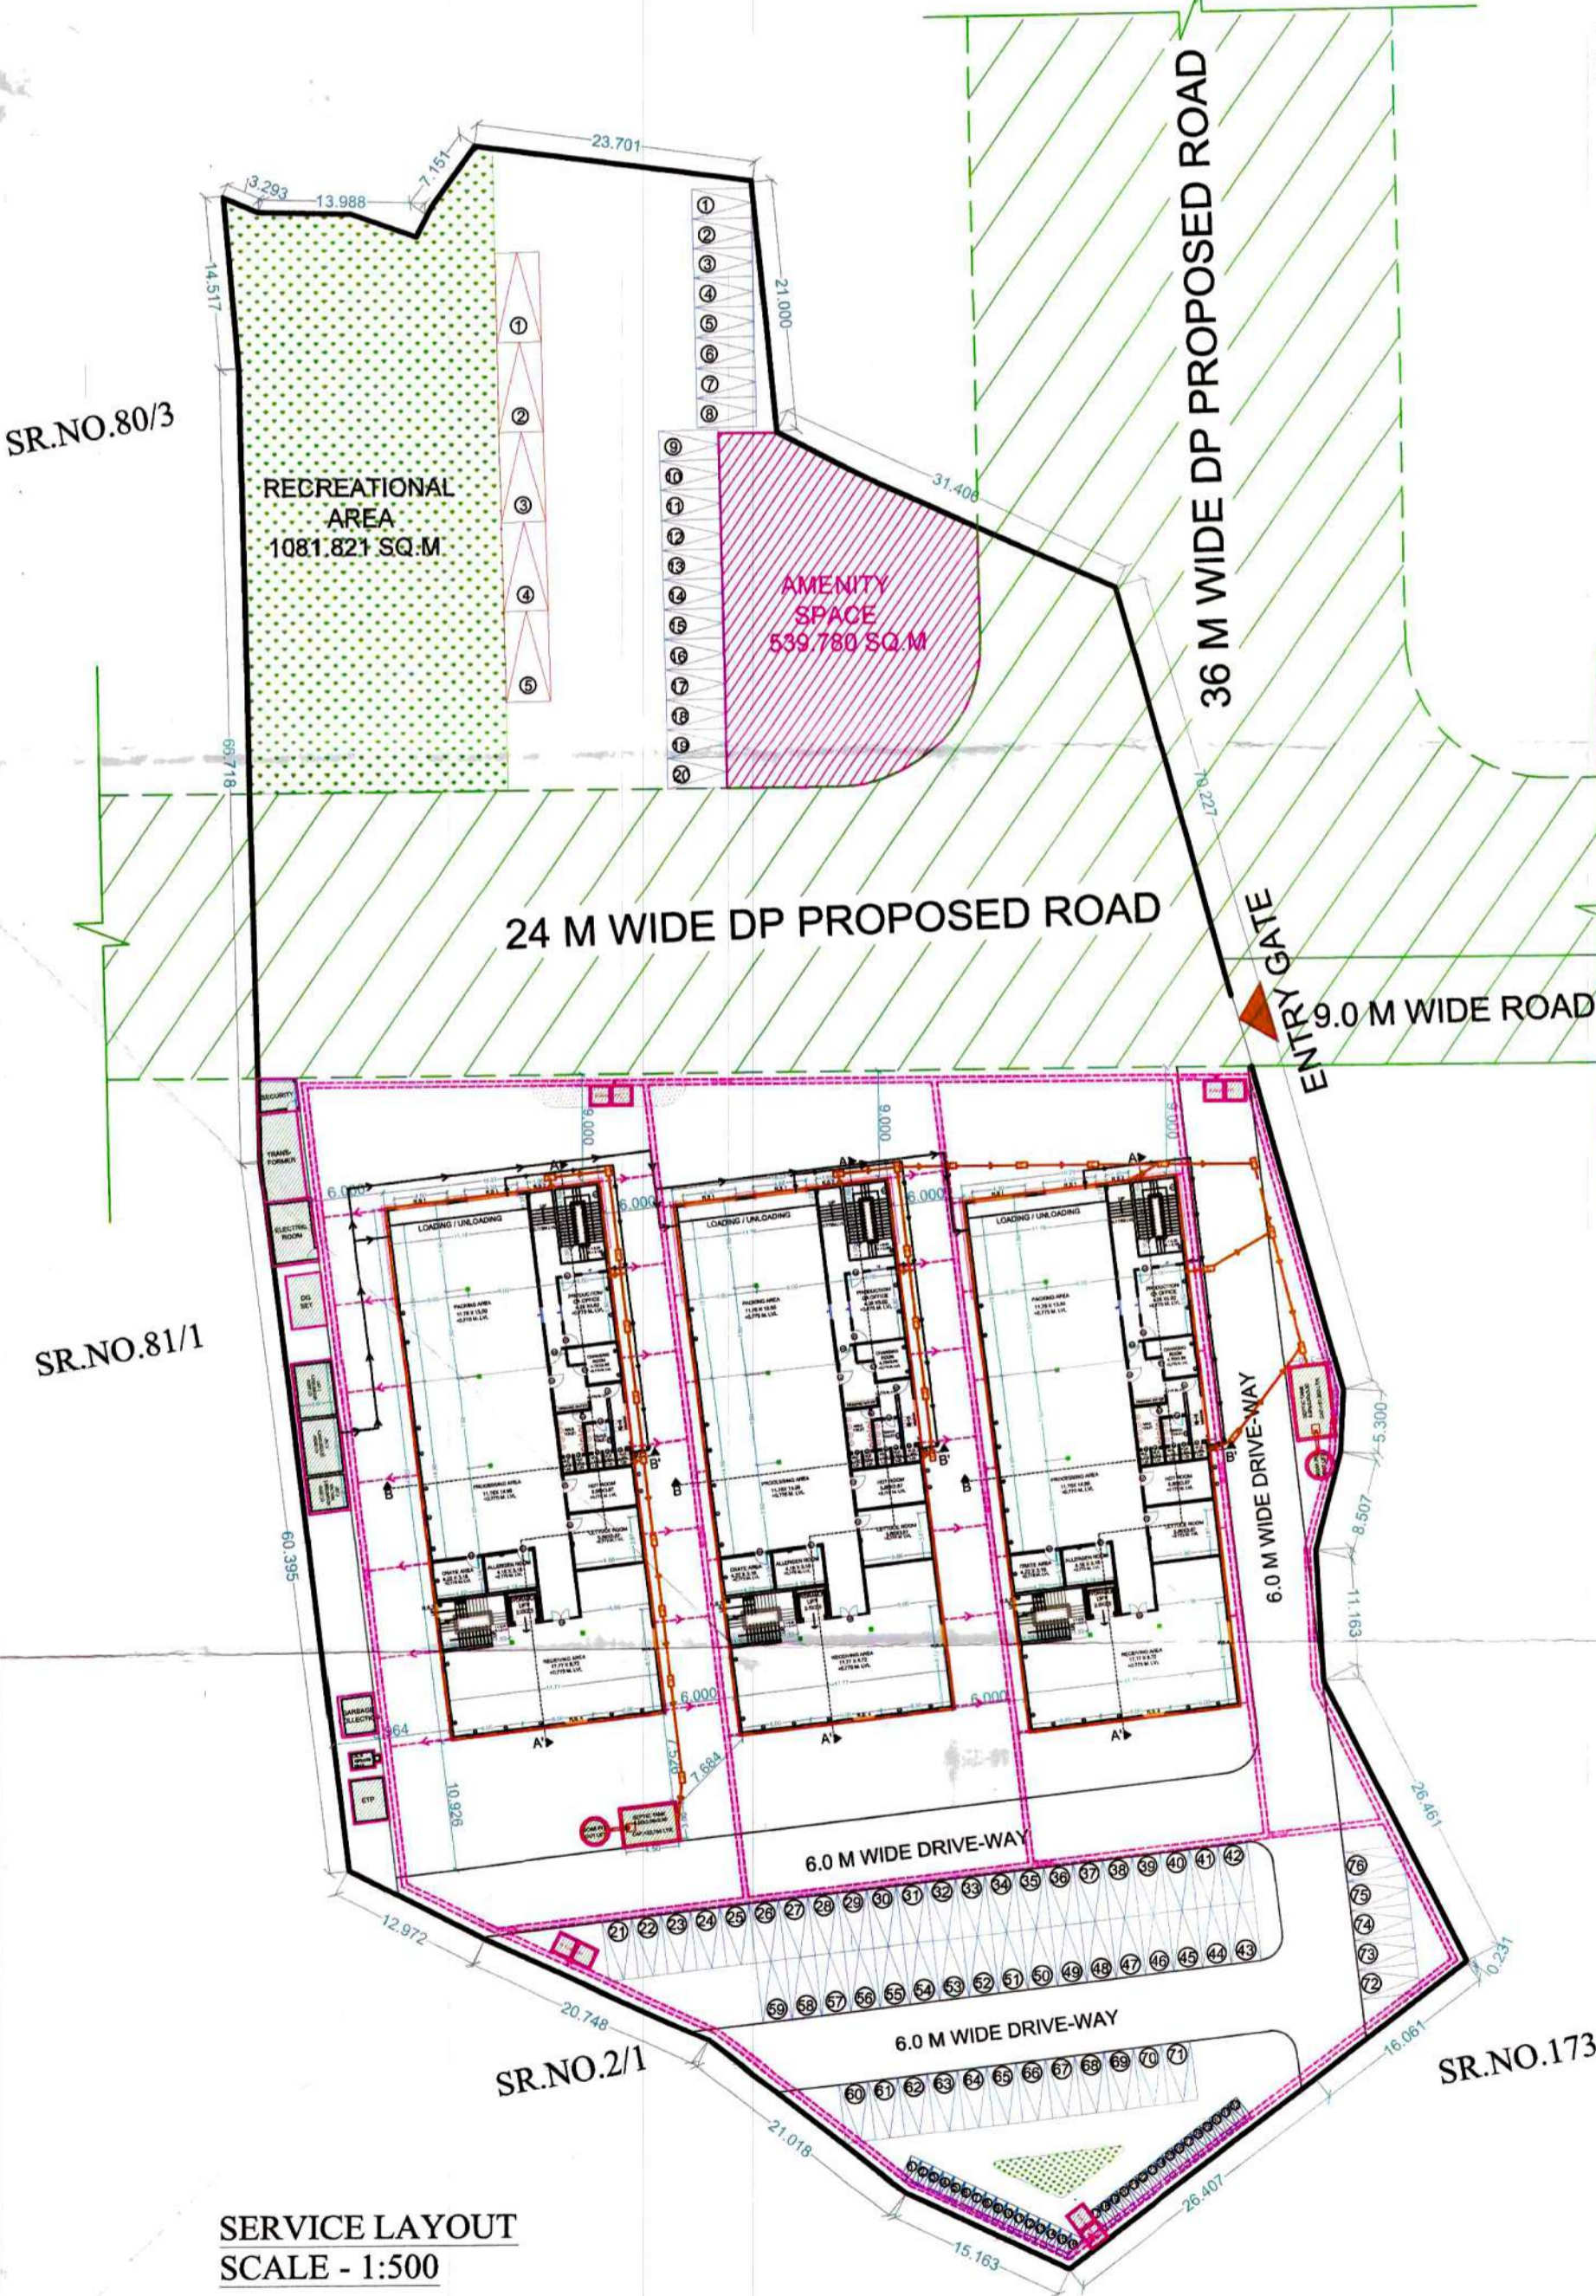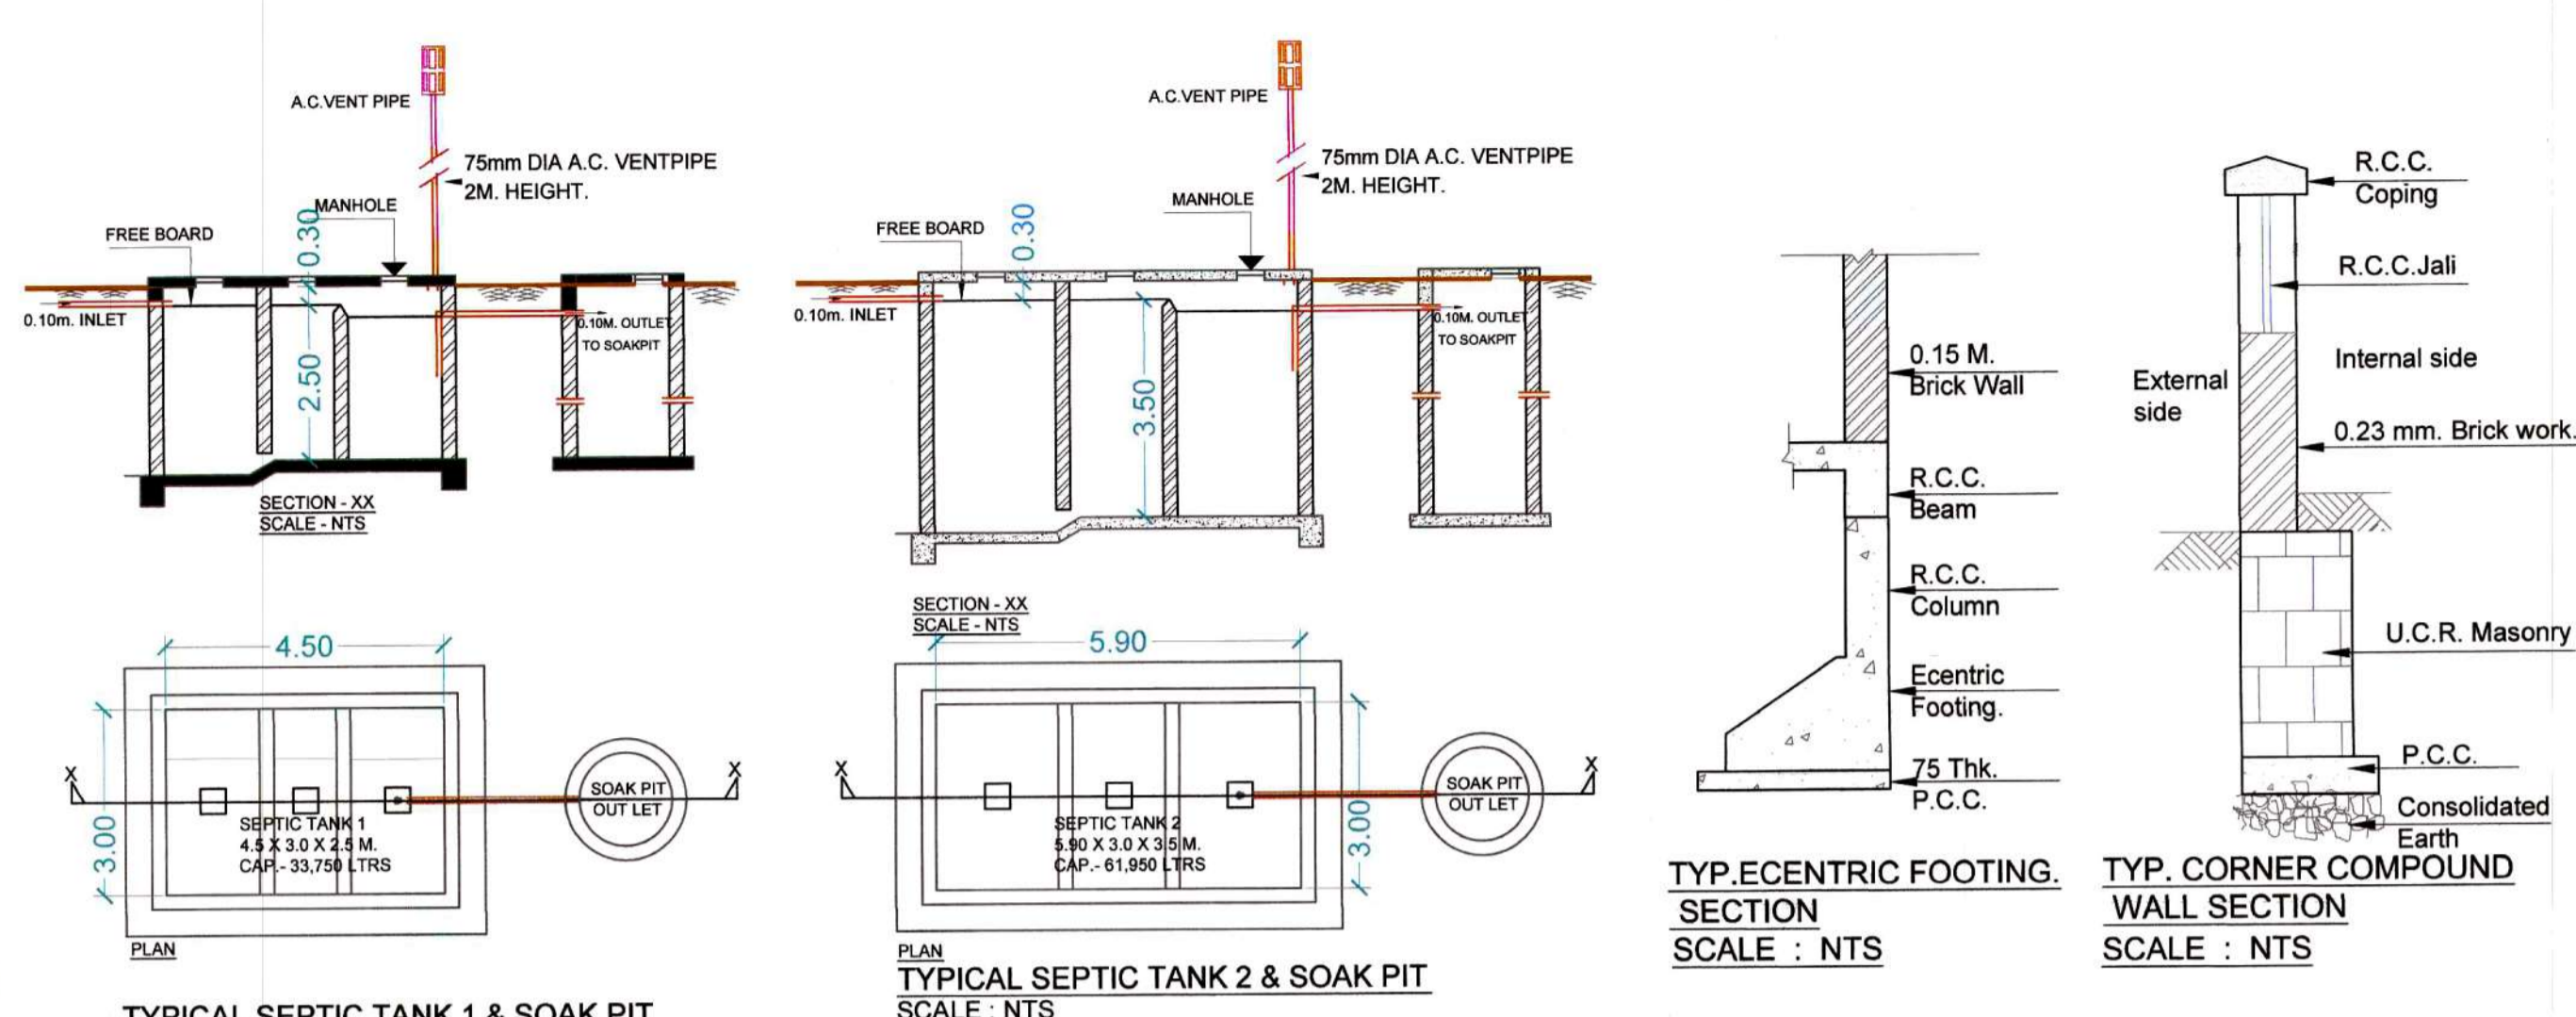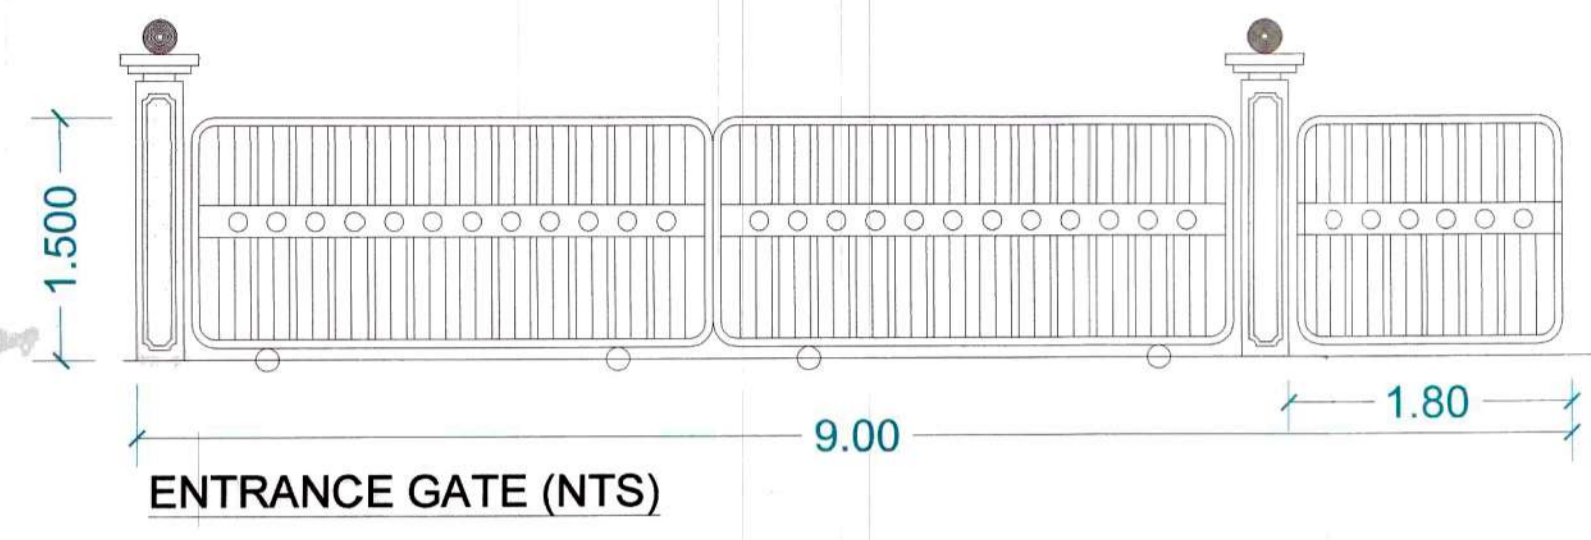

OVERHEAD WATER TANK CAPACITY CALCULATION

BUILDING NO.	OHT WATER REQUIRED (LITER) 50% OF UGT WATER REQUIREMENT		COLD WATER REQUIREMENT TANK SIZE		CAPACITY (LITER)
	REQUIRED (LITER) 50% OF UGT WATER	REQUIRED (LITER) 50% OF UGT WATER	(METER)	NUMBER OF TANK	
INDUSTRIAL SHED 1	10570	5000	3.0x2.5x2.0	1	15000
INDUSTRIAL SHED 2	10570	5000	3.0x2.5x2.0	1	15000
INDUSTRIAL SHED 3	10570	5000	3.0x2.5x2.0	1	15000
Total	31709	15000		3	45000

Note:-
 i Overhead Water Tank Capacity shall be minimum 50% of Required Water Capacity
 ii Size of Overhead Water Tank is excluding the Free Board

WATER STORAGE CAPACITY CALCULATION

BUILDING NUMBER	URINALS	WC	POPULATION	WATER REQUIREMENT (LITER)					UNDERGROUND WATER TANK PROVIDED			
				(DOMESTIC) POPULATION	(FLUSHING) ONE W.C. SEAT	(FLUSHING) ONE URINAL SEAT	TOTAL FLUSHING	DOMESTIC + FLUSHING	FIRE	TANK NUMBER	SIZE (M)	CAPACITY (LITER)
INDUSTRIAL SHED-1	8	13	178	7999	11700	1440	13140	21139	25000	UGT 1	4.50X3.00X3.00	40,500
INDUSTRIAL SHED-2	8	13	178	7999	11700	1440	13140	21139	25000	UGT 2	4.50X3.00X3.00	40,500
INDUSTRIAL SHED-3	8	13	178	7999	11700	1440	13140	21139	25000	FIRE TANK UGT 3	2.80X3.00X3.00	25,200
TOTAL			533	23996			39420	63416	25000			1,06,200

SEPTIC TANK REQUIREMENT

BUILDING NUMBER	NUMBER OF PERSONS	TOTAL WC/URINALS	WATER REQUIREMENT				FLOW TO SEWER				TOTAL FLOW TO SEPTIC TANK PROVIDED					
			FLUSHING LPD	DOMESTIC LPD	TOTAL LPD	FLUSHING (100%) LPD	DOMESTIC (85%) LPD	TOTAL LPD	TANK NO.	SIZE	CAPACITY					
INDUSTRIAL SHED-1	178	8	180	900	1440	11700	45	8010	21150	13140.00	6808.50	19948.50	19949	1	4.5X3.0X2.5	33750
INDUSTRIAL SHED-2	178	8	180	900	1440	11700	45	8010	21150	13140.00	6808.50	19948.50	19949	2	5.9X3.0X3.5	61950
INDUSTRIAL SHED-3	178	8	180	900	1440	11700	45	8010	21150	13140.00	6808.50	19948.50	19949			
TOTAL																95700

LEGEND :

1	Plot Line	—————
2	Drainage & Sewerage Work	-----
3	Water Supply Work	-----
4	RWH Line	-----

CONTENT OF SHEET

- SERVICE LAYOUT
- LEGEND
- DETAIL OF SEPTIC TANK AND SOAK PIT
- DETAIL OF ENTRANCE GATE
- DETAIL OF U.G TANK AND CALCULATION
- DETAIL OF COMPOUND WALL
- DETAIL OF ECCENTRIC FOOTING AND CORNER COMPOUND WALL
- DETAIL OF RAIN WATER HARVESTING PIT
- CALCULATION OF OVERHEAD WATER TANK
- CALCULATION OF SEPTIC TANK

NAME & SIGNATURE OF OWNER

MR. ANOOP SINGH SATNAM SINGH	<i>Anoop Singh</i>
MR. TARUN SINGH ANOOP SINGH	<i>Tarun Singh</i>
MR. RAVNEET SINGH ANOOP SINGH	<i>Ravneet Singh</i>

DESCRIPTION OF PROPOSAL & PROPERTY

PROPOSED INDUSTRIAL DEVELOPMENT ON LAND BEARING SURVEY NO.174/1, 174/2 & 173/B OF VILLAGE - SHIRDHON, TALUKA - PANVEL, DIST-RAIGAD

NAME & SIGN. OF ARCHITECT

Ar. NAVNATH GOLE
 CA/2017/85526
 AR. NAVNATH L. GOLE

DATE	DRAWN BY	CHKD. BY	SCALE	NORTH
10-04-2023	JCG	NLG	1:500	

AYD.23.OV.0515


Ar. NAVNATH L GOLE.
 CA/2017/85526, (B. ARCH)
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SARASAWATI CHS. PLOT NO. 83
 ROOM NO. 21 SECTOR. 12,
 KHARGHER, NAVI MUMBAI. 410210


ADA
 AD ASSOCIATES

SERVICE LAYOUT
 SCALE - 1:500


STAMP OF APPROVAL 3/5
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 Dated: 31 January 2024

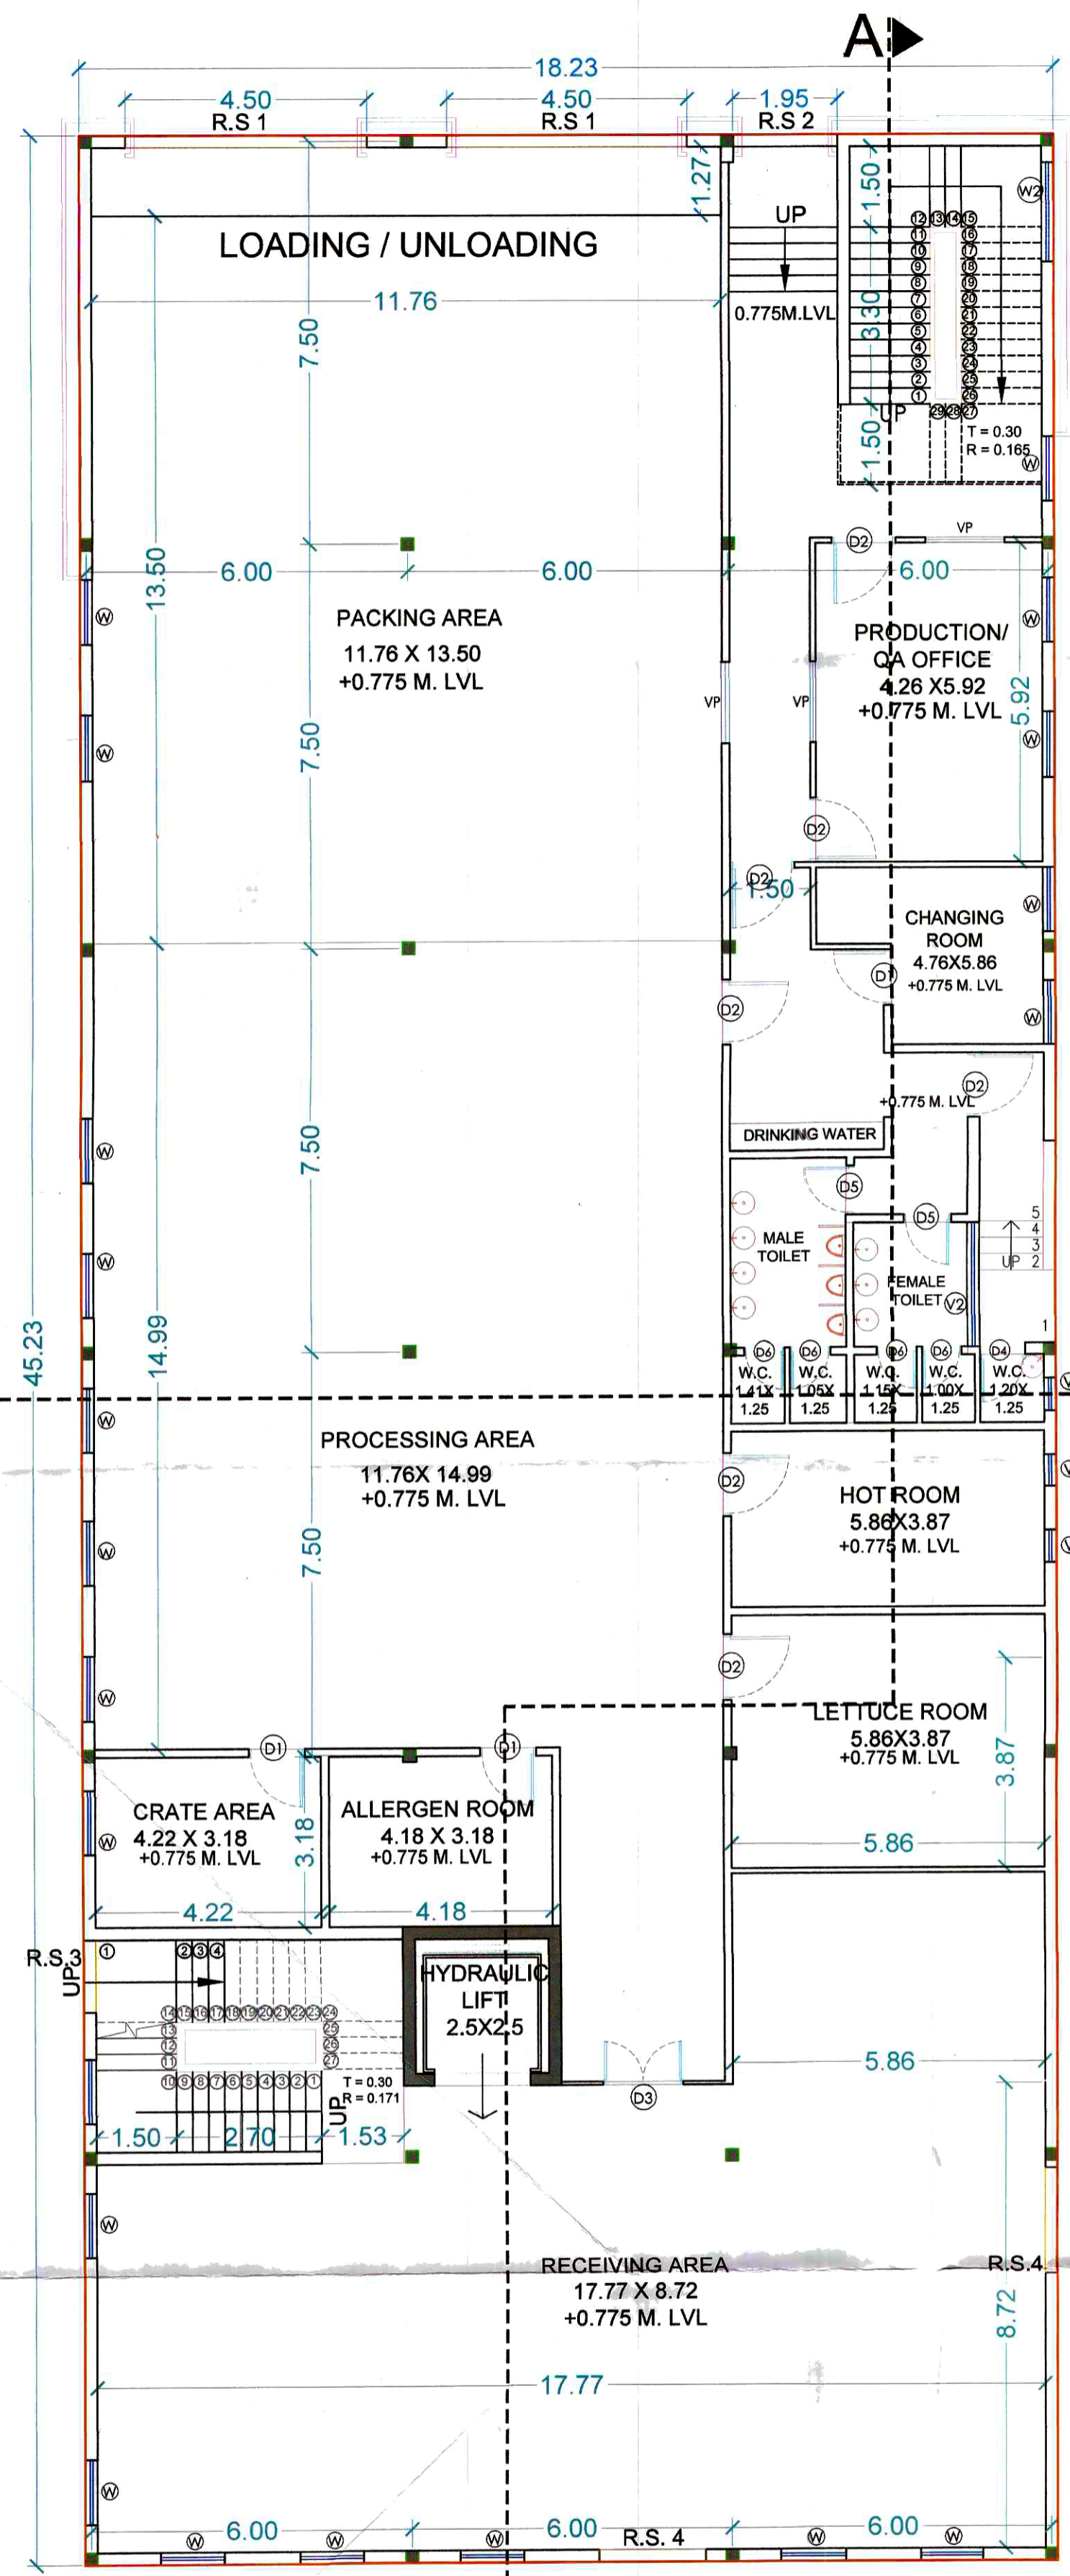

GROUND FLOOR PLAN
SCALE - 1:100

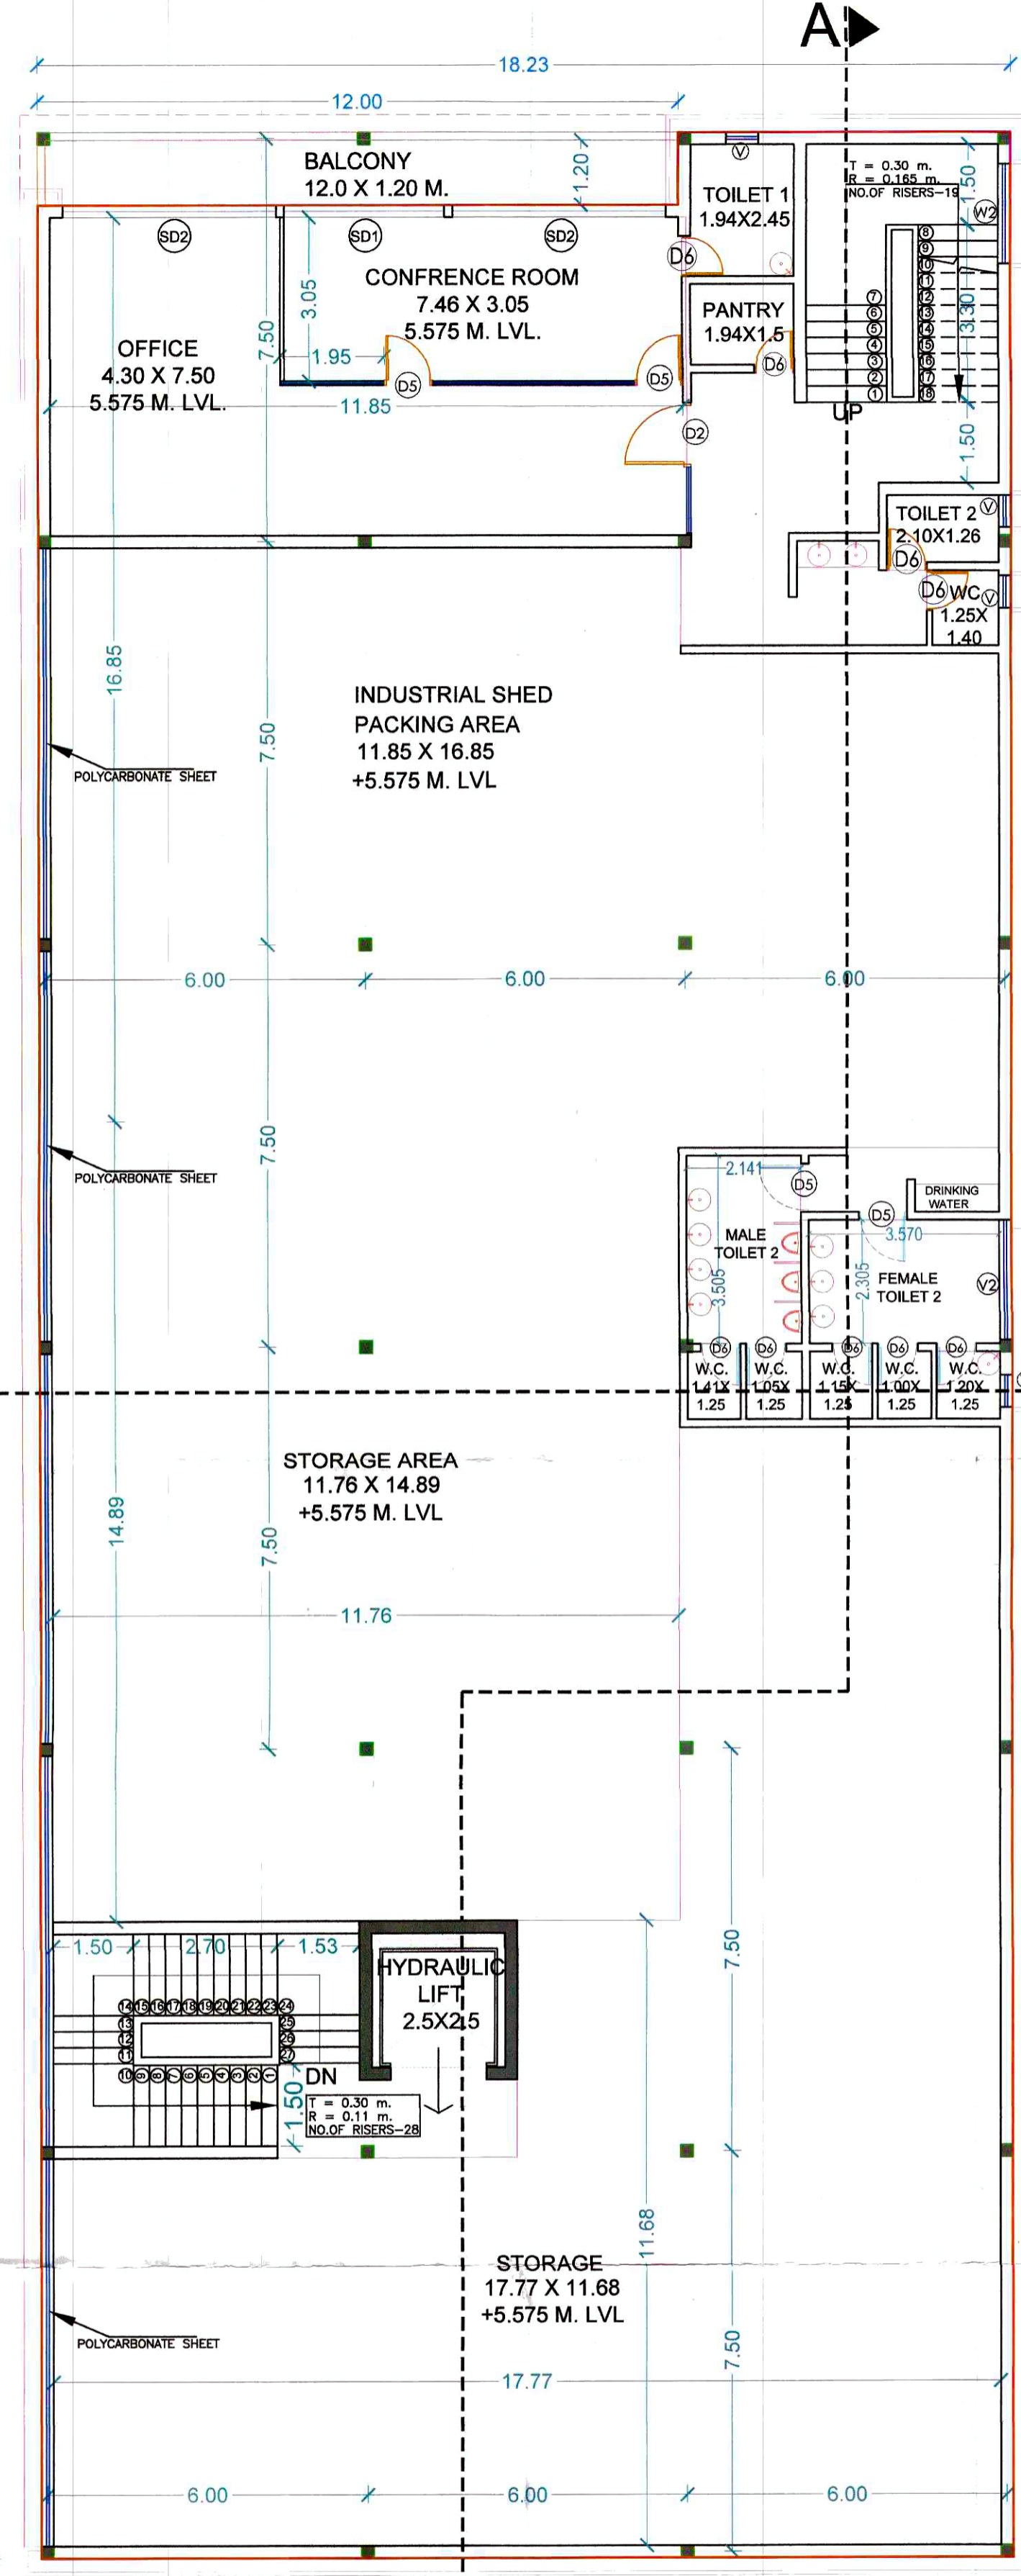

FIRST FLOOR PLAN
SCALE - 1:100

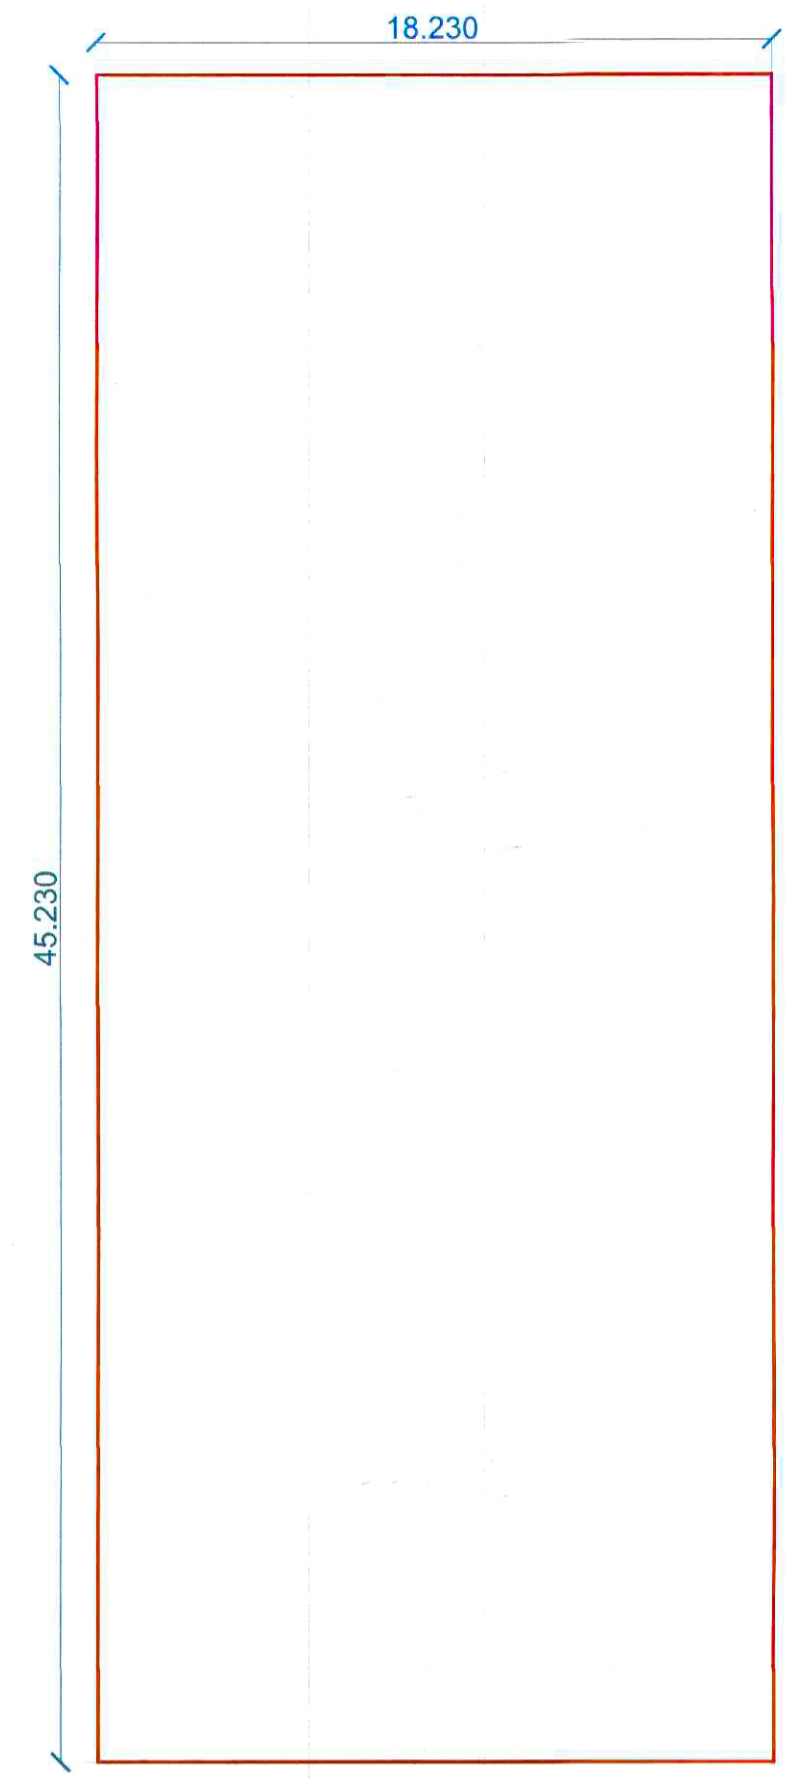

GROUND FLOOR AREA DIAGRAM
SCALE - 1:200



FIRST FLOOR AREA DIAGRAM
SCALE - 1:200

SANITATION REQUIREMENT TABLE								
Sr. No.	Fixtures	WORKERS		Occupant load	Required			
		Male	Female		Male	Female		
i)	Water-closets (Workers & Staff)	1 for up to 15 2 for 16-35 3 for 36-65 4 for 66-100	1 for up to 12 2 for 13-25 3 for 26-40 4 for 41-57 5 for 58-77 6 for 78-100		4	4	6	5
	For persons 101-200 add	3%	5%		1	0	2	0
	For persons over 200 add	2.5%	4%	178 (134 MALE, 44 FEMALES)	0	0	0	0
ii)	Urinals	Nil up to 5 1 for 7-30 2 for 31-45 3 for 46-70 4 for 71-100			4		6	
	For persons 101-200 add	3%			1		2	
	For persons over 200 add	2.5%			0		0	

GROUND FLOOR AREA CALCULATION (INDUSTRIAL)				
Description	Length	Breadth	No.	Area in sqm
Block	18.230	X	45.230	824.543
(A)			Total	824.543

FIRST FLOOR AREA CALCULATION (INDUSTRIAL)				
Description	Length	Breadth	No.	Area in sqm
Block	12.000	X	45.230	542.760
(A)			Total	542.760
Deductions				
1	12.000	X	1.350	16.200
(B)			Total	16.200
			Total Area	808.343

LIGHT & VENTILATION SCHEDULE - GROUND FLOOR						
ROOM	CARPET AREA (SQ.M)	WINDOW TYPE	NO. OF WINDOW W	L&V REQUIRE D (SQ.M)	L&V PROVIDED (SQ.M)	
(01)	(02)	(03)	(04)	(05)= (02)/(04)	(06)= (05)/(04)	
PACKING & PROCESSING AREA	368.98	RS1	11.25	2	36.90	22.50
		W	2.88	7	20.16	42.66
		RS4	3.36	1	3.36	
RECEIVING AREA	195.67	RS3	5.70	1	19.57	44.06
		W	7.00	5	35.00	
CHANGING ROOM	11.50	W	2.88	2	1.15	5.76
PRODUCTION/QA OFFICE	25.27	W	2.88	2	2.53	5.76
CRATE AREA	13.58	W	2.88	1	1.36	2.88
MALE & FEMALE TOILET 1	19.19	V2	2.07	1	1.92	2.07
DRIVERS TOL	1.90	V2	0.54	1	0.54	0.54

LIGHT & VENTILATION SCHEDULE - FIRST FLOOR						
ROOM	CARPET AREA (SQ.M)	WINDOW TYPE	NO. OF WINDOW W	L&V REQUIRE D (SQ.M)	L&V PROVIDED (SQ.M)	
(01)	(02)	(03)	(04)	(05)= (02)/(04)	(06)= (05)/(04)	
PACKING & STORAGE AREA	356.30	POLYCARBONATE SHEET	11.99	3	35.63	35.97
STORAGE AREA	224.47	POLYCARBONATE SHEET	11.99	2	22.45	23.98
CONFERENCE & OFFICE	70.60	SD1	6.30	1	7.06	23.30
		SD2	8.40	2	16.80	
MALE & FEMALE TOI 1	24.34	V	0.54	1	2.43	2.61
TOILET 1	4.57	V2	2.07	1	2.07	1.08
TOILET 2	4.87	V	0.54	1	4.87	0.54

SCHEDULE OF DOOR & WINDOW				
TYPE	LENGTH	HEIGHT	SILL	DISCRPTION
RS1	4.50	4.50	20.25	ROLLING SHUTTER
RS2	1.94	2.85	5.58	ROLLING SHUTTER
RS3	2.00	2.85	5.70	ROLLING SHUTTER
RS4	1.40	2.40	3.36	ROLLING SHUTTER
W	1.20	2.40	2.88	AL - SLIDING WINDOW
W1	1.85	0.60	1.11	AL - SLIDING WINDOW
V	0.60	0.90	0.54	LOUVERED WINDOW
V2	2.30	0.90	2.07	LOUVERED WINDOW
D1	1.05	2.10	2.21	TW PANEL DOOR
D2	1.20	2.10	2.52	TW PANEL DOOR
D3	1.50	2.10	3.15	TW PANEL DOOR
D4	0.85	2.10	1.79	TW PANEL DOOR
D5	0.90	2.10	1.89	TW PANEL DOOR
D6	0.75	2.10	1.58	FLUSH DOOR
SD1	3.00	2.10	6.30	AL - SLIDING DOOR
SD2	4.00	2.10	8.40	AL - SLIDING DOOR
PS	7.24	1.65	11.99	POLY CARBONATE SHEET

NOTE:- All Dimensions Are in Meter.

SHEET CONTENT :-
 1. GROUND FLOOR PLAN
 2. GROUND FLOOR AREA DIAGRAM AND CALCULATION
 3. FIRST FLOOR PLAN
 4. FIRST FLOOR AREA DIAGRAM AND CALCULATION
 5. DOOR AND WINDOW SCHEDULE
 6. LIGHT & VENTILATION SCHEDULE GROUND FLOOR
 7. LIGHT & VENTILATION SCHEDULE FIRST & LOFT FLOOR

NAME & SIGNATURE OF OWNER
 MR. ANOOP SINGH SATNAM SINGH
 MR. TARUN SINGH ANOOP SINGH
 MR. RAVNEET SINGH ANOOP SINGH


DESCRIPTION OF PROPOSAL & PROPERTY
 PROPOSED INDUSTRIAL DEVELOPMENT ON LAND BEARING SURVEY NO.174/1, 174/2, 173/8 OF VILLAGE - SHIRDHON, TALUKA - PANVEL, DIST-RAIGAD

NAME & SIGN. OF ARCHITECT
AR. NAVNATH GOLE
 CA/2017/85528
 AR. NAVNATH L. GOLE

DATE: 10.04.2023 DRAWN BY: JCG CHKD BY: NLG SCALE: 1:100 NORTH:


AR. NAVNATH L. GOLE, CA/2017/85528, (B.ARCH) + 91 - 8 6 6 8 9 8 2 5 4 5

STAMP OF APPROVAL 4/5
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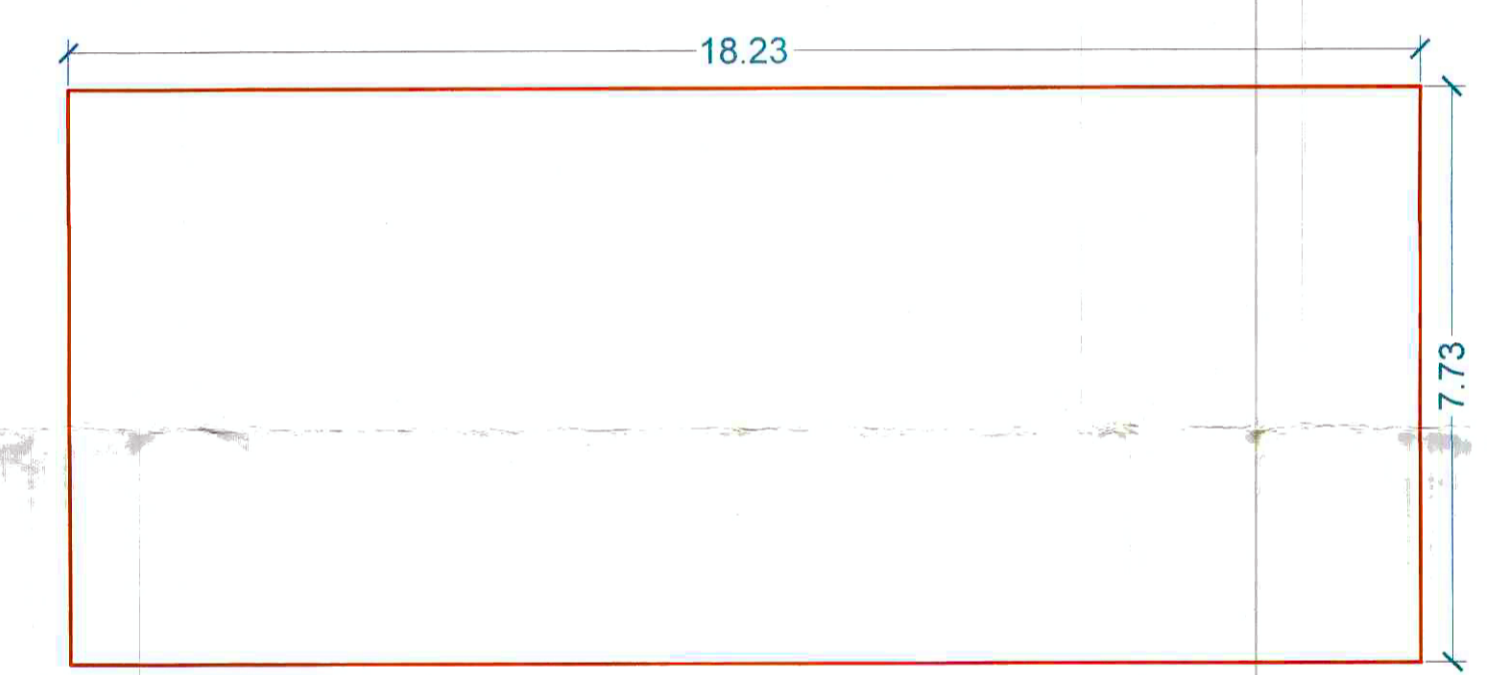
LOFT FLOOR PLAN
SCALE - 1:100

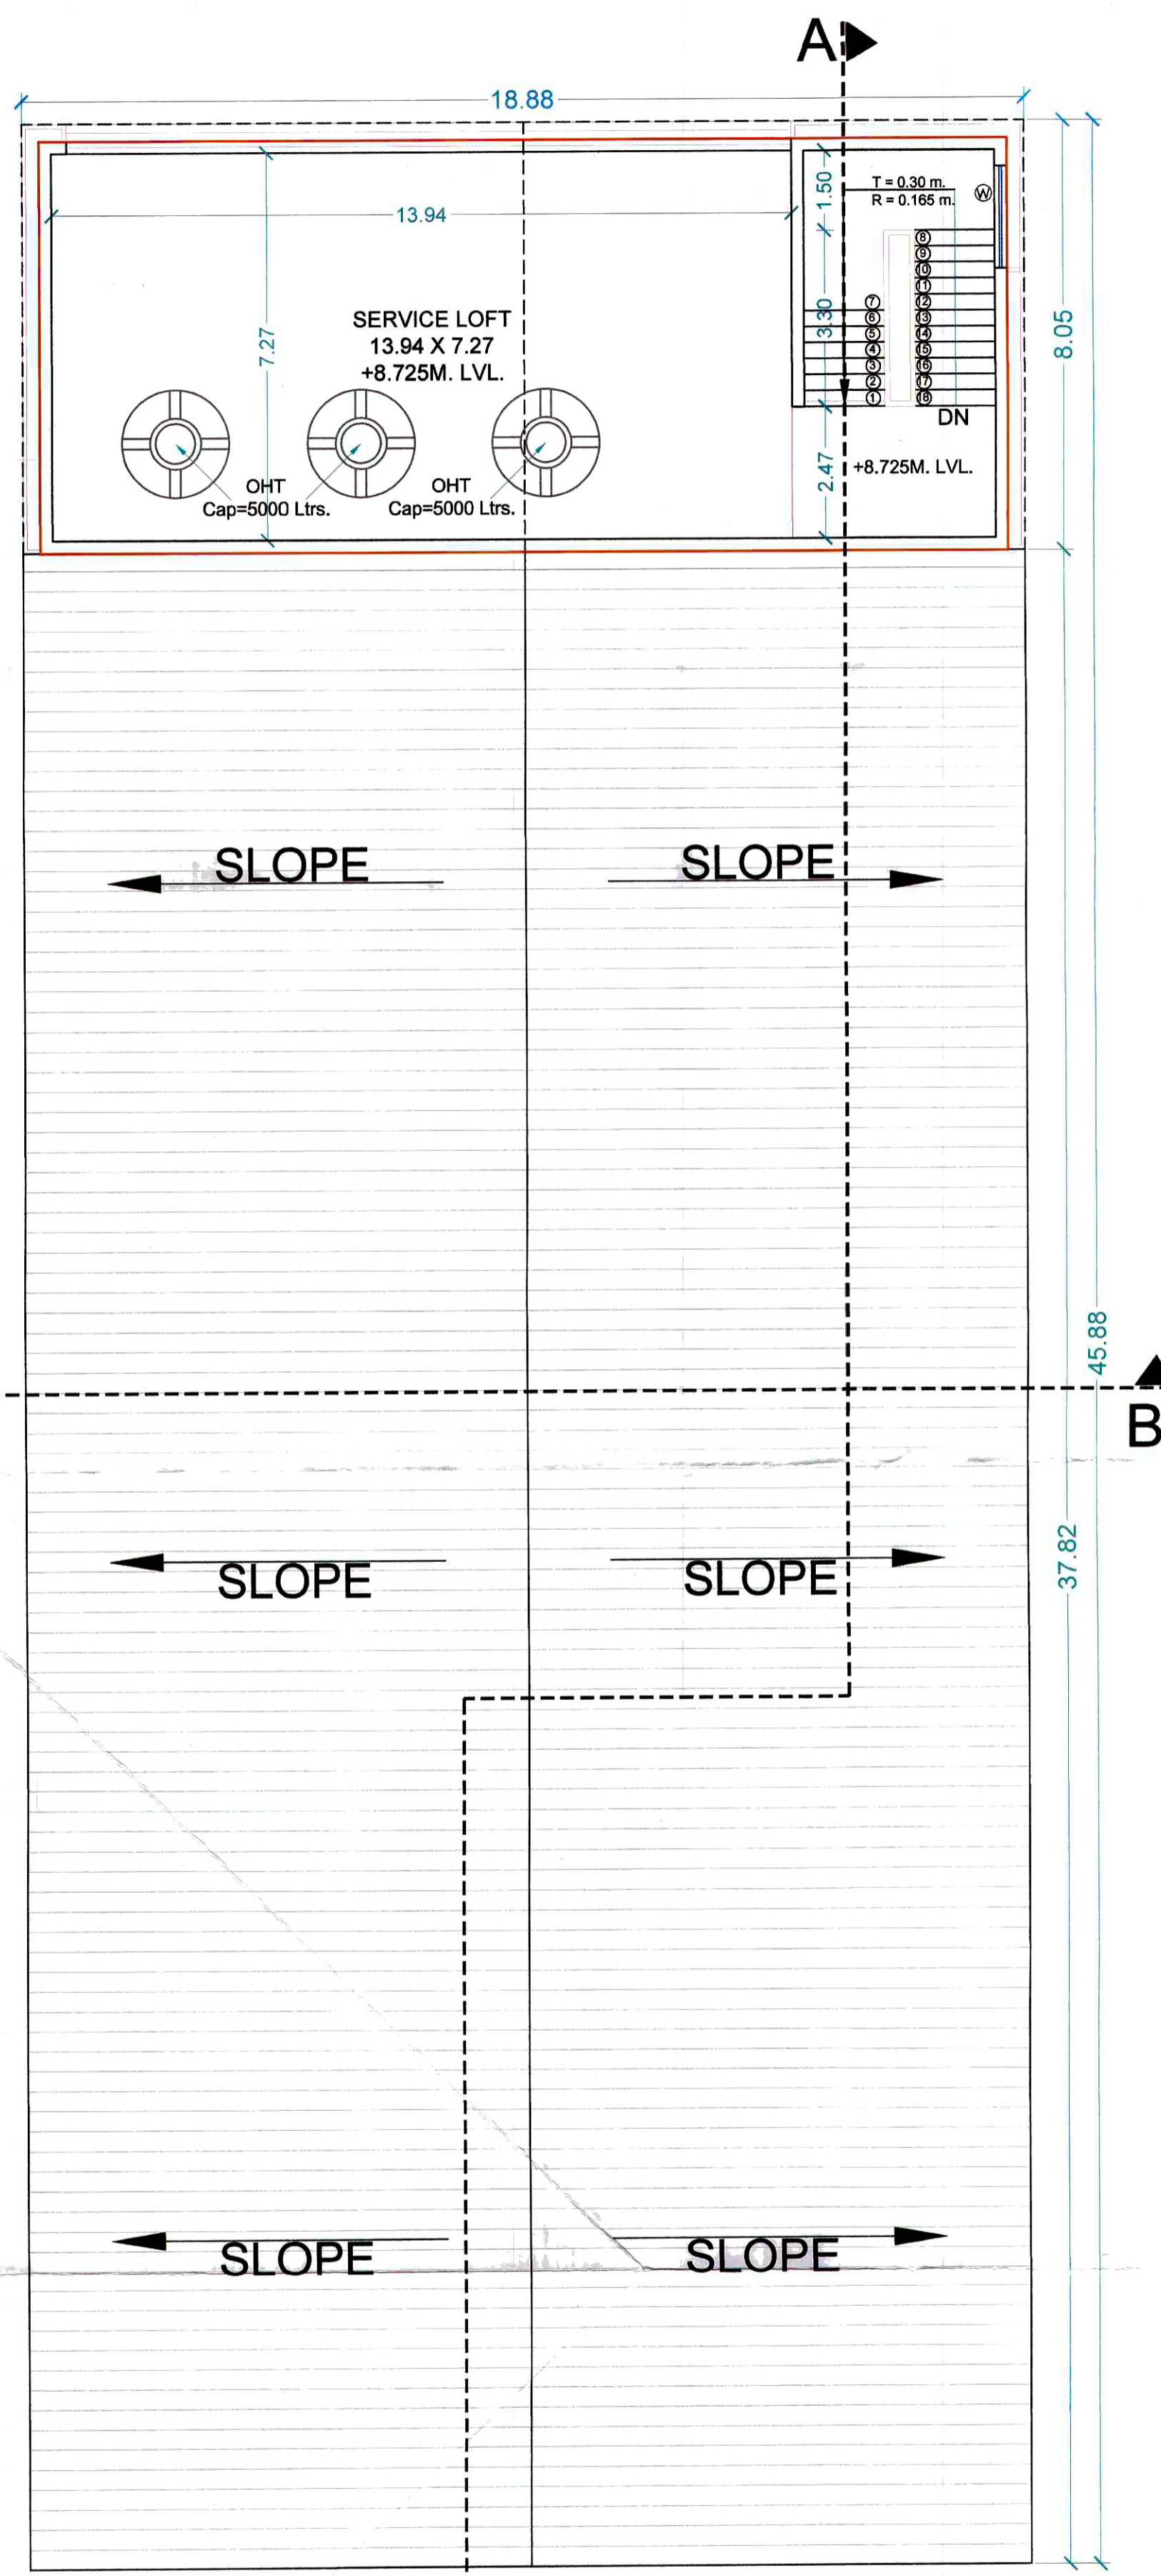TURBO VENTILATOR



ROOF PLAN
SCALE - 1:100

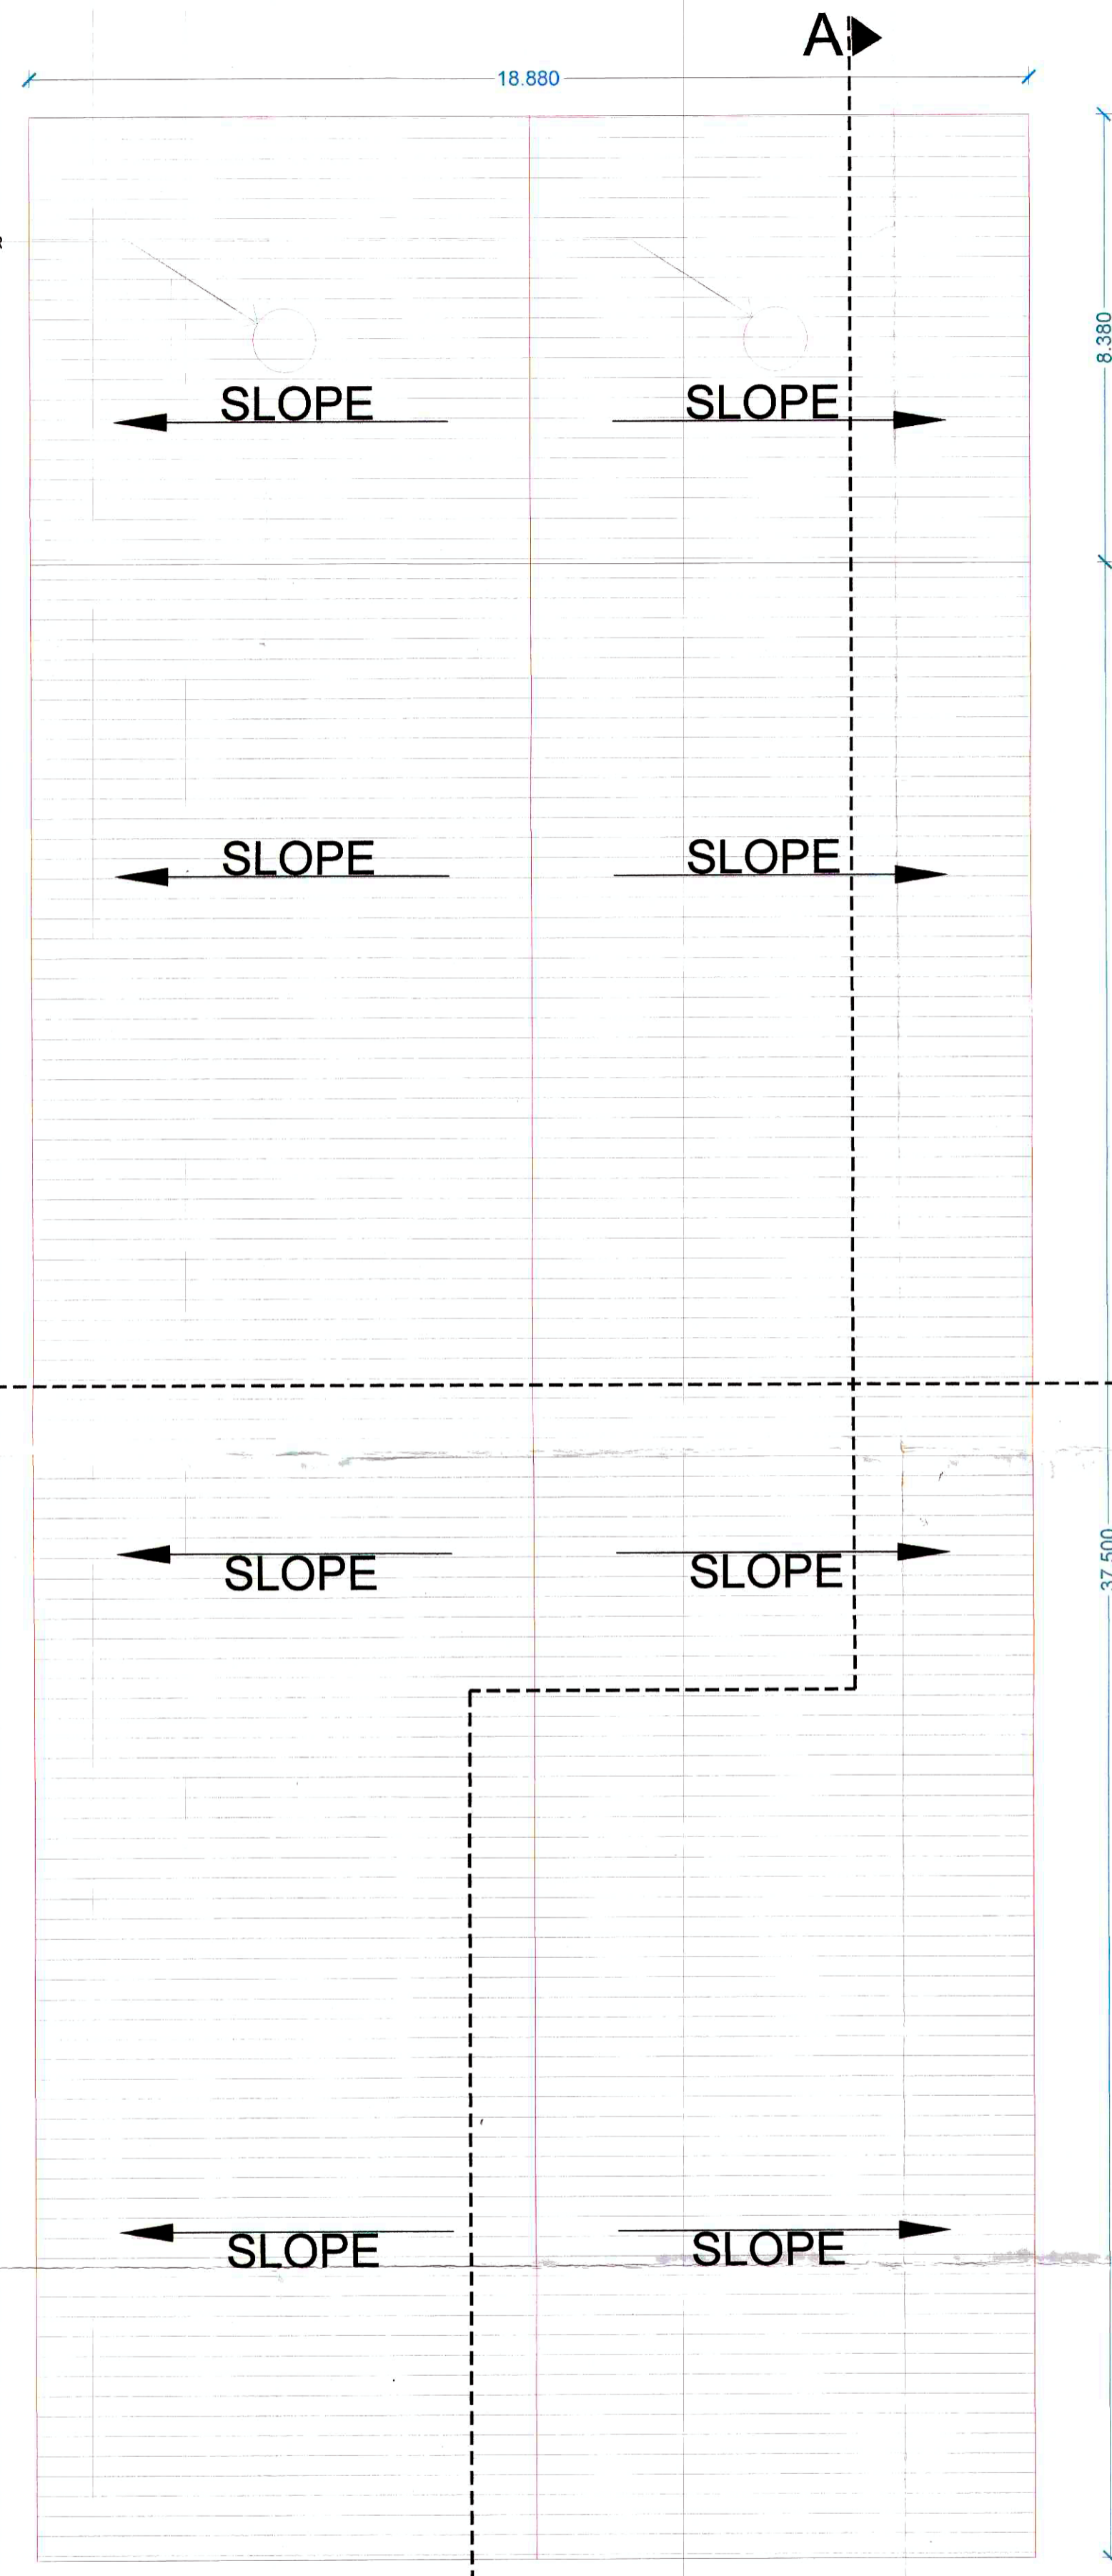TYPE	SIZE		SILL	DISCRIPTION	
	LENGTH	HEIGHT			
RS1	4.50	4.50	20.25	0.00	ROLLING SHUTTER
RS2	1.94	2.85	5.53	0.00	ROLLING SHUTTER
RS3	2.00	2.85	5.70	0.00	ROLLING SHUTTER
RS4	1.40	2.40	3.36	0.00	ROLLING SHUTTER
W	1.20	2.40	2.88	0.90	AL - SLIDING WINDOW
W1	1.85	0.60	1.11	1.00	AL - SLIDING WINDOW
V	0.60	0.90	0.54	2.30	LOUVERED WINDOW
V2	2.30	0.90	2.07	2.30	LOUVERED WINDOW
D1	1.05	2.10	2.21	0.00	TW PANEL DOOR
D2	1.20	2.10	2.52	0.00	TW PANEL DOOR
D3	1.50	2.10	3.15	0.00	TW PANEL DOOR
D4	0.85	2.10	1.79	0.00	TW PANEL DOOR
D5	0.90	2.10	1.89	0.00	TW PANEL DOOR
D6	0.75	2.10	1.58	0.00	FLUSH DOOR
SD1	3.00	2.10	6.30	0.00	AL - SLIDING DOOR
SD2	4.00	2.10	8.40	0.00	AL - SLIDING DOOR
PS	7.24	1.65	11.99	1.10	POLY CARBONATE SHEET



LOFT FLOOR AREA DIAGRAM [SCALE - 1:100]

LOFT FLOOR AREA CALCULATION (INDUSTRIAL)					
Description	Length	Breath	No.	Area in sqm	
Block	18.230	X	7.730	1	140.918
(A)	Total				140.918

DETAILS OF BUILT UP AREA OF INDUSTRIAL SHED				
SR.NO	BUILDING NO.	PREDOMINANT USE	NO.OF FLOORS	BUA IN SQ.M
1	Industrial Shed - 1	Industrial	Ground	824.543
			First	808.343
			Loft	140.918
TOTAL				1773.804
TOTAL BUA OF 3 SHEDS				5321.411

NOTE:- All Dimensions Are in Meter.

- SHEET CONTENT :-
- 1.LOFT FLOOR PLAN
 - 2.LOFT FLOOR AREA DIAGRAM & CALCULATION
 - 3.ROOF PLAN
 - 4.BUILT UP AREA STATEMENT
 5. DOOR & WINDOW SCHEDULE

NAME & SIGNATURE OF OWNER

MR. ANOOP SINGH SATNAM SINGH *[Signature]*

MR. TARUN SINGH ANOOP SINGH *[Signature]*

MR. RAVNEET SINGH ANOOP SINGH *[Signature]*

DESCRIPTION OF PROPOSAL & PROPERTY

PROPOSED INDUSTRIAL DEVELOPMENT ON LAND BEARING SURVEY NO.174/1, 174/2, 173/B OF VILLAGE - SHIRDHON, TALUKA - PANVEL, DIST-RAIGAD

NAME & SIGN. OF ARCHITECT

Ar. NAVNATH L. GOLE
CA/2017/85526
AR. NAVNATH L. GOLE


DATE	DRAWN BY	CHKD. BY	SCALE	
10.04.2023	JCG	NLG	1:100	NORTH

AR. NAVNATH L. GOLE
CA/2017/85526, (B. ARCH)
+ 9 1 - 8 6 6 8 9 8 2 5 4 5


SARASAWATI CHS. PLOT NO. 83
ROOM NO. 21 SECTOR - 12,
KHARGHER, NAVI MUMBAI, 410210

ADA
AD ASSOCIATES


This plans are approved subject to the conditions mentioned in commencement certificate issued by this office bearing certificate No.: CIDCO/NAINA/Panvel/Shirdhon/BP-00608/CC/2024/0478 Dated: 31 January 2024

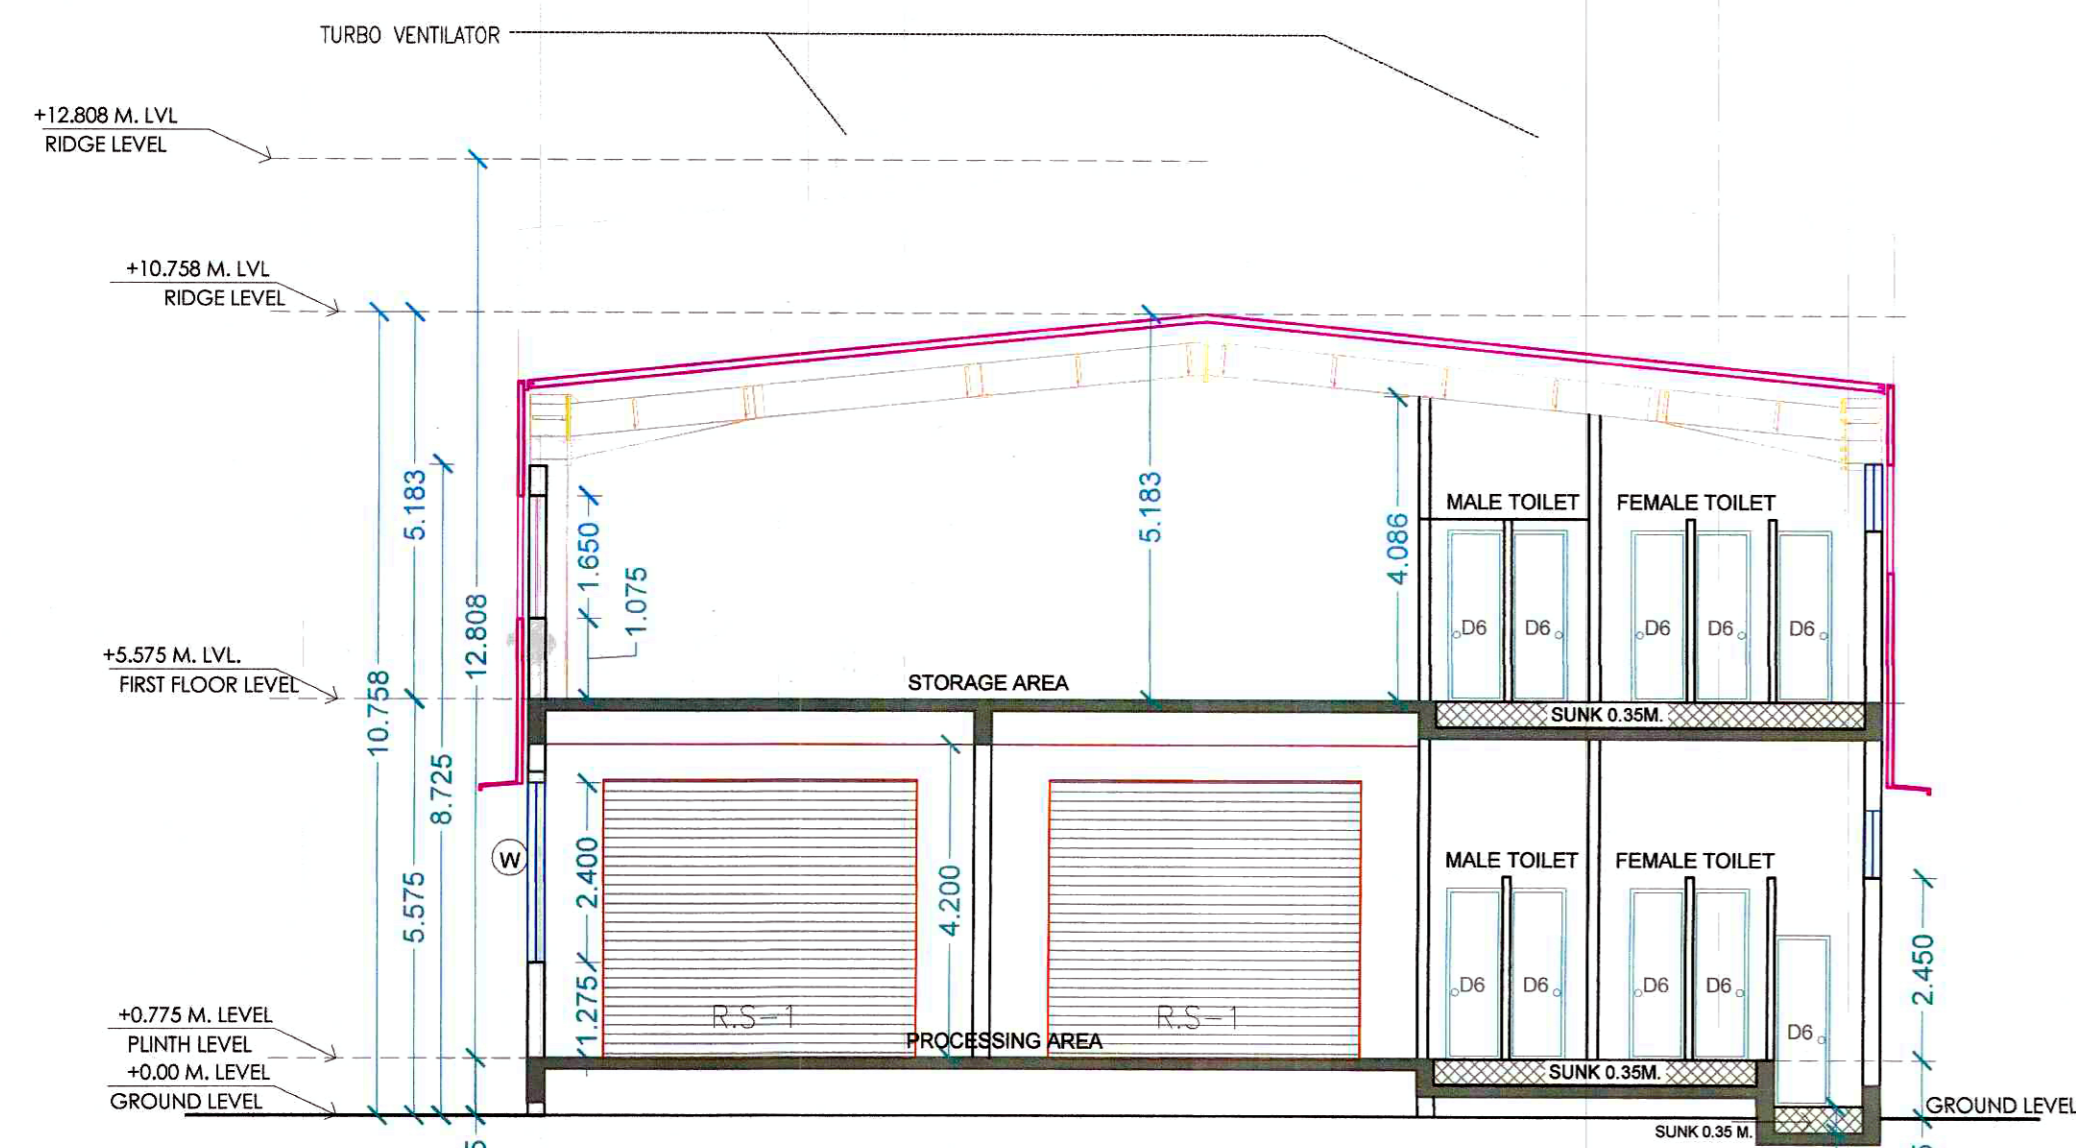


SECTION BB' SCALE - 1:100

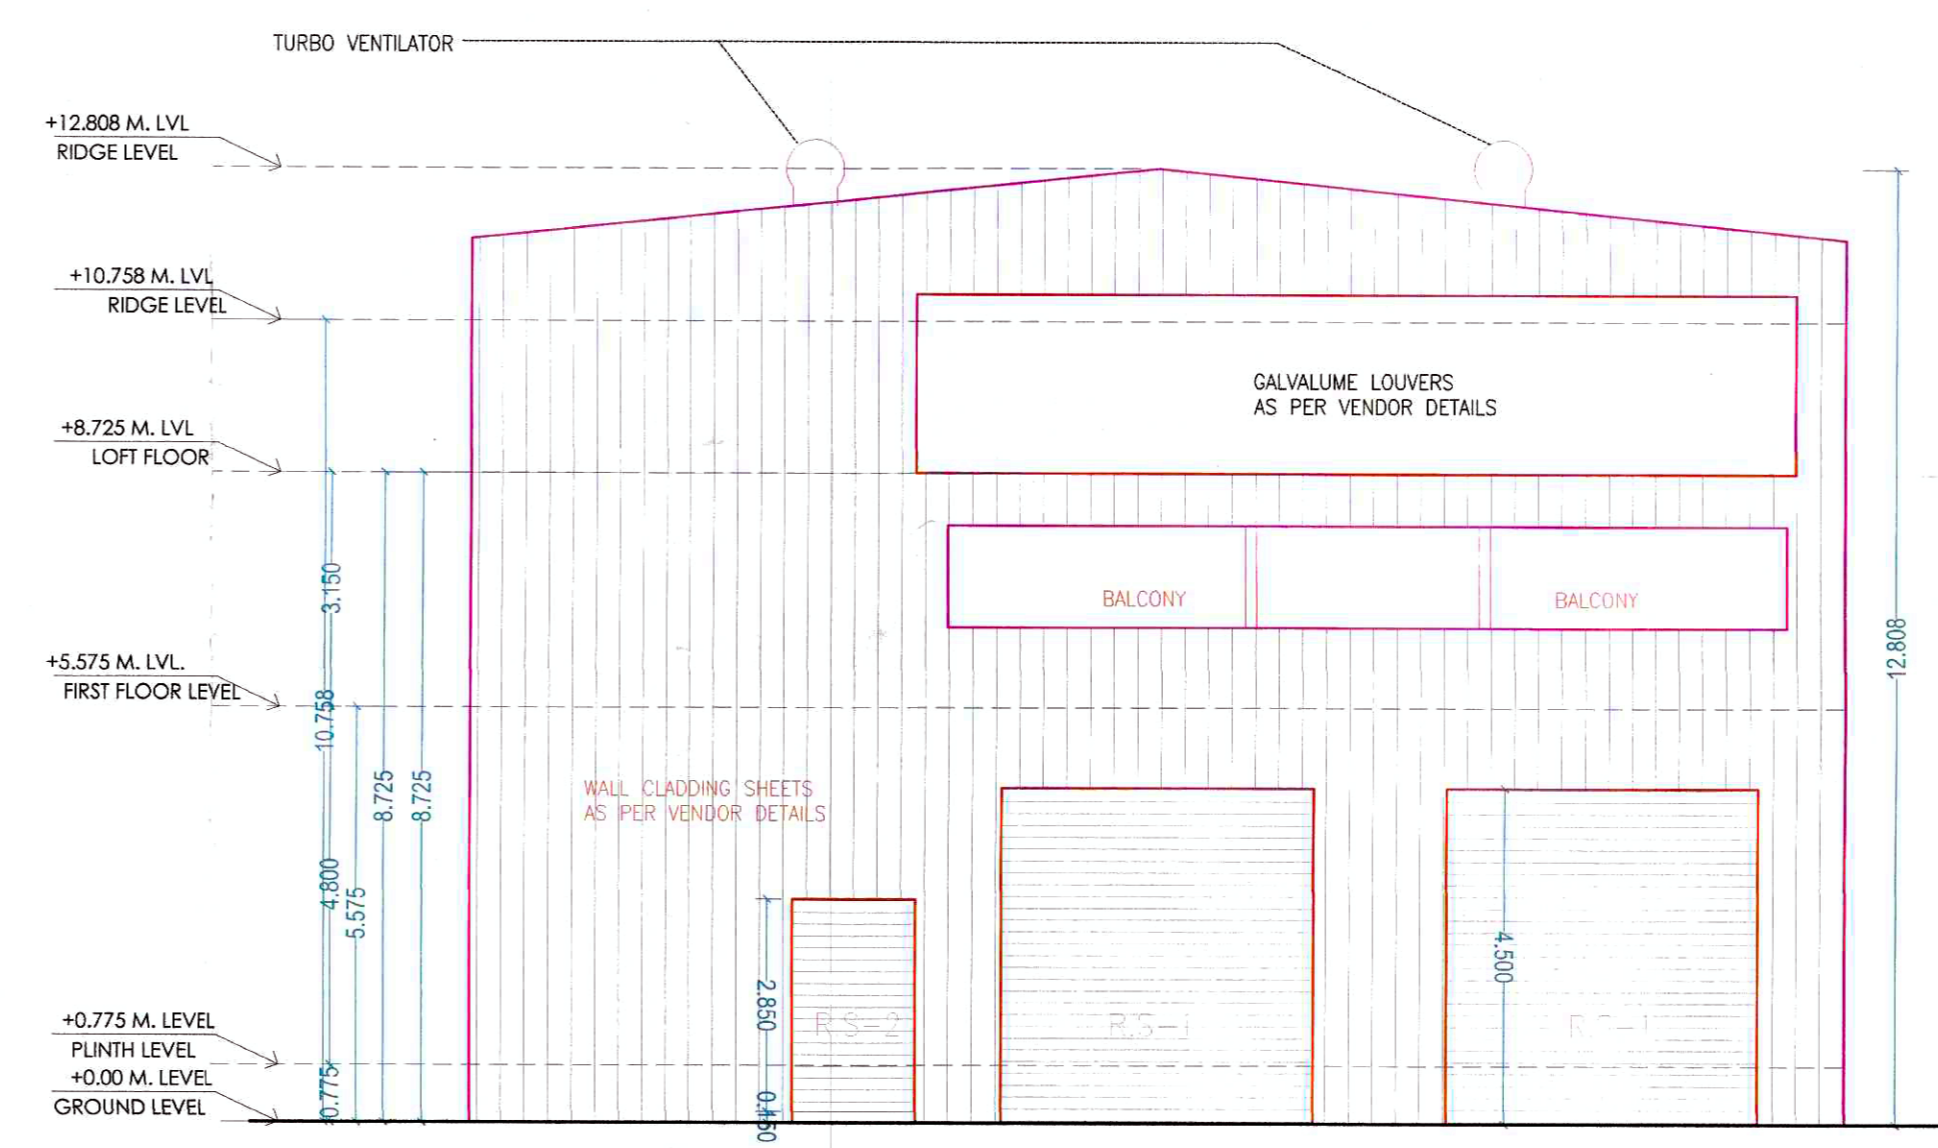

NORTH SIDE ELEVATION SCALE - 1:100

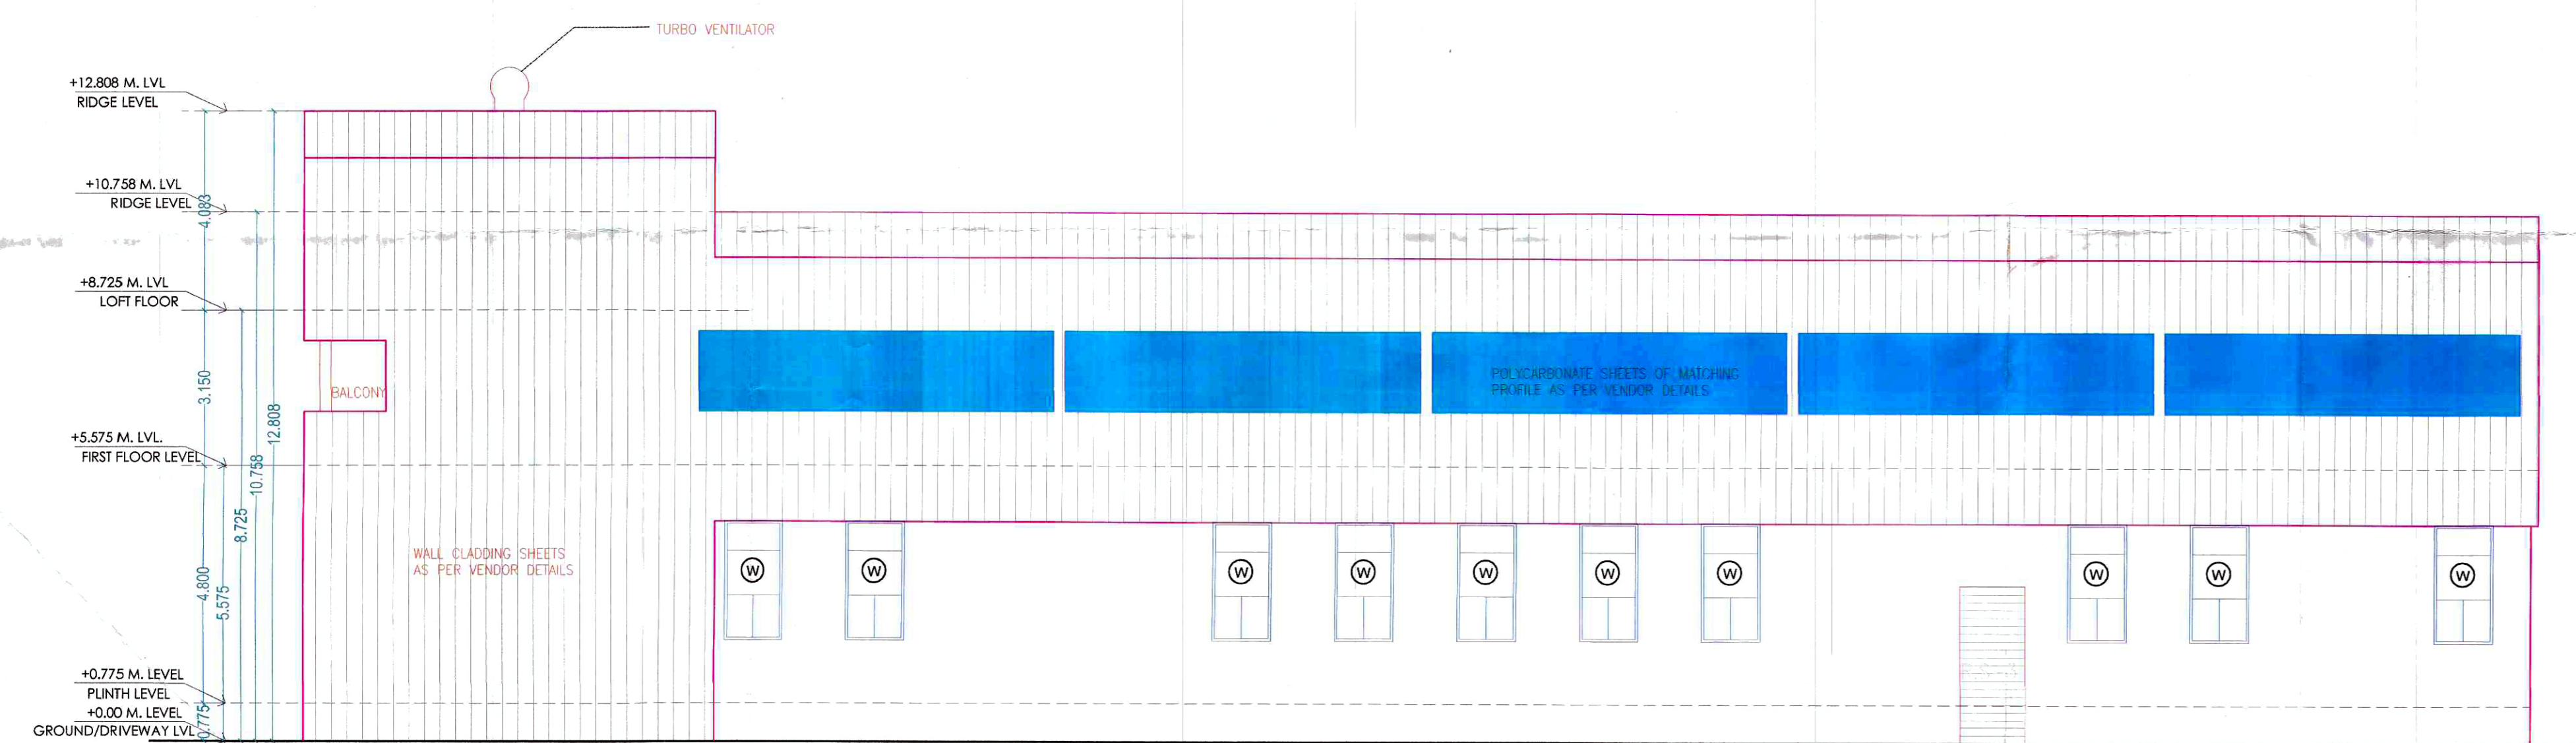

WEST SIDE ELEVATION SCALE - 1:100

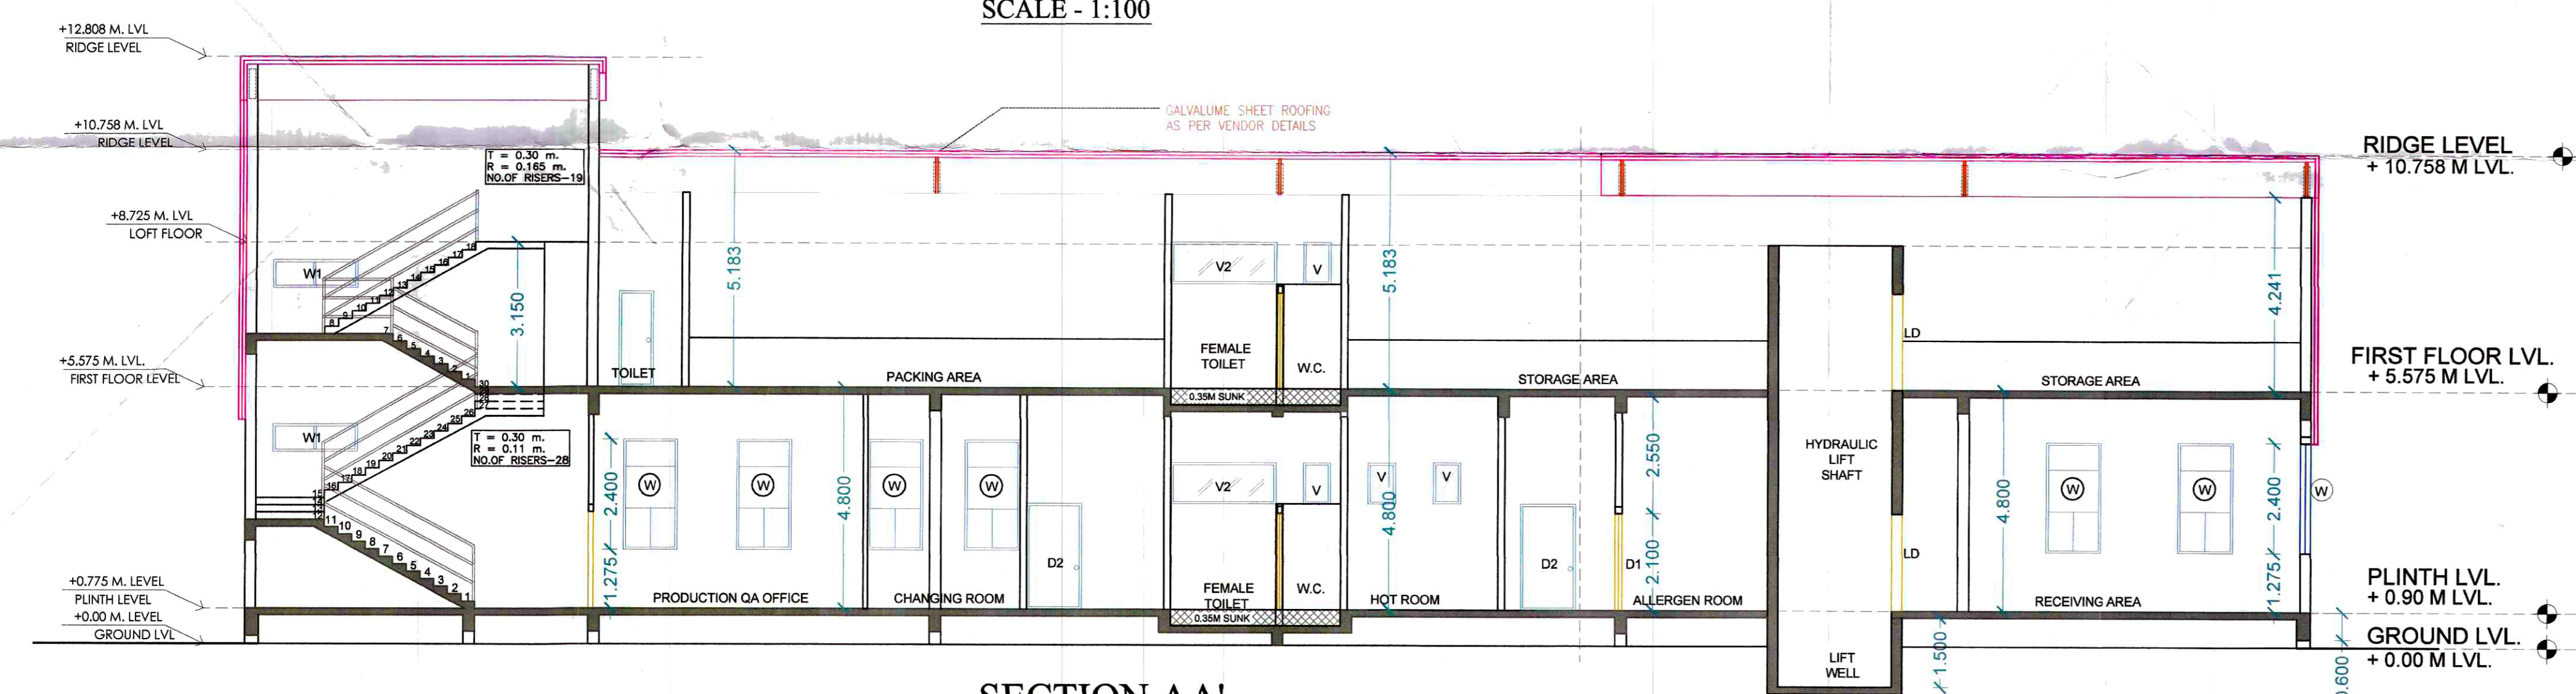

SECTION AA' SCALE - 1:100

NOTE:- All Dimensions Are in Meter.

SHEET CONTENT :-

- SECTION AA'
- SECTION AND ELEVATION
- BUILT UP AREA STATEMENT
- LIGHT AND VENTILATION SCHEDULE
- DOOR AND WINDOW SCHEDULE
- NAME & SIGNATURE OF OWNER

MR. ANOOP SINGH SATNAM SINGH *[Signature]*
 MR. TARUN SINGH ANOOP SINGH *[Signature]*
 MR. RAVNEET SINGH ANOOP SINGH *[Signature]*

DESCRIPTION OF PROPOSAL & PROPERTY

PROPOSED INDUSTRIAL DEVELOPMENT ON LAND BEARING SURVEY NO. 174/1, 174/2, 173/B OF VILLAGE - SHIRDHON, TALUKA - PANVEL, DIST-RAIGAD

NAME & SIGN. OF ARCHITECT

[Signature]
Ar. NAVNATH GOLE
CA/2017/85526
 AR. NAVNATH L. GOLE

DATE	DRAWN BY	CHKD BY	SCALE	NORTH
10.04.2023	JOG	NLG	1:100	

AR. NAVNATH L. GOLE CA/2017/85526. (B.A.RCH) + 91 - 8 6 6 8 9 8 2 5 4 5

SARASWATI CHS PLOT NO. 83 ROOM NO. 21 S. SECTOR - 12 KHARGHER, NAVI MUMBAI. 410210

